




- UTILITY STATEMENT: THE UNDERGROUND UTILITIES SHOWN (IF ANY) HAVE BEEN LOCATED FROM COUNTY GIS INFORMATION, EXISTING DRAWINGS & FIELD SURVEY INFORMATION. THE SURVEYOR MAKES NO GUARANTEE THAT THE UTILITIES SHOWN COMPRISE ALL SUCH UTILITIES IN THE AREA, EITHER IN SERVICE OR ABANDONED, OR THAT THE UNDERGROUND UTILITIES SHOWN ARE IN THE EXACT LOCATION INDICATED. HE DOES CERTIFY THAT THEY ARE LOCATED AS ACCURATELY AS POSSIBLE FROM INFORMATION AVAILABLE. THE SURVEYOR HAS NOT PHYSICALLY LOCATED THE UNDERGROUND UTILITIES.
- 11. COUNTY PARCEL #R04000-001-012-000.
- 12. TOTAL SITE AREA: 65.47± ACRES
- 13. MAP & DEED REFERENCES SHOWN PER THE NEW HANOVER COUNTY REGISTRY.

CURVE C1 N 82"22'39" E	<u>CHORD BEARING CHORD LENGTH DELTA ANGLE RADIUS ARC LENGTH</u> <u>S 15'02'33" E 473.29' 9'47'57" 2770.70 473.87'</u>	UOB NO: 19–1089 NCGS MONUMENT "QUEENSBORO" N: 194,535.81 E: 2,313,799.37 NCGS	$\begin{array}{c c c c c c c c c c c c c c c c c c c $
	(IIIC) ES OUN HUNON		PREPARED FOR:No.RevisionDoTHE MCADAMS COMPANY2905 MERIDIAN PARKWAY2905 MERIDIAN PARKWAYDURHAM, NC 27713DURHAM, NC 27713PH: (910) 361-5000Mo.The second secon
	SYMBOL LEGEND:         ○ <sub>EI*</sub> EXISTING IRON *PIPE / *ROD         ● RBS         REBAR SET         ● ECM         EXISTING CONCRETE MONUMENT         ● GUY WIRE ANCHOR         ● EXISTING NCGS MONUMENT         ● EXISTING NCGS MONUMENT         ● WATER METER         ● WATER VALVE         ● IRRIGATION CONTROL VALVE         ● SEWER MANHOLE         ● SEWER MANHOLE         ● 20.8' GROUND SHOT ELEVATION         ● VENT             WOOD BOLLARD		BOUNDARY AND TOPOGRAPHIC SURVEY
	Image: Constraint of the sector of the se	C) LEVATION	CAPE FEAR SOCCERPLEX Cape Fear Township New Hanover County North Carolina
	ABBRE VIATIONS:       MHSD       STORM DRAIN         EIP       EXISTING IRON PIPE       MHSD       STORM DRAIN         EIR       EXISTING IRON ROD       N/F       NOW OR FORM         RBS       REBAR SET       MB       MAP BOOK /         NCGS       NORTH CAROLINA GEODETIC SURVEY       DB       DEED BOOK         INV       INVERT       PG       PAGE         MHSS       SEWER MANHOLE       EL.       ELEVATION         RCP       REINFORCED CONCRETE PIPE       DI       DROP INLET	MERLY	ATLANTIC COAST SURVEY, PLLC P-0822 PO Box 12588 Wilmington, NC 28405 (910) 292-4889 www.atlanticcoastsurvey.com

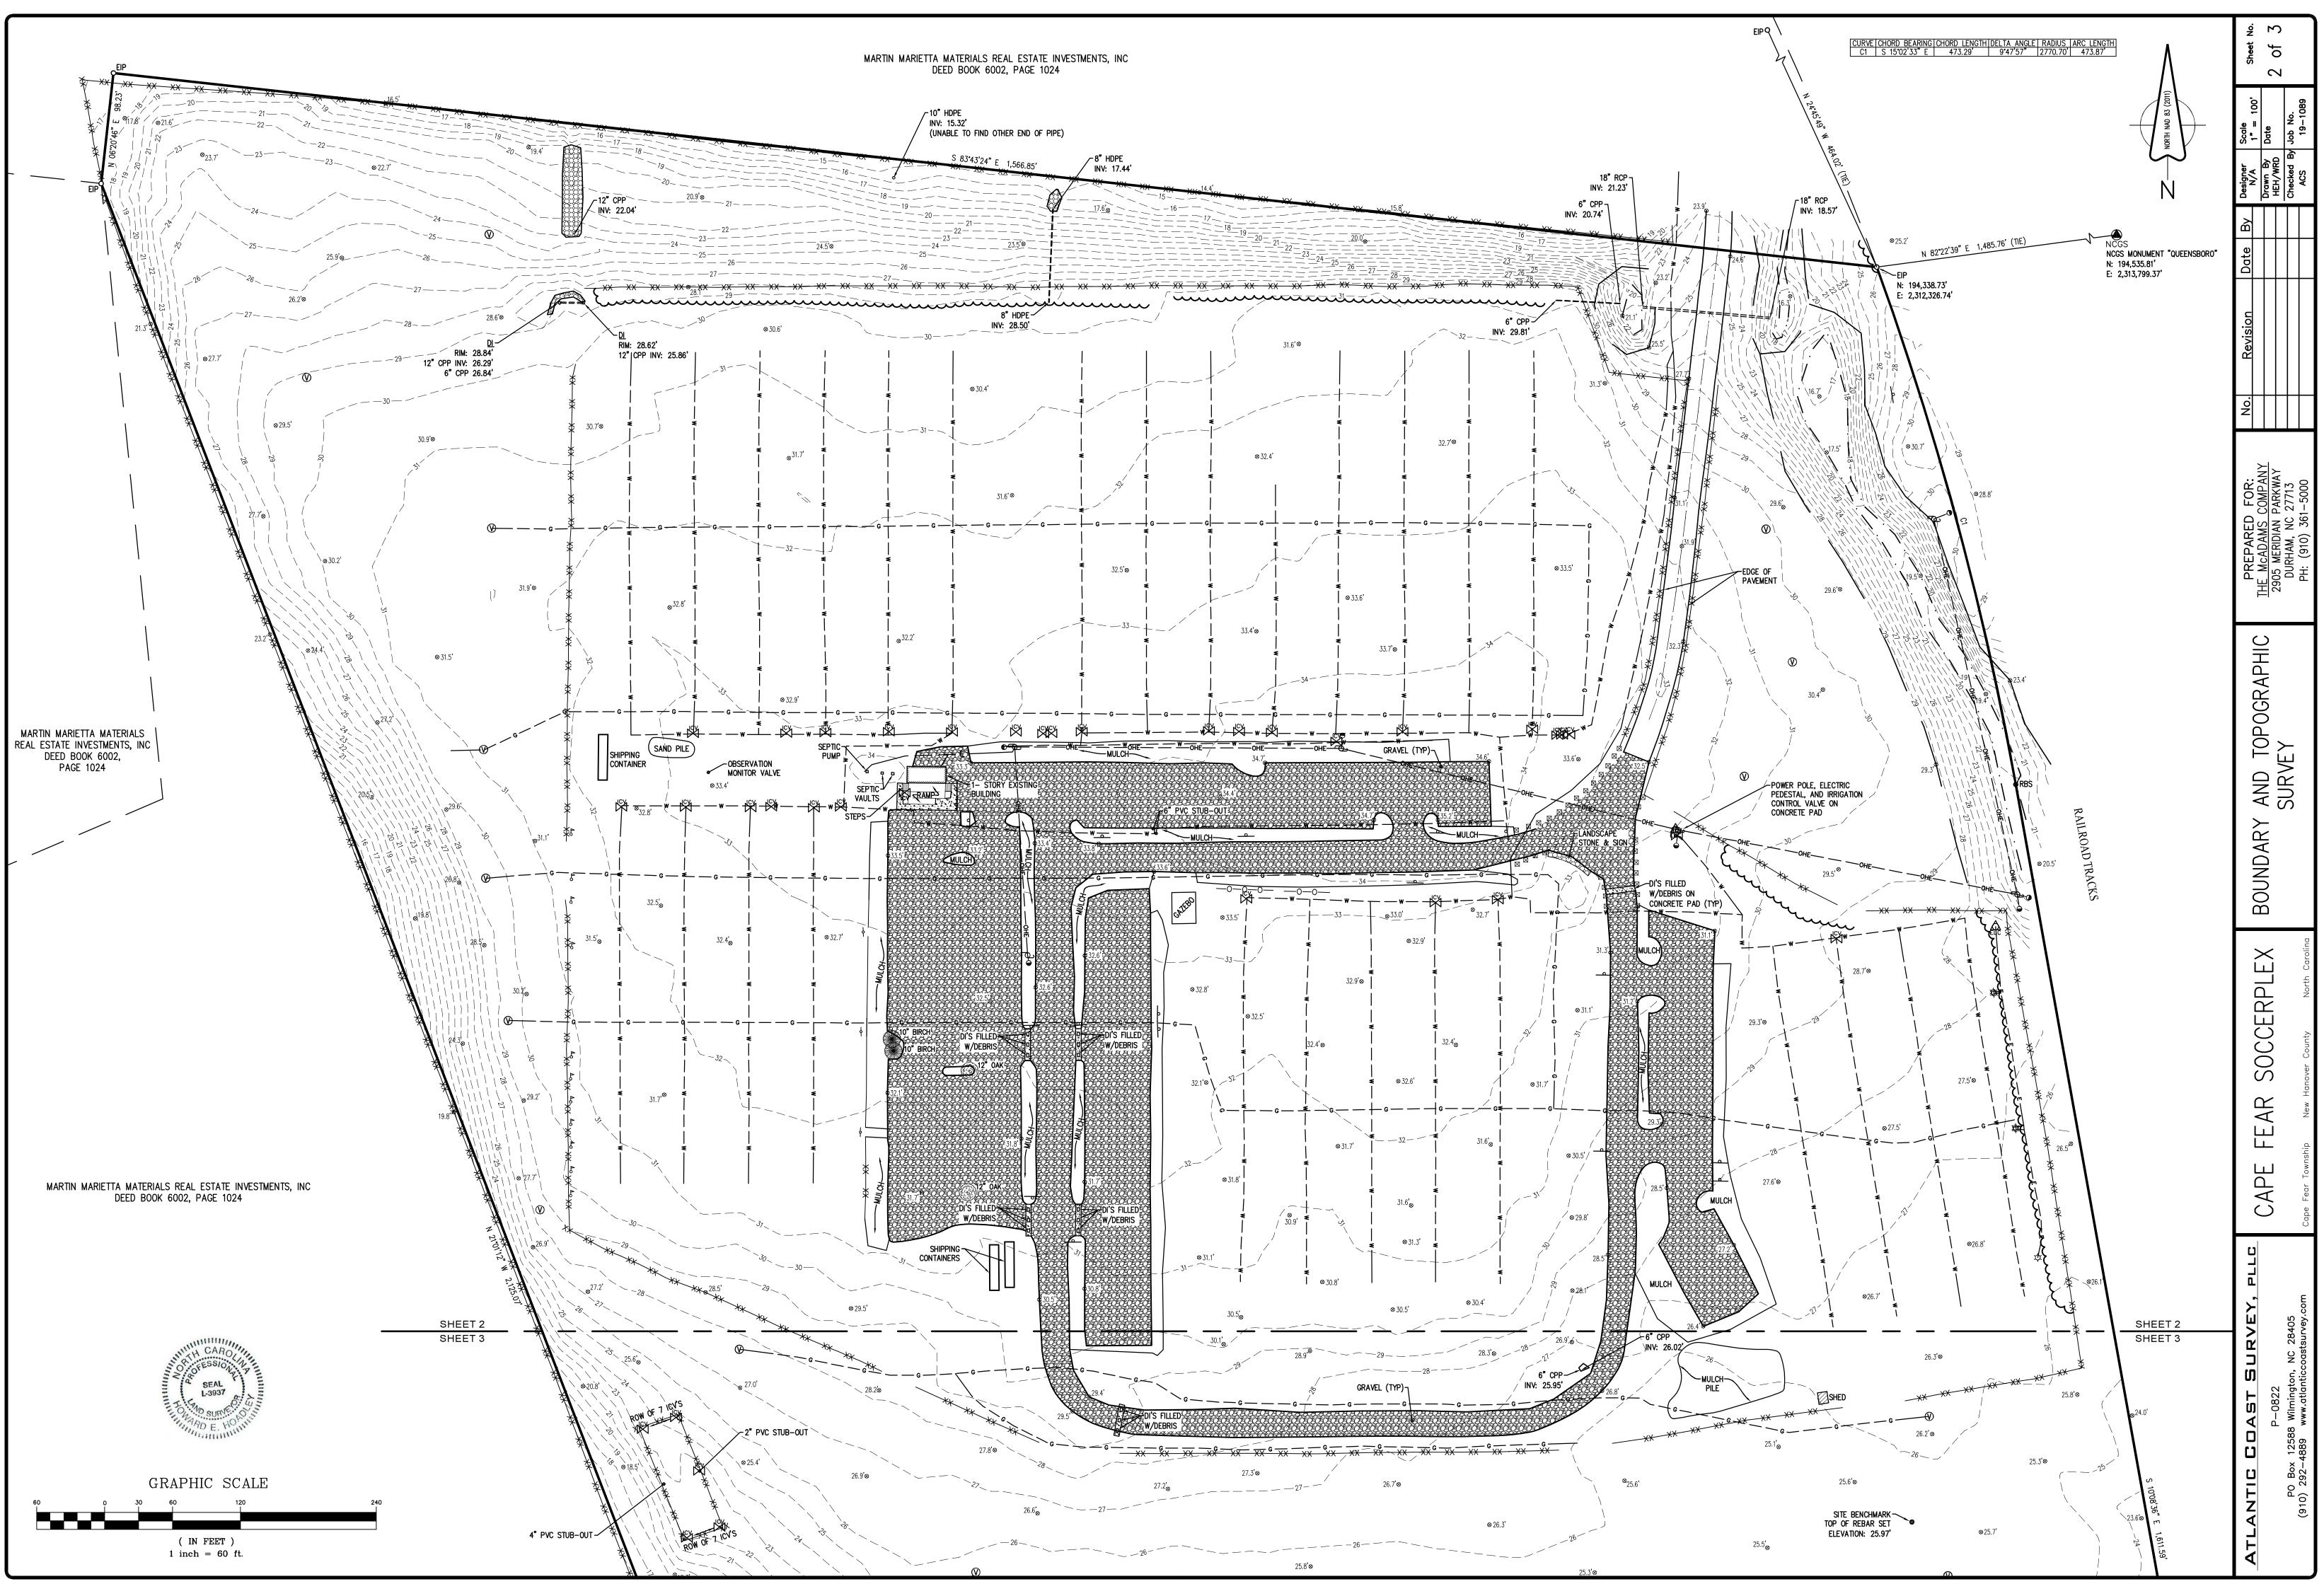

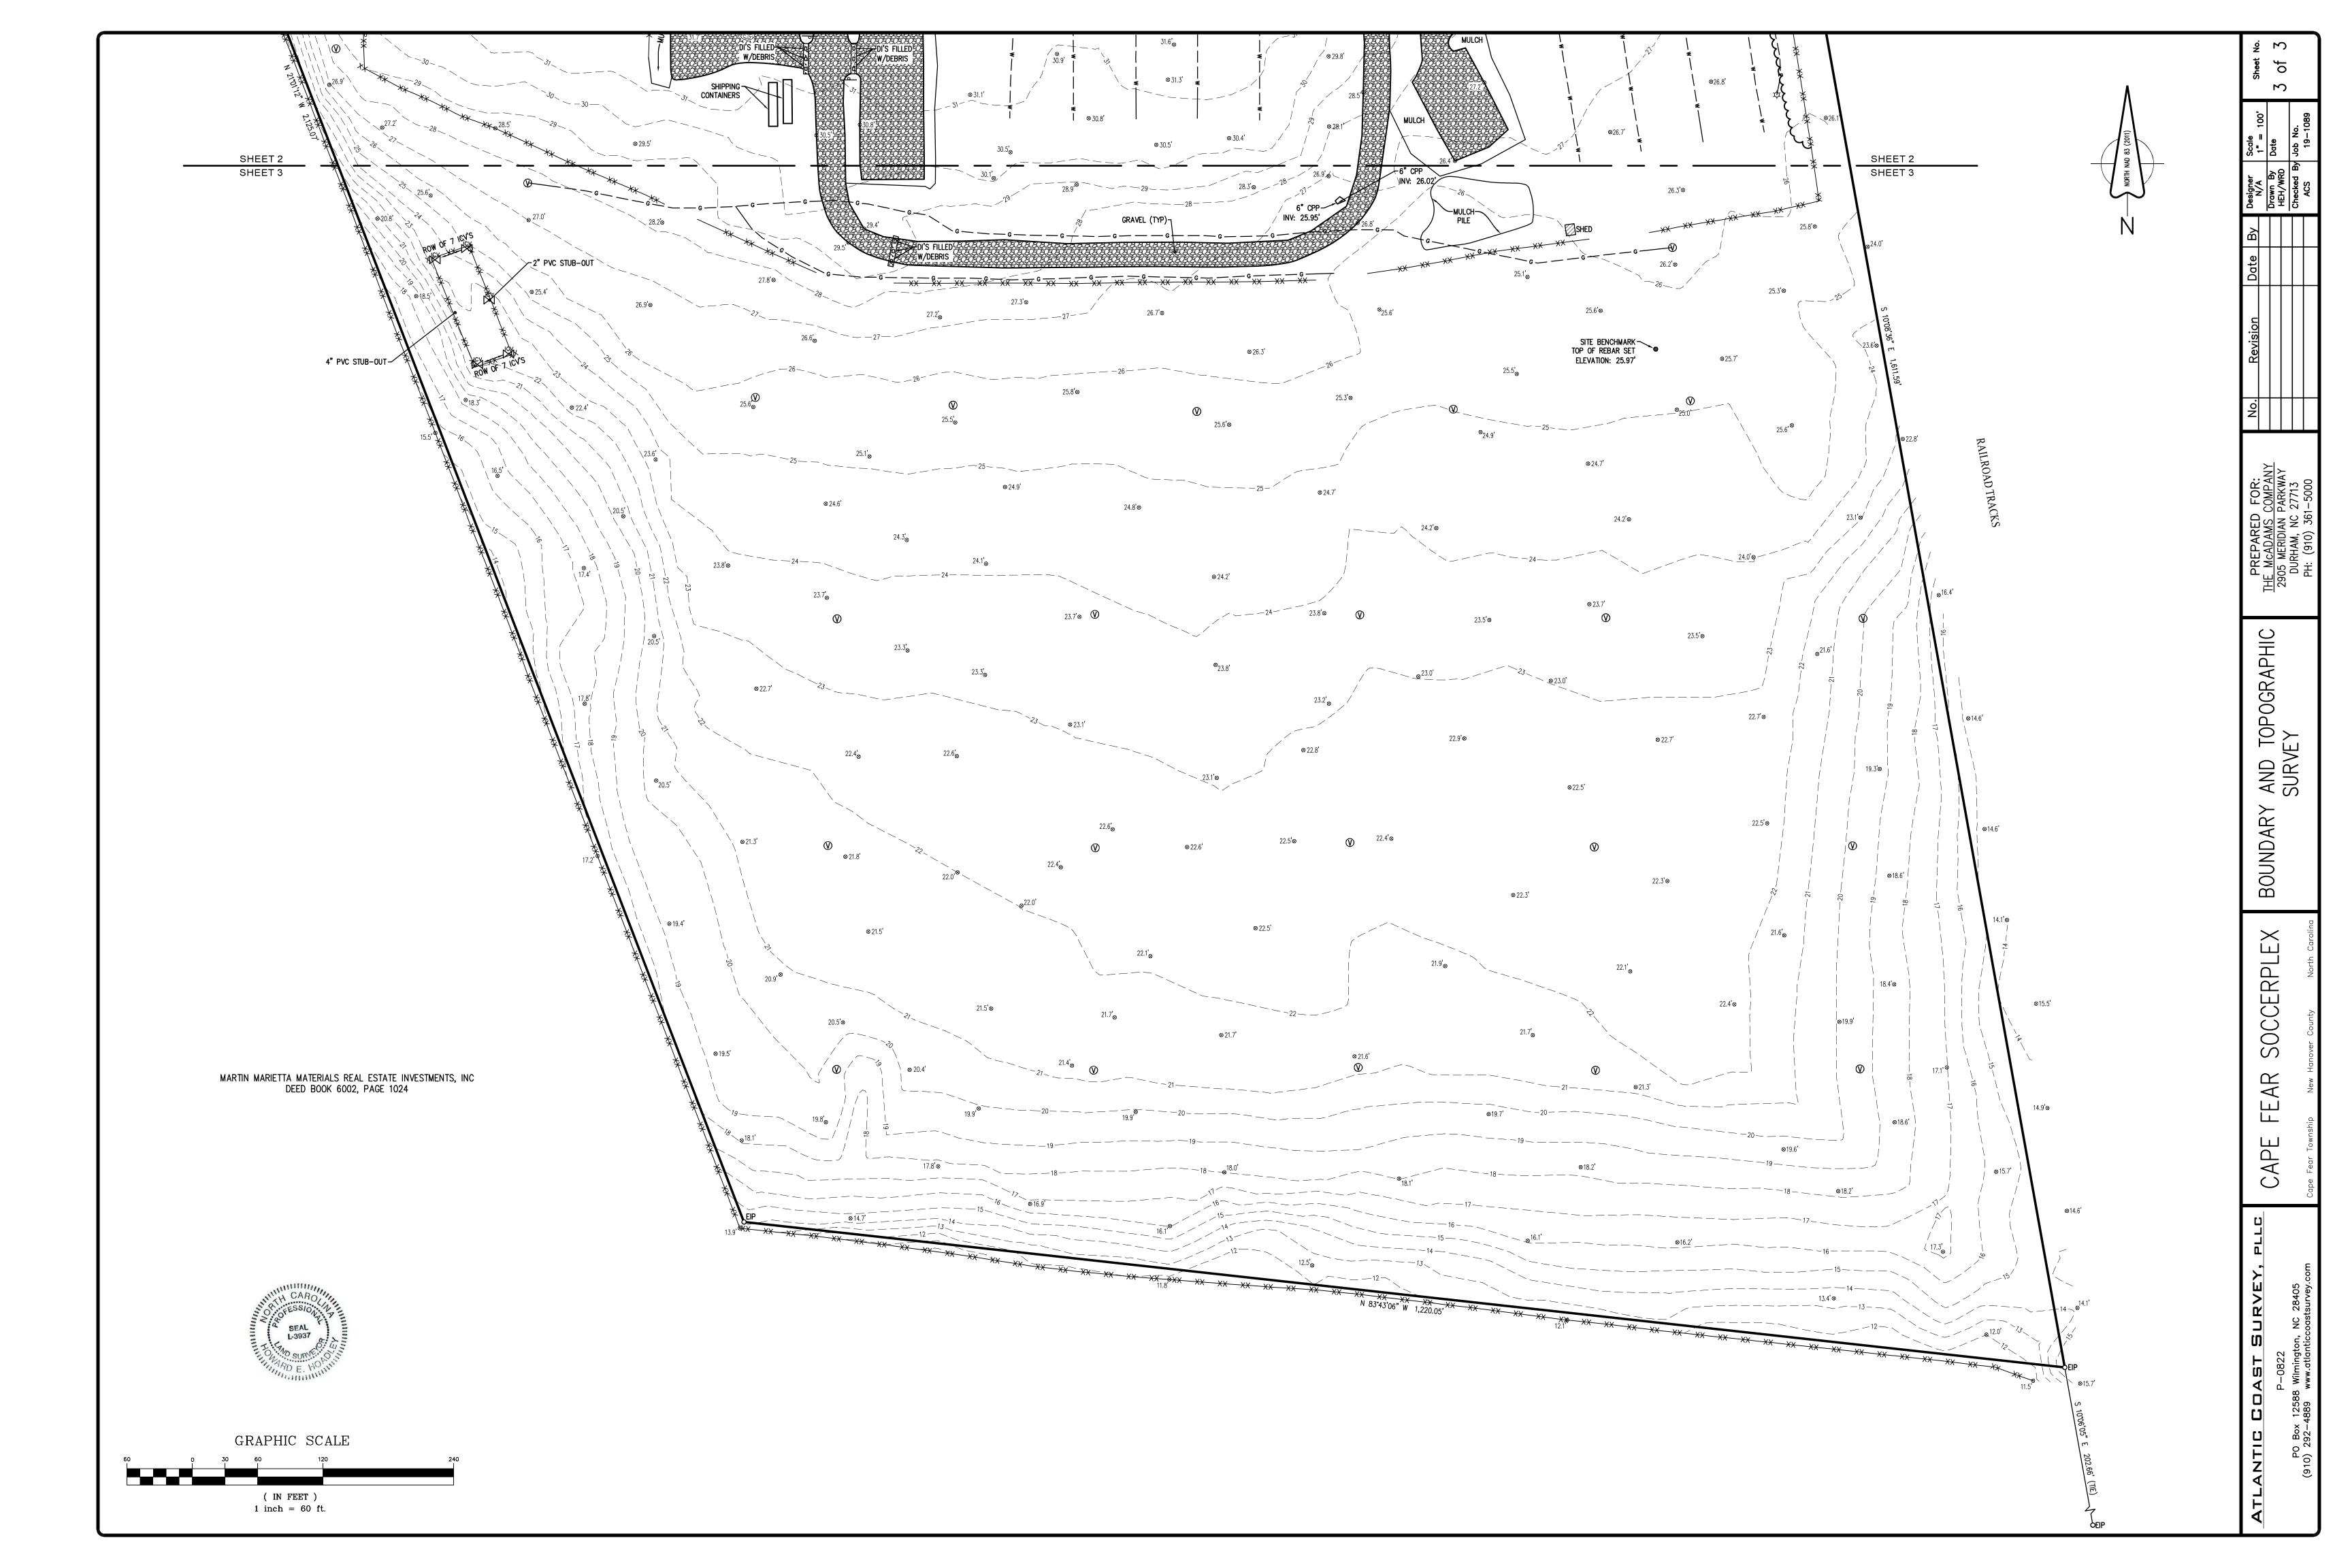

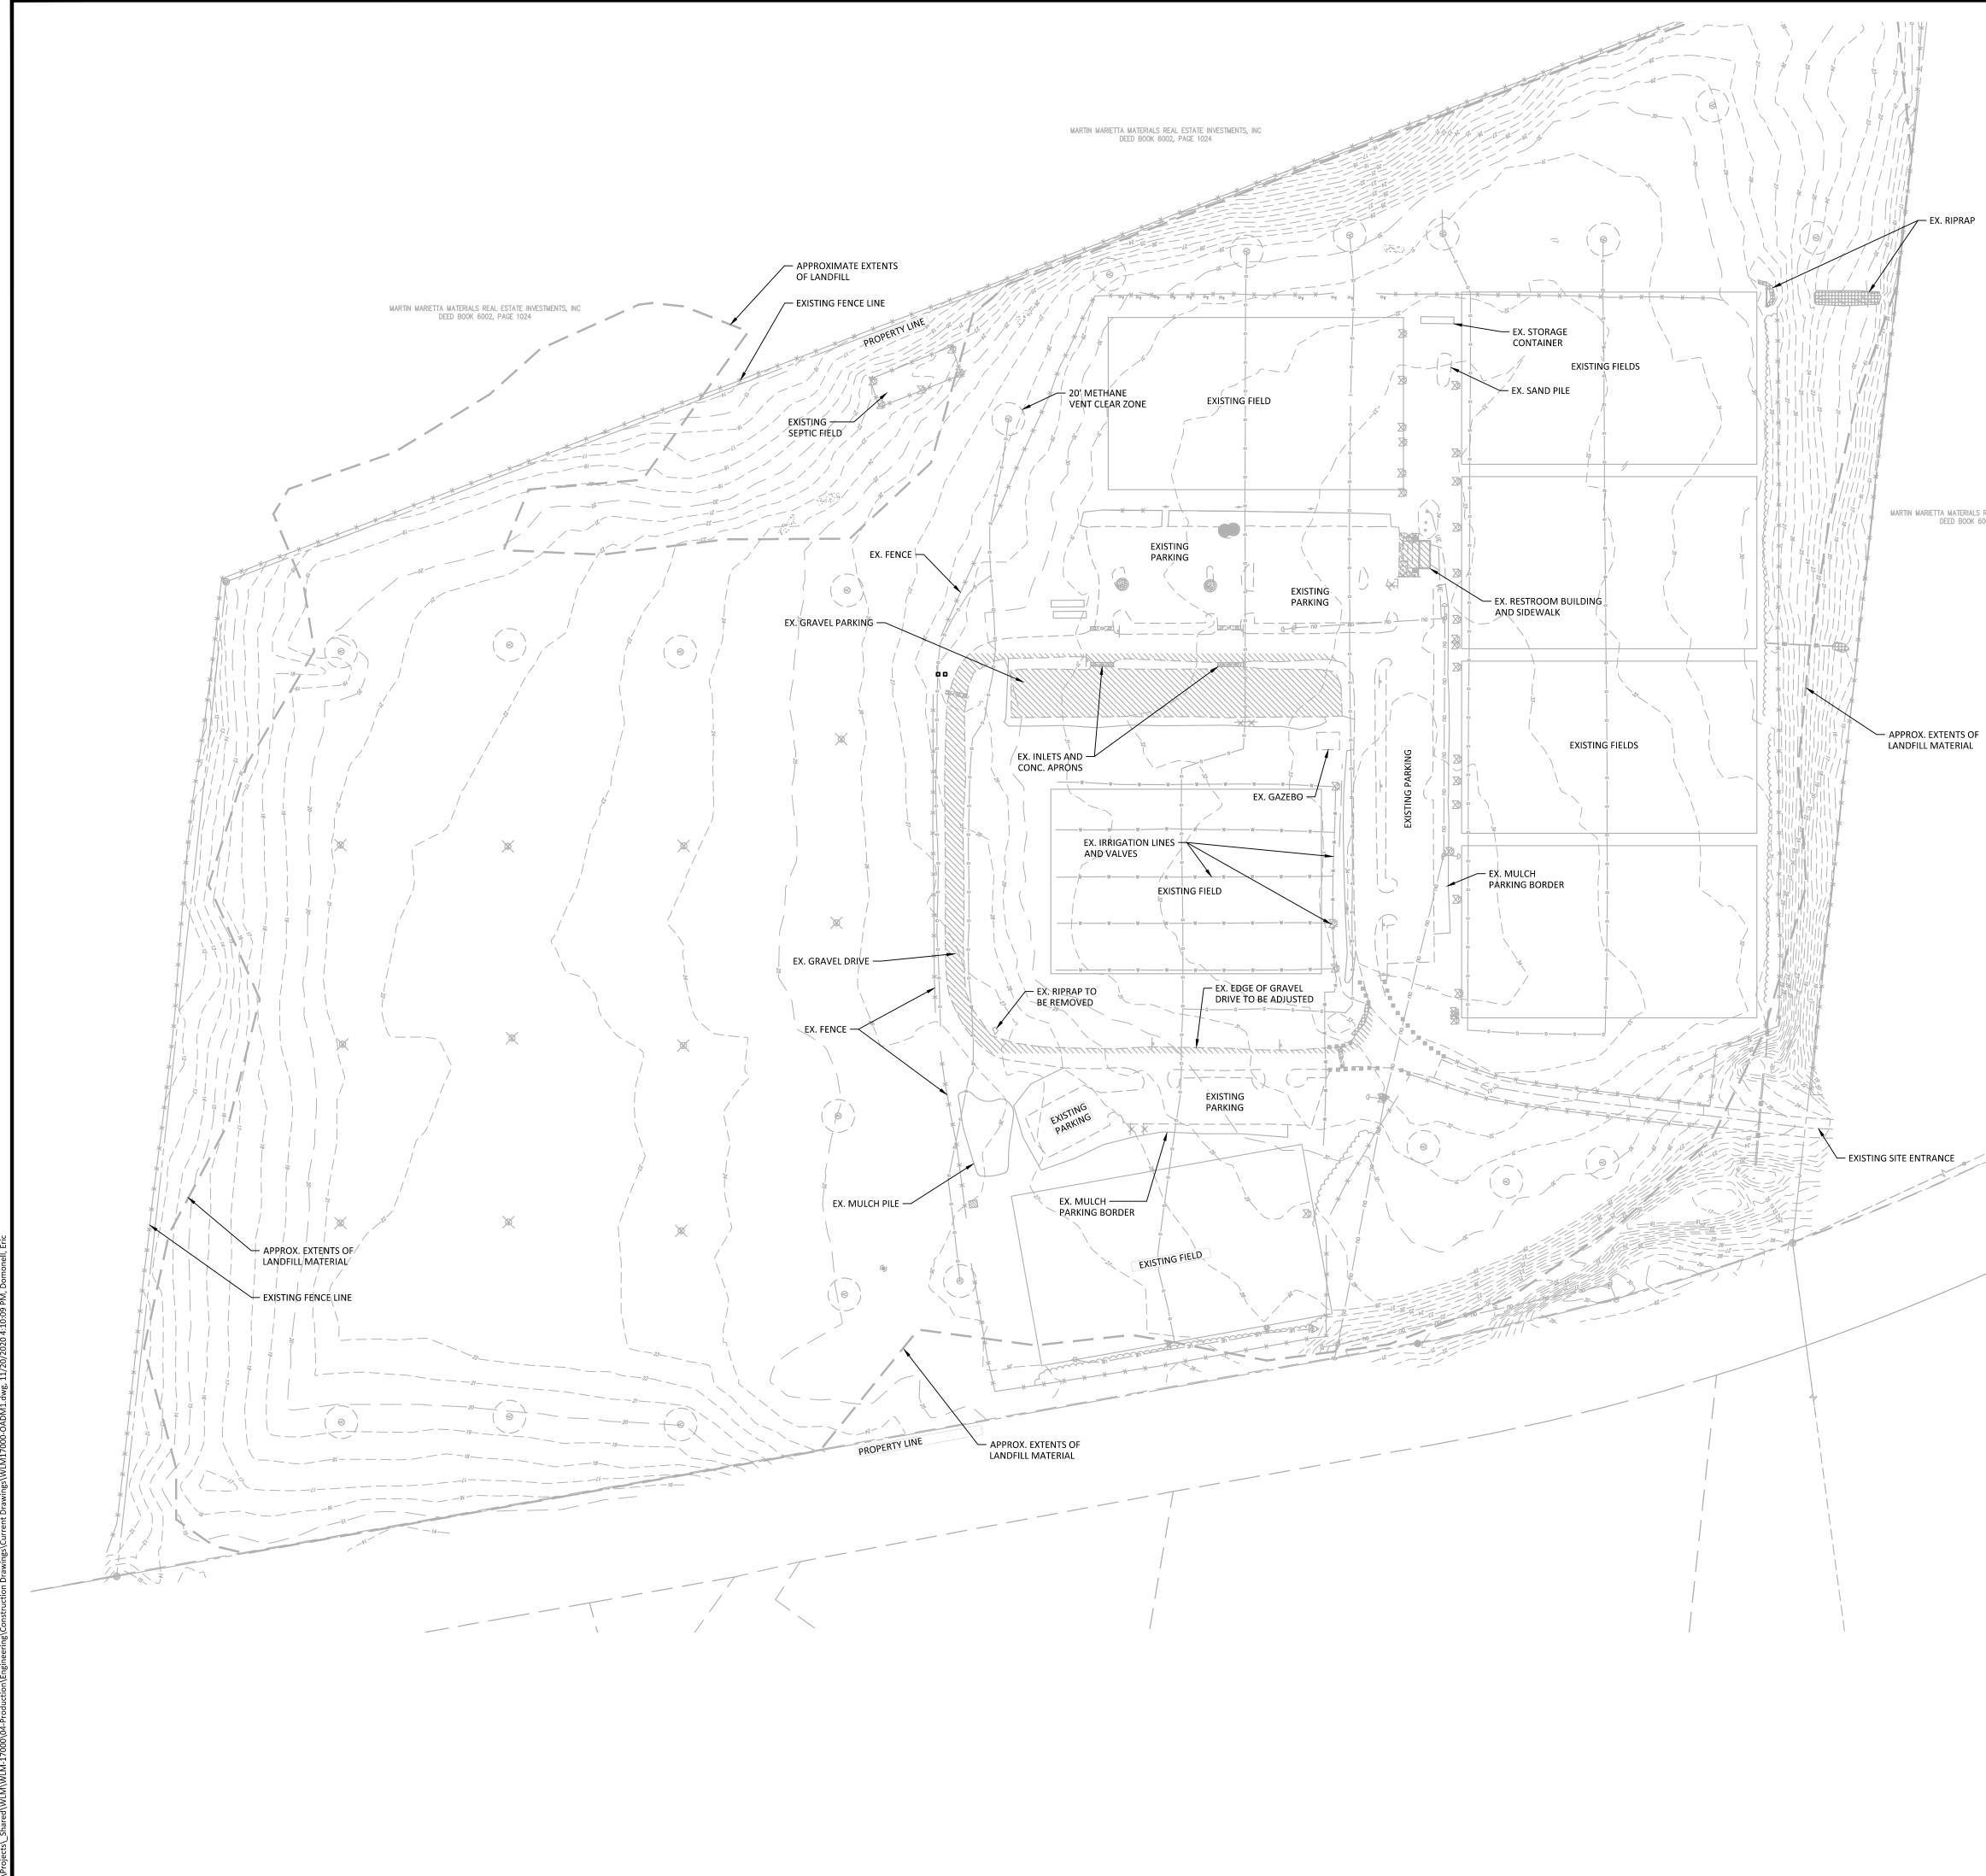



## MARTIN MARIETTA MATERIALS REAL ESTATE INVESTMENTS, INC DEED BOOK 6002, PAGE 1024





The John R. McAdams Company, Inc. 2905 Meridian Parkway Durham, NC 27713

phone 919. 361. 5000 fax 919. 361. 2269 license number: C-0293, C-187

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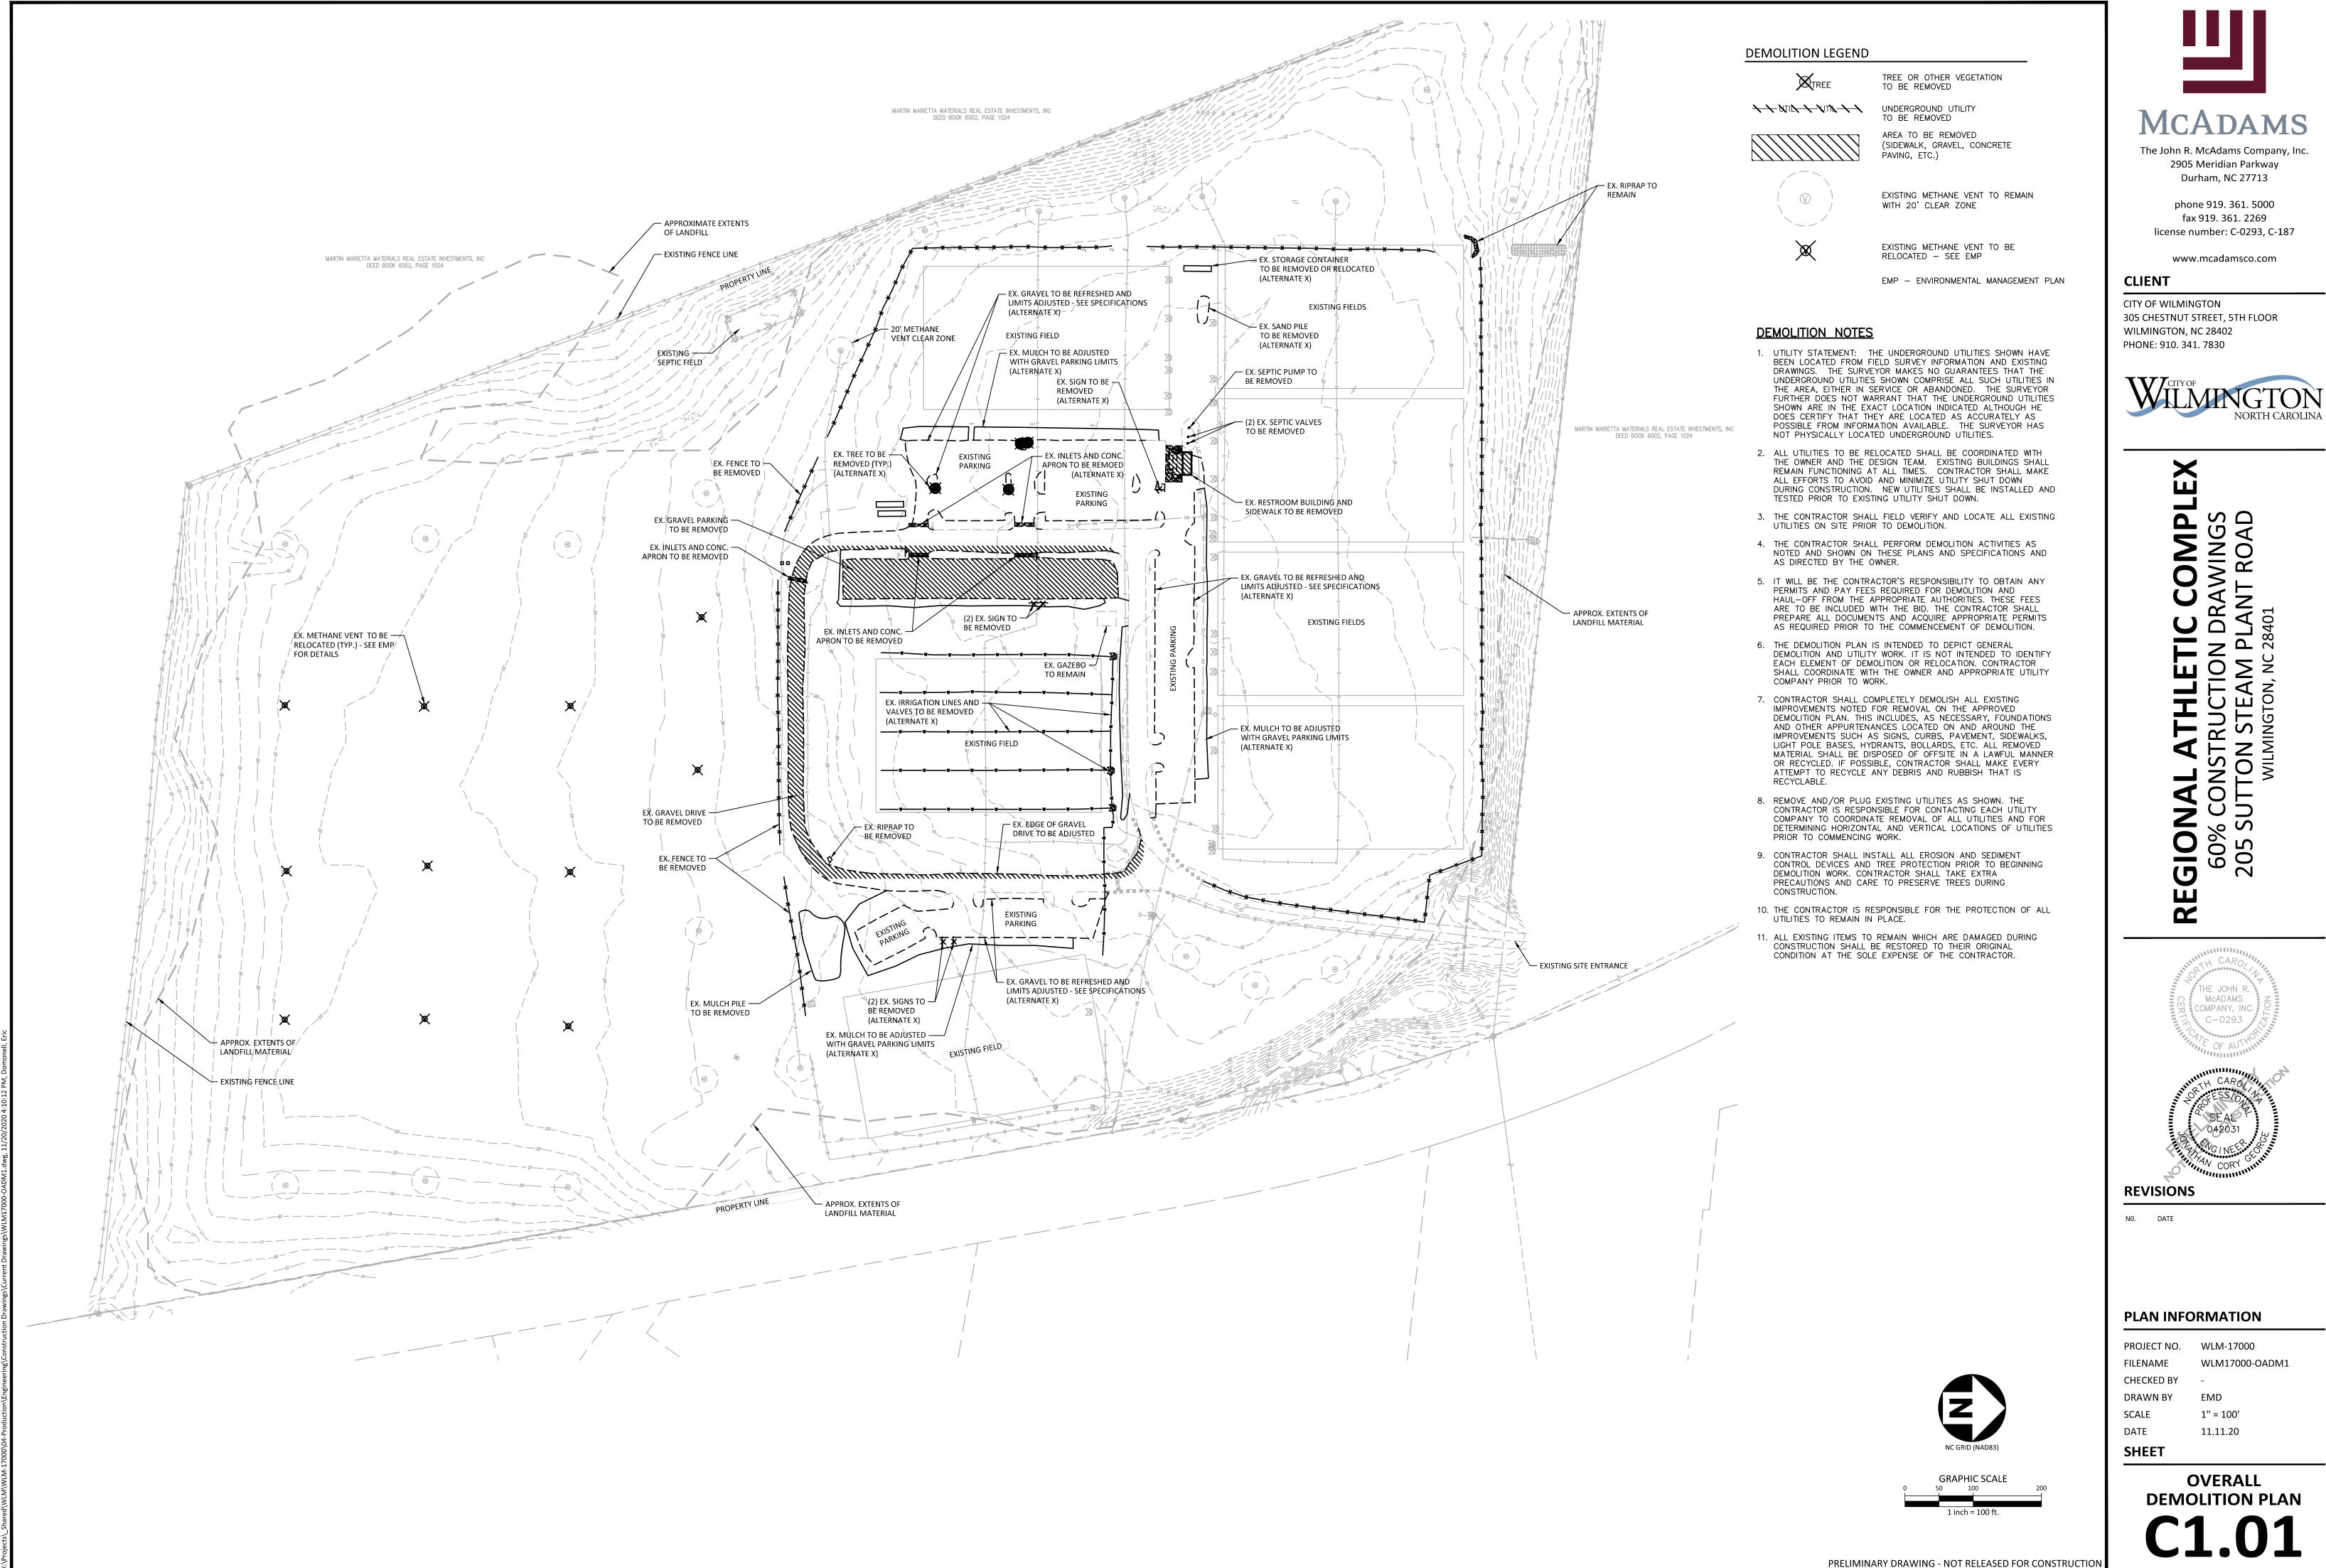


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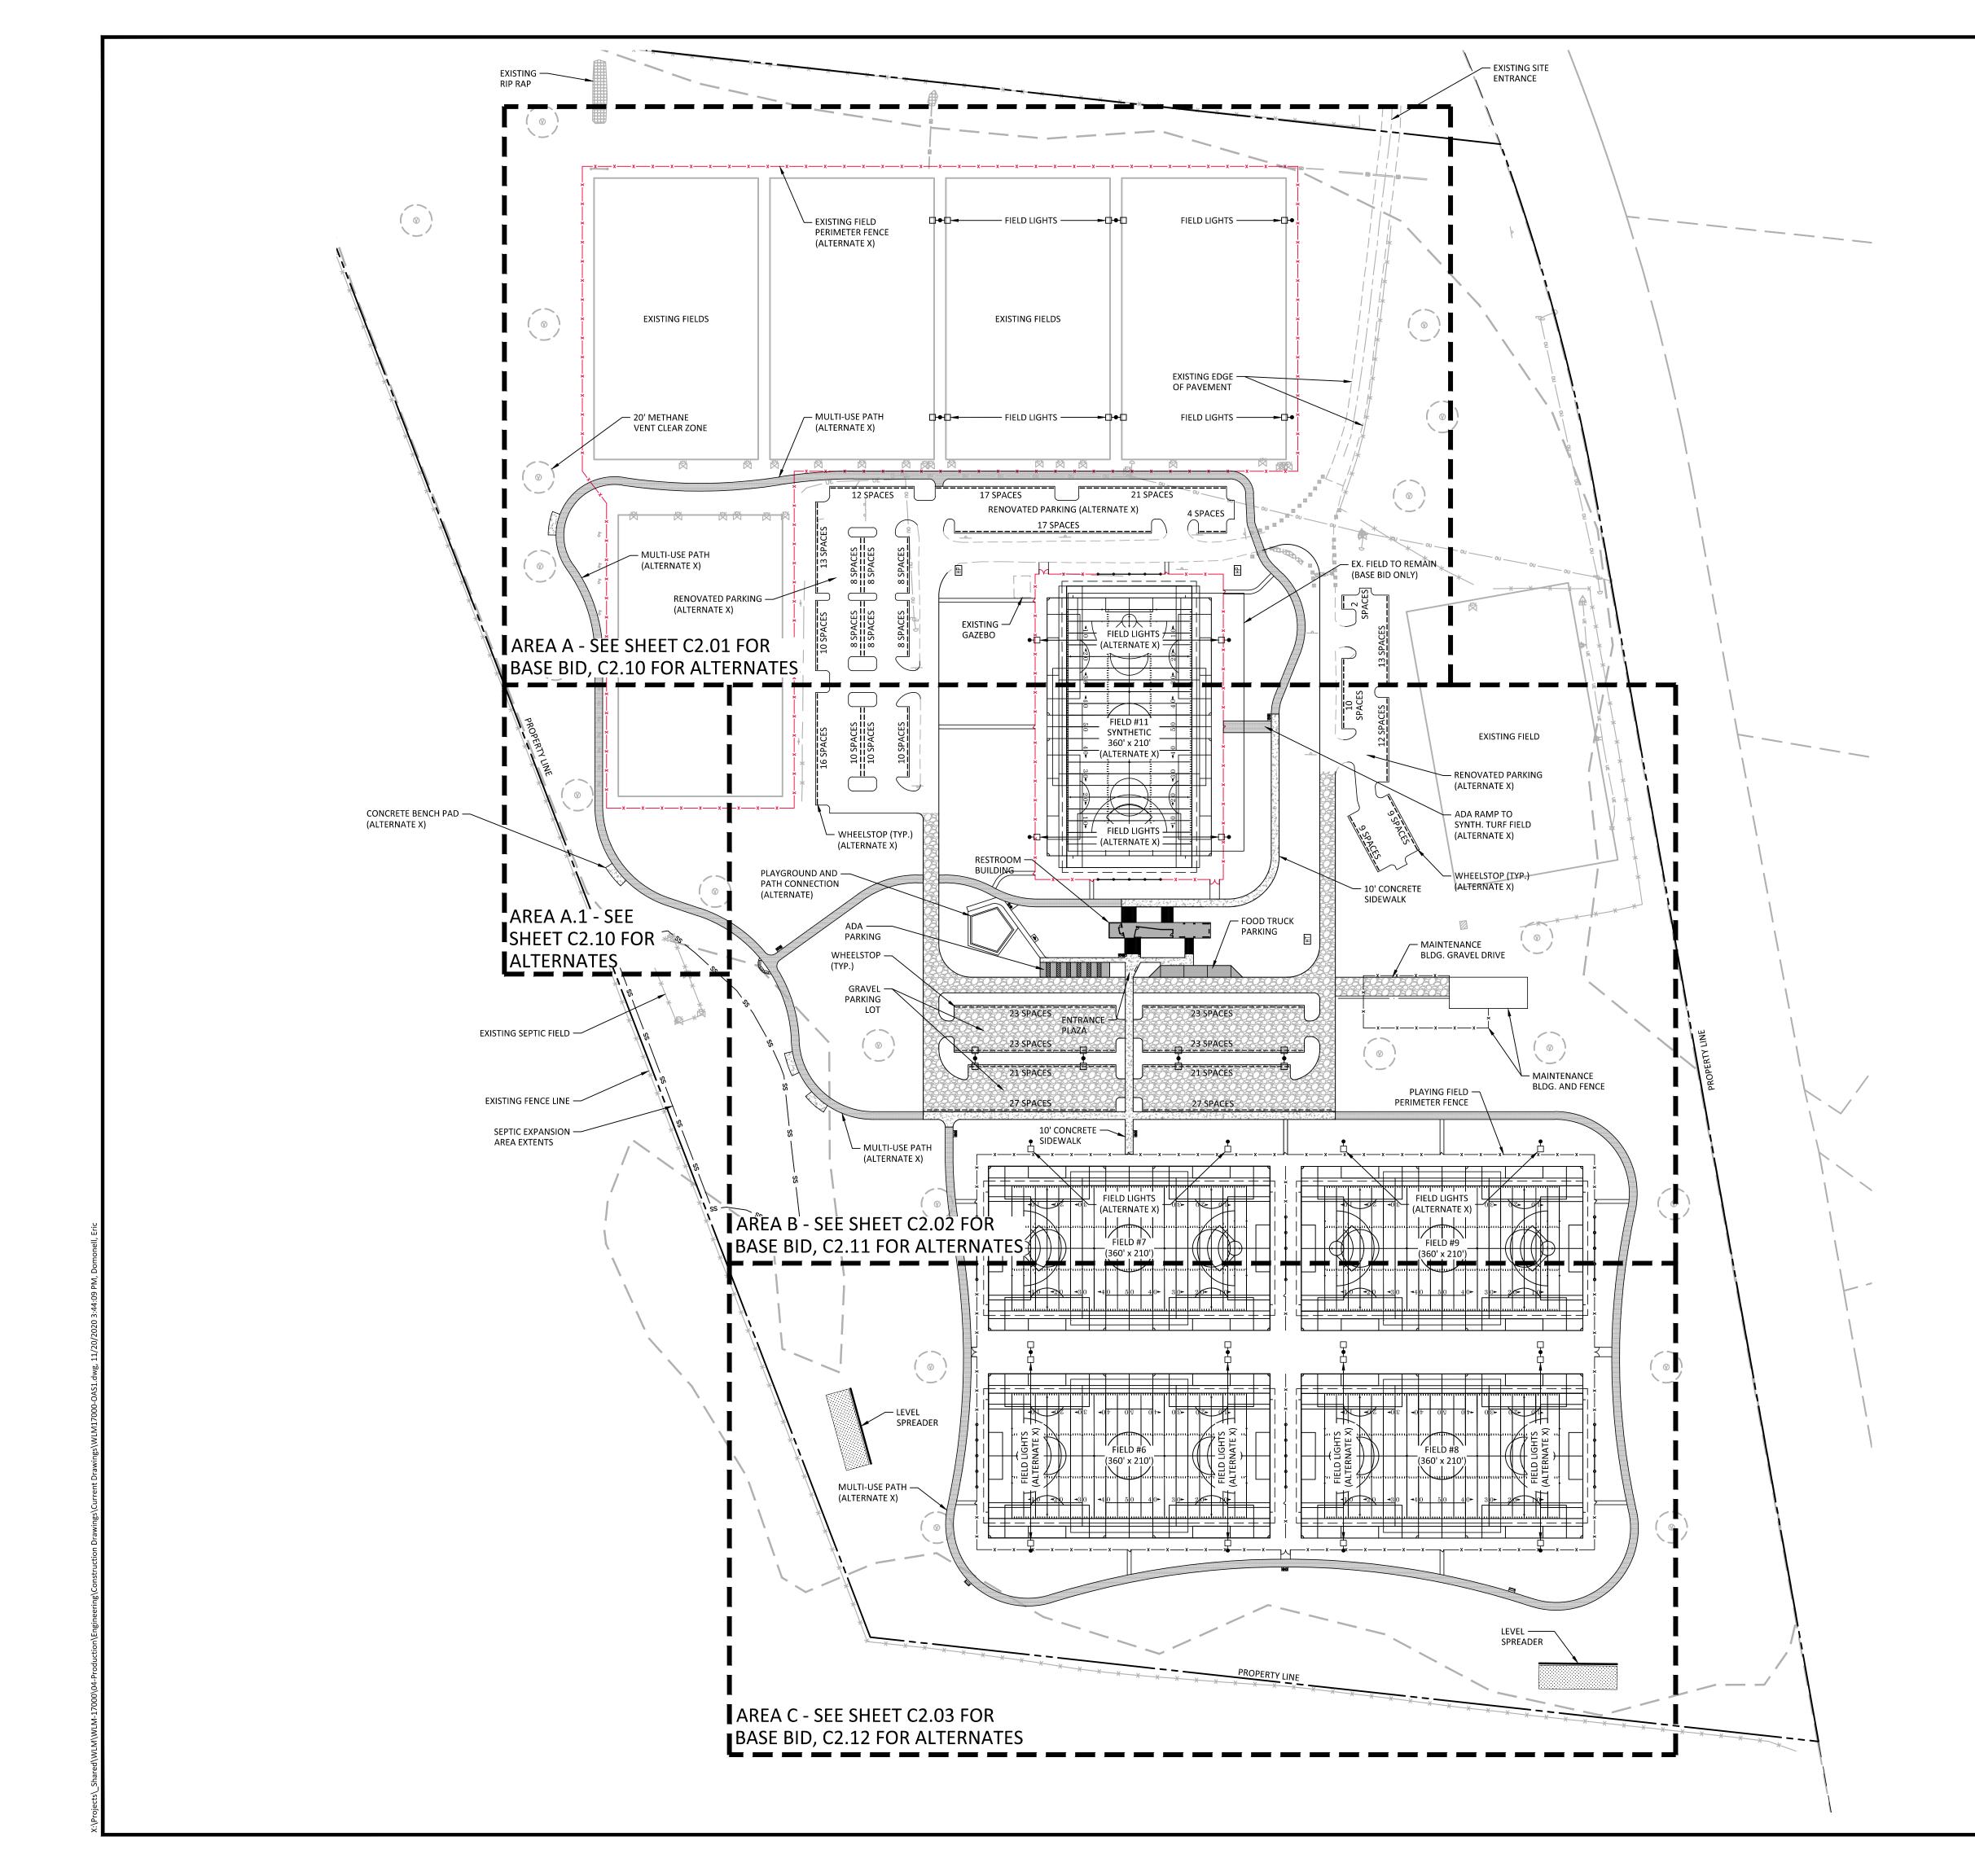
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CENTERLINE
EXISTING CHAINLINK FENCE
PROPOSED FENCE
ACCESSIBLE ROUTE
PROPOSED GRAVEL DRIVE
PROPOSED CONCRETE SIDEWALK
PROPOSED HEAVY-DUTY CONCRETE PAVEMENT
PROPOSED GRAVEL MULTI–USE PATH (ALTERNATE X)

METHANE VENT AND 20' CLEAR ZONE

NIC = NOT IN CONTRACT

#### GENERAL SITE NOTES - APPLIES TO SHEETS C2.00, C2.01, C2.02, C2.10, C2.11 AND C2.12


- 1. THE CONTRACTOR SHALL WORK CLOSELY WITH THE OWNER'S REP. AND/OR LANDSCAPE ARCHITECT AND NOTIFY HIM AS ADDITIONAL INFORMATION IS NEEDED TO PROPERLY CONSTRUCT/INSTALL/BUILD ELEMENTS DEPICTED HEREIN.
- 2. THE CONTRACTOR SHALL PERFORM HIS/HER OWN INVESTIGATIONS TO THE EXTENT NECESSARY TO DETERMINE EFFECTS OF SUB-SURFACE CONDITIONS ON WORK AND SHALL BID AND CONSTRUCT WORK IN ACCORDANCE WITH FINDINGS.
- 3. THE CONTRACTOR SHALL BE RESPONSIBLE FOR LOCATING ALL EXISTING UNDERGROUND UTILITIES PRIOR TO BEGINNING CONSTRUCTION ACTIVITIES AND FOR AVOIDING ALL CONFLICTS WITH SAME. ANY DAMAGE TO EXISTING UTILITIES SHALL BE REPAIRED AT THE EXPENSE OF THE CONTRACTOR.
- 4. CONTRACTOR SHALL VERIFY ALL EXISTING CONDITIONS AND REPORT ANY DISCREPANCIES AND UNUSUAL CONDITIONS TO OWNER'S REP. AND/OR LANDSCAPE ARCHITECT PRIOR TO CONSTRUCTION.
- 5. ALL DISTURBED AREAS AND PROPOSED EARTH GRADING NOT TO BE COVERED BY OTHER SURFACES SHALL BE STABILIZED BY SEEDING, FERTILIZING, MULCHING, AND WATERING AS REQUIRED TO OBTAIN AN ACCEPTABLE GROUND COVER, UNLESS SPECIFIED OTHERWISE. ALL AREAS THAT ARE DISTURBED BY CONSTRUCTION INSIDE OR OUTSIDE THE LIMITS OF WORK SHALL BE REPAIRED, GRADED, AND GRASSED AT THE CONTRACTOR'S EXPENSE.
- SEE CIVIL DRAWINGS FOR ADDITIONAL GRADING AND DRAINAGE INFORMATION.
   CONTRACTOR SHALL BE RESPONSIBLE FOR ENSURING PROPER DRAINAGE OF ANY AND ALL
- 8. CONTRACTOR SHALL RESTORE DAMAGED FINISHES AND REPLACE DAMAGED OR
- 9. CONTRACTOR SHALL STAKE ALL WALKS, HARDSCAPE AND OTHER PAVED AREAS TO BE COMPLETED AND OBTAIN APPROVAL FROM OWNER'S REP. AND/OR LANDSCAPE ARCHITECT PRIOR TO CONSTRUCTION. ANY DISCREPANCIES SHALL BE RESOLVED PRIOR TO CONSTRUCTION. ANY WORK PERFORMED WITHOUT APPROVAL IS AT RISK FOR REPLACEMENT BY THE CONTRACTOR.
- 10. ALL FIELD ADJUSTMENTS SHALL RECEIVE APPROVAL FROM OWNER'S REP. PRIOR TO CONSTRUCTION.
- 11. CONSTRUCT EXPANSION JOINTS WHERE WALKS MEET CURBS, STEPS, WALLS, FIXED SLABS,
- 12. TEMPORARY EROSION & SEDIMENT CONTROLS (SILT FENCES, ETC.) SHALL BE INSTALLED AT INLETS, PIPES, AND LIMITS OF WORK AREAS WHERE SURFACE RUN-OFF OCCURS UNTIL SOIL STABILIZATION IS COMPLETE. SEE CIVIL DRAWINGS FOR SEDIMENTATION AND EROSION CONTROL INFORMATION.
- 13. SEE ARCHITECTURAL PLANS FOR BUILDING INFORMATION.

AREAS WHICH ARE FIELD ADJUSTED DURING C

DEFECTIVE BRICK PAVERS OR CONCRETE.

OR VERTICAL STRUCTURES.

- 14. CONTRACTOR SHALL MAINTAIN ALL GRASSED AREAS, INCLUDING REPAIR OF EROSION AREAS UNTIL GRASS HAS REACHED LEVEL OF FINAL ACCEPTANCE.
- 15. ALL CONSTRUCTION SHALL BE PERFORMED IN ACCORDANCE WITH CONTRACT DOCUMENTS AND ALL LOCAL, STATE, AND FEDERAL AGENCIES AND REGULATIONS.
- 16. CONTRACTOR SHALL PROTECT THE PUBLIC FROM CONSTRUCTION AREAS AND ASSOCIATED ACTIVITY DURING CONSTRUCTION.
- 17. DIGITAL BASE FILE MAY BE MADE AVAILABLE FOR USE IN FIELD LOCATION OF ELEMENTS AND SITE FEATURES. ANY HARDCOPY INFORMATION THAT CONFLICTS SHALL BE BROUGHT TO OWNER'S REP AND/OR LANDSCAPE ARCHITECT'S ATTENTION.
- 18. CONTRACTOR SHALL COORDINATE CONDUIT LOCATIONS (I.E. IRRIGATION, ELECTRICAL, NATURAL GAS ETC.) PRIOR TO CONCRETE INSTALLATION.

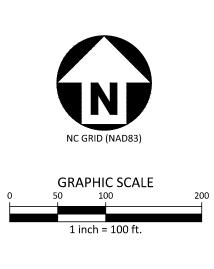



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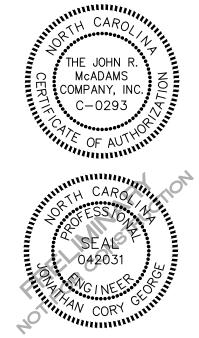
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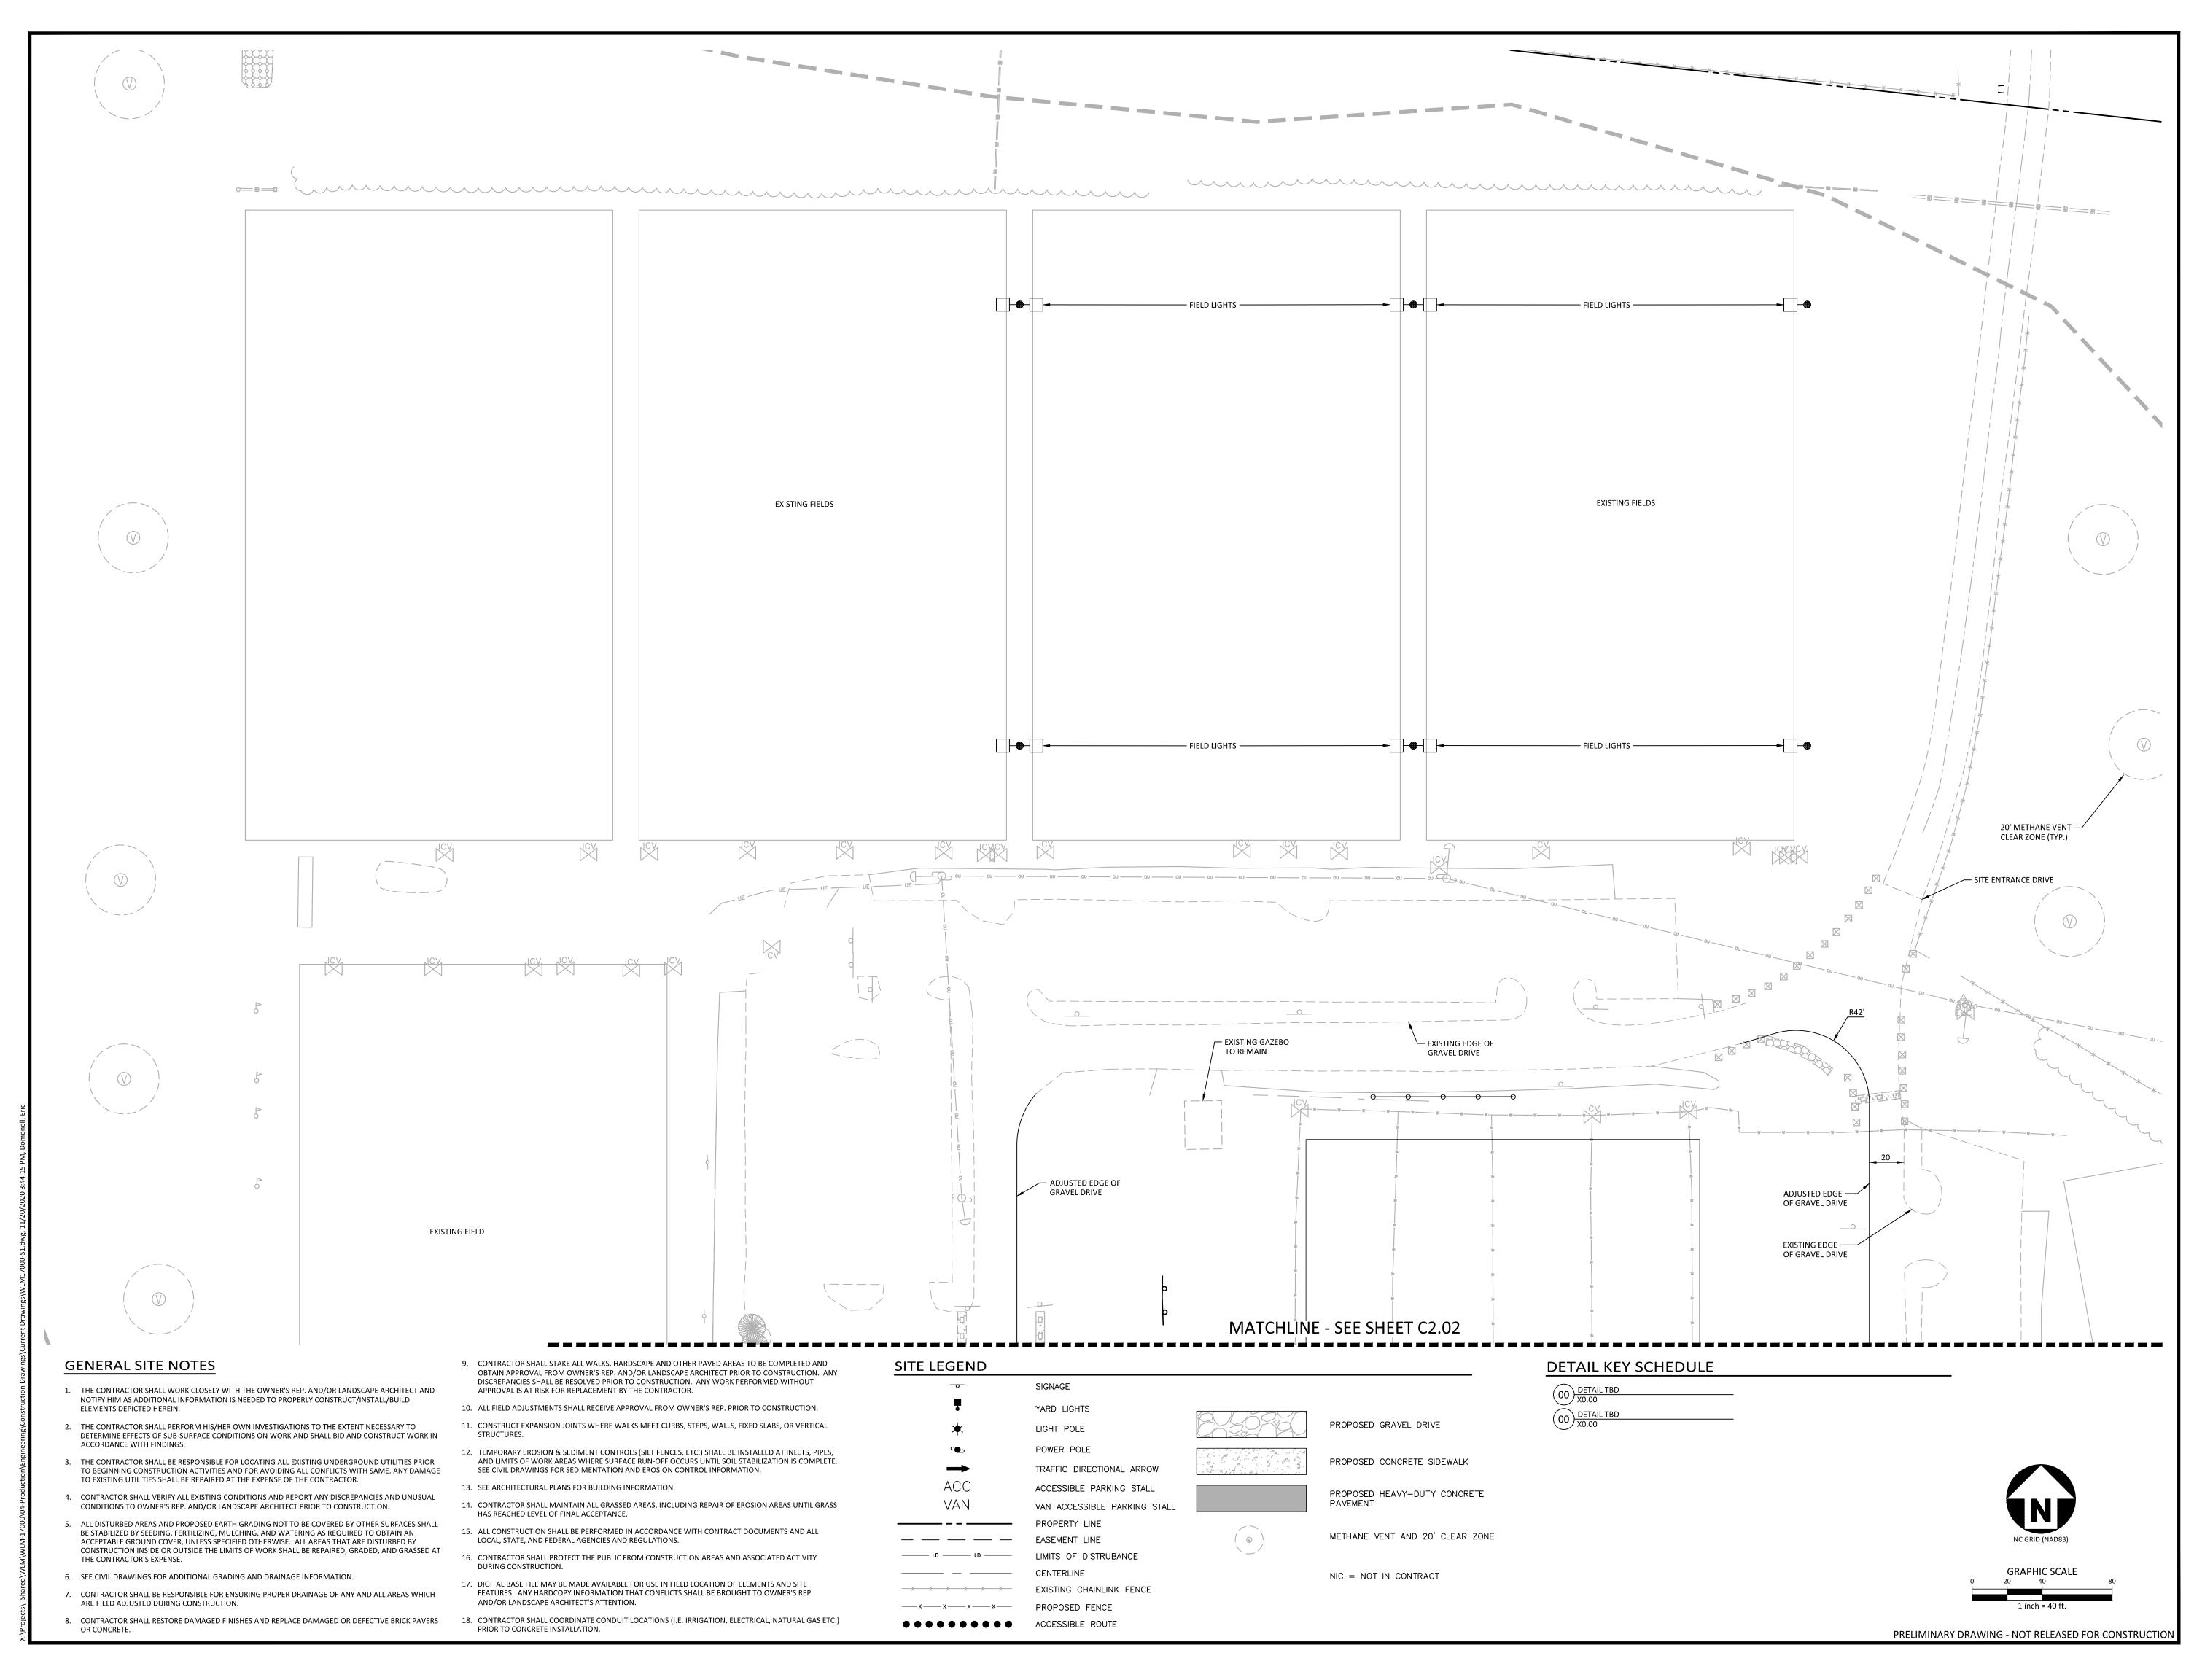


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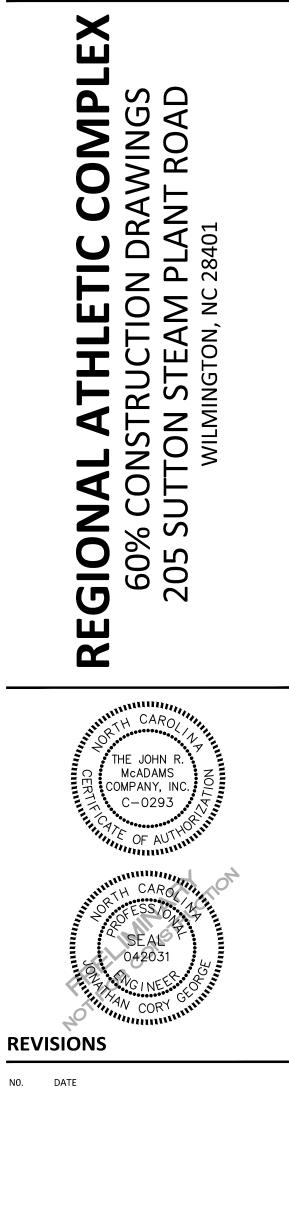
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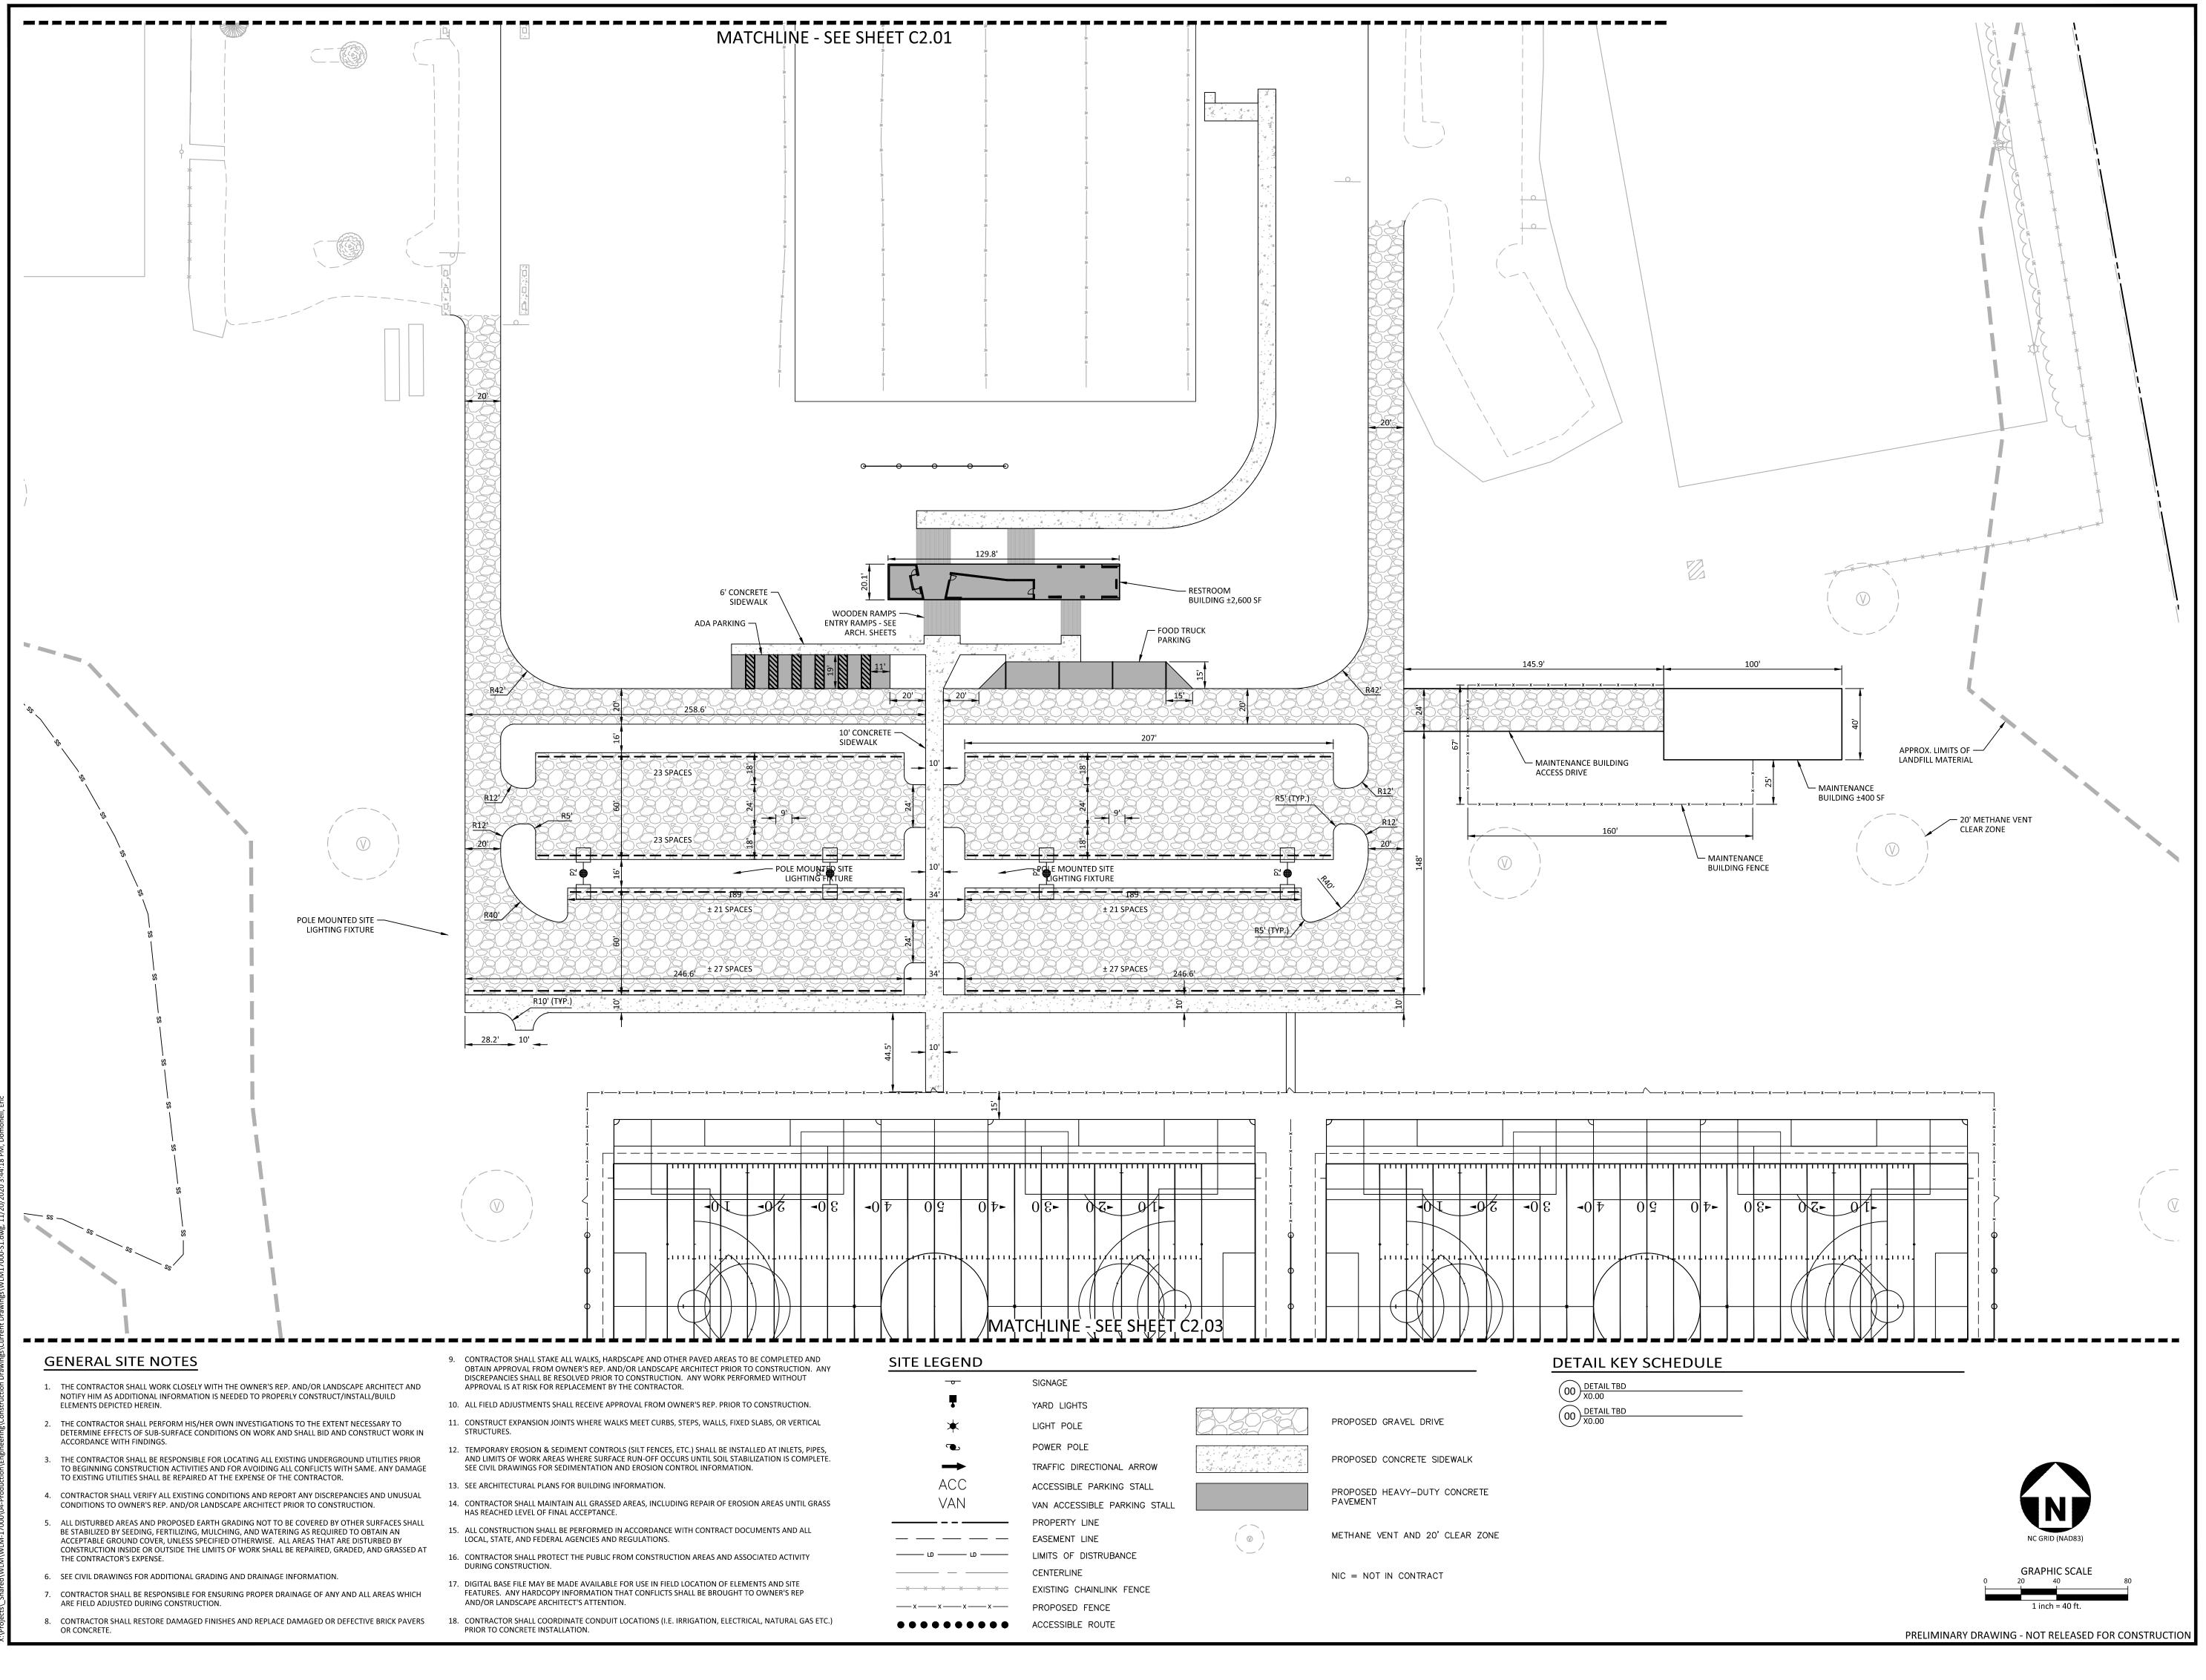




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site plan - Area A base bid C2.01









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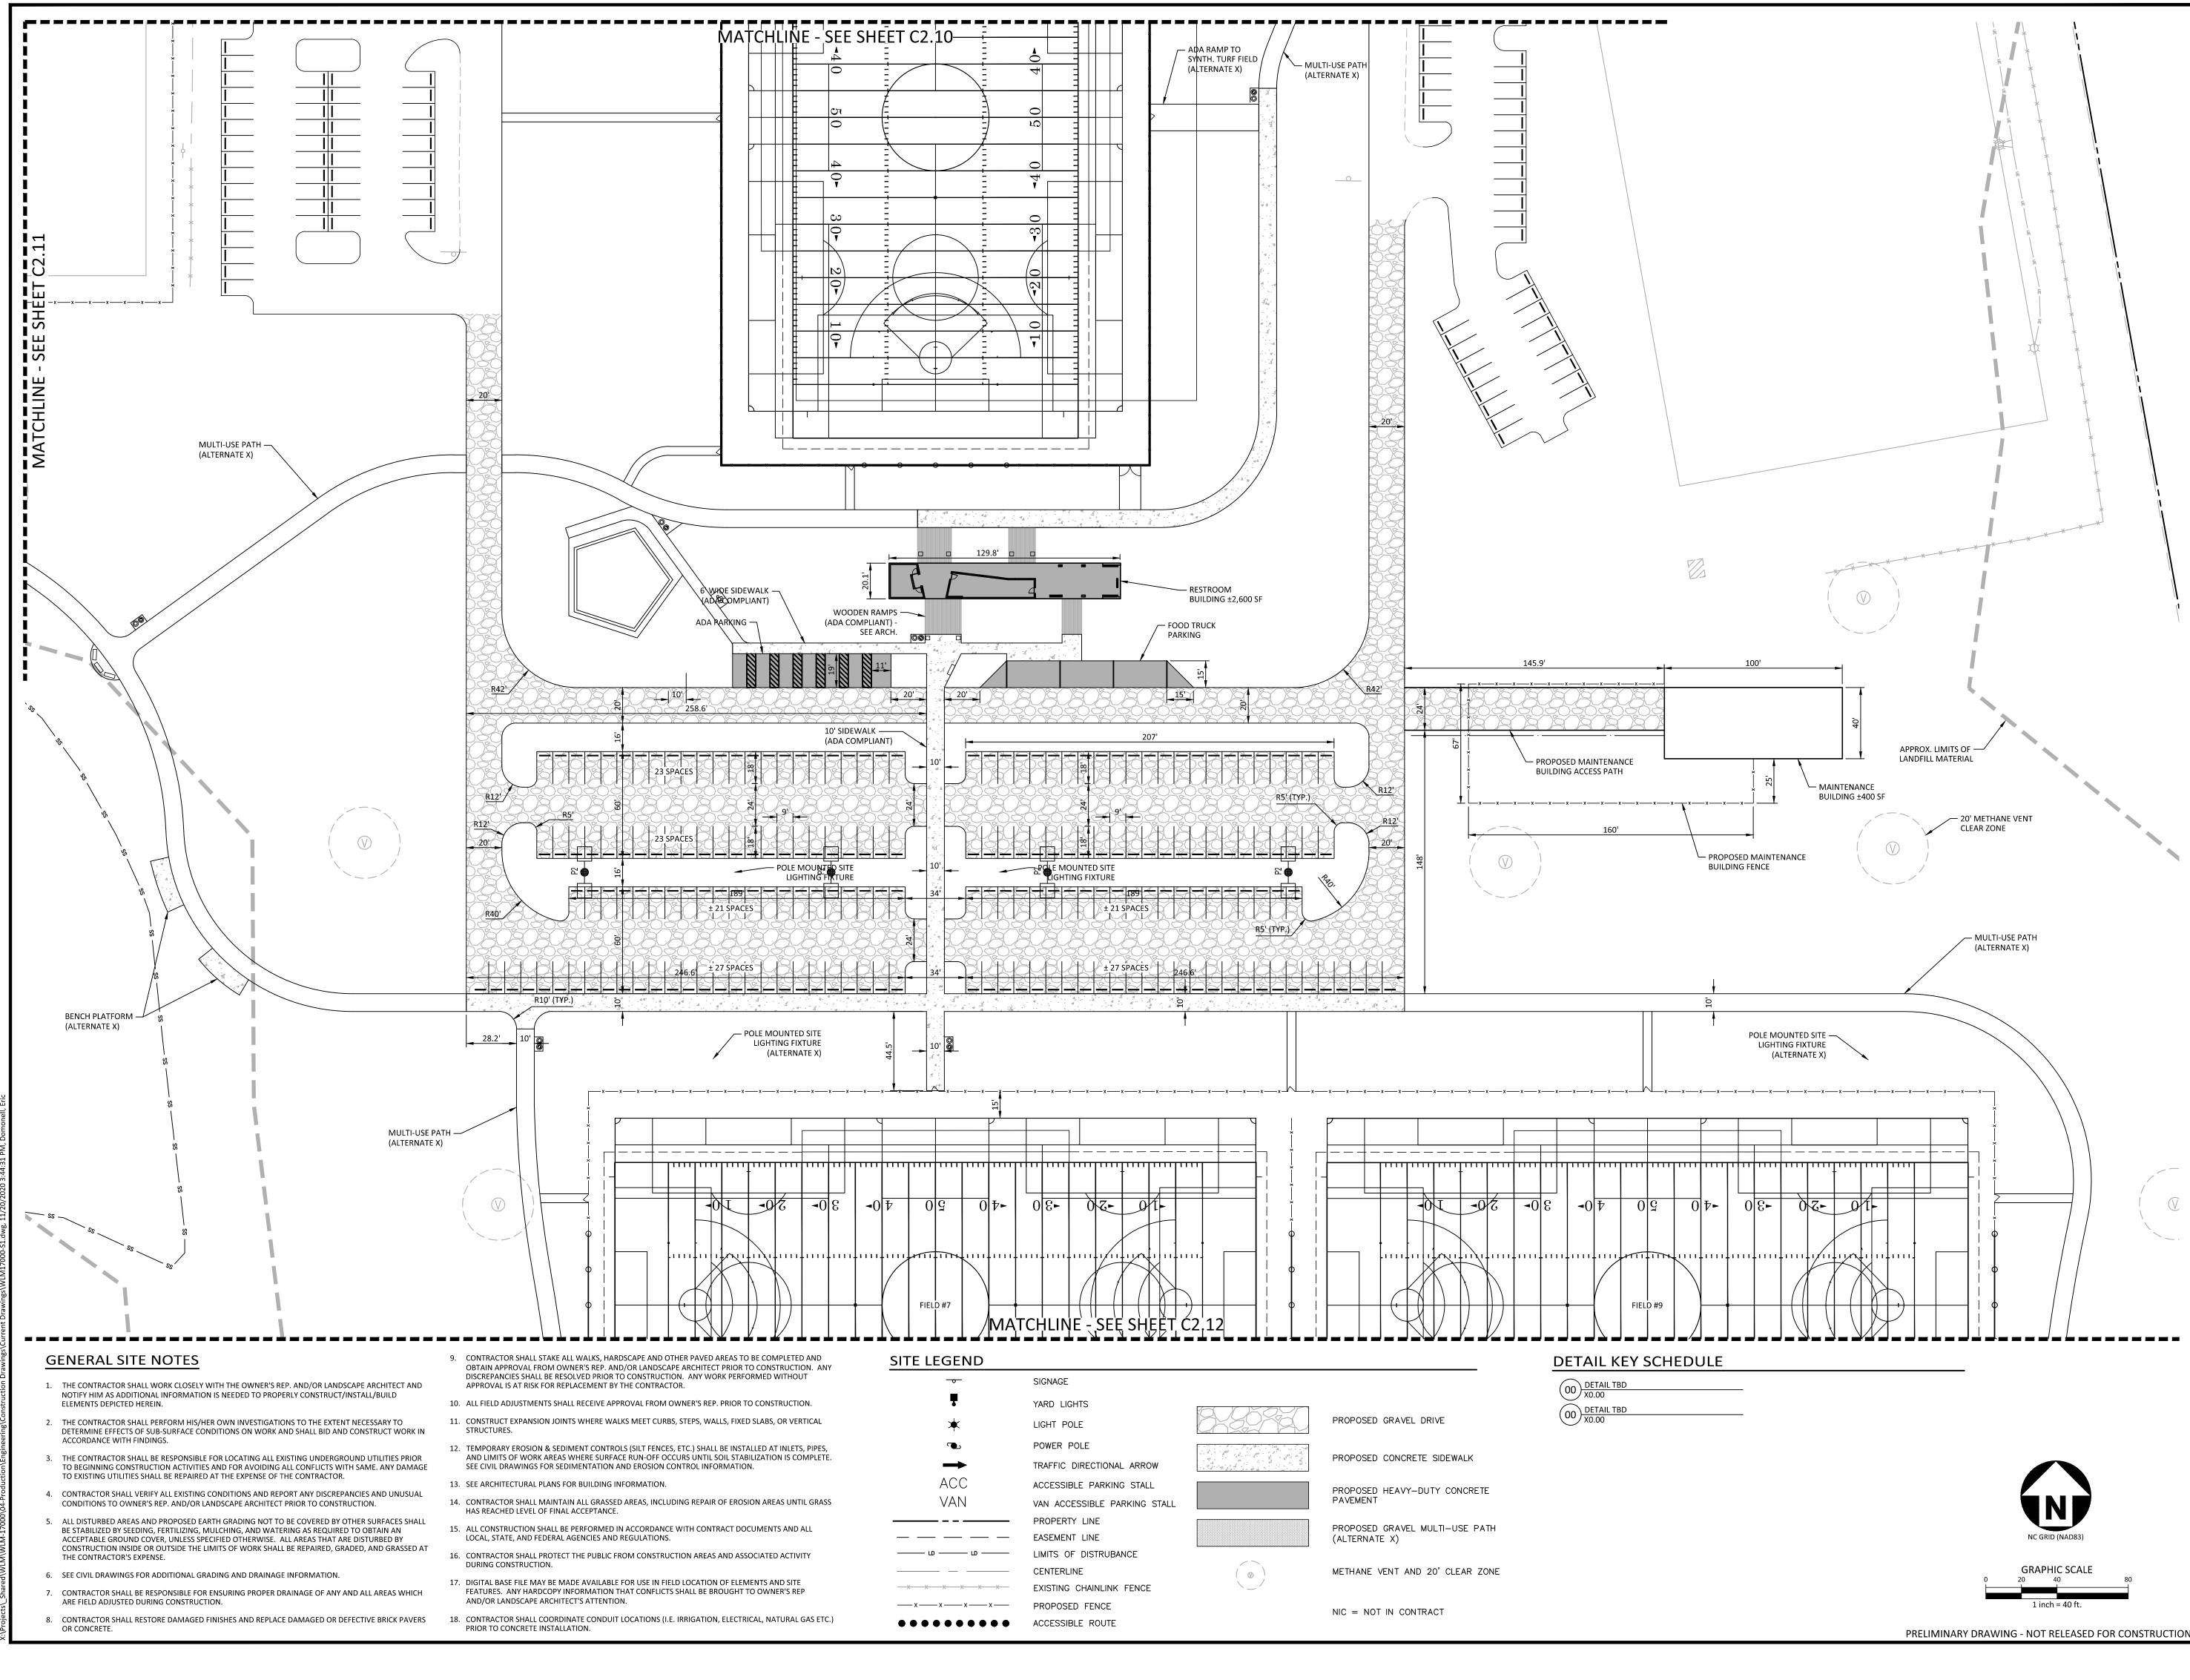
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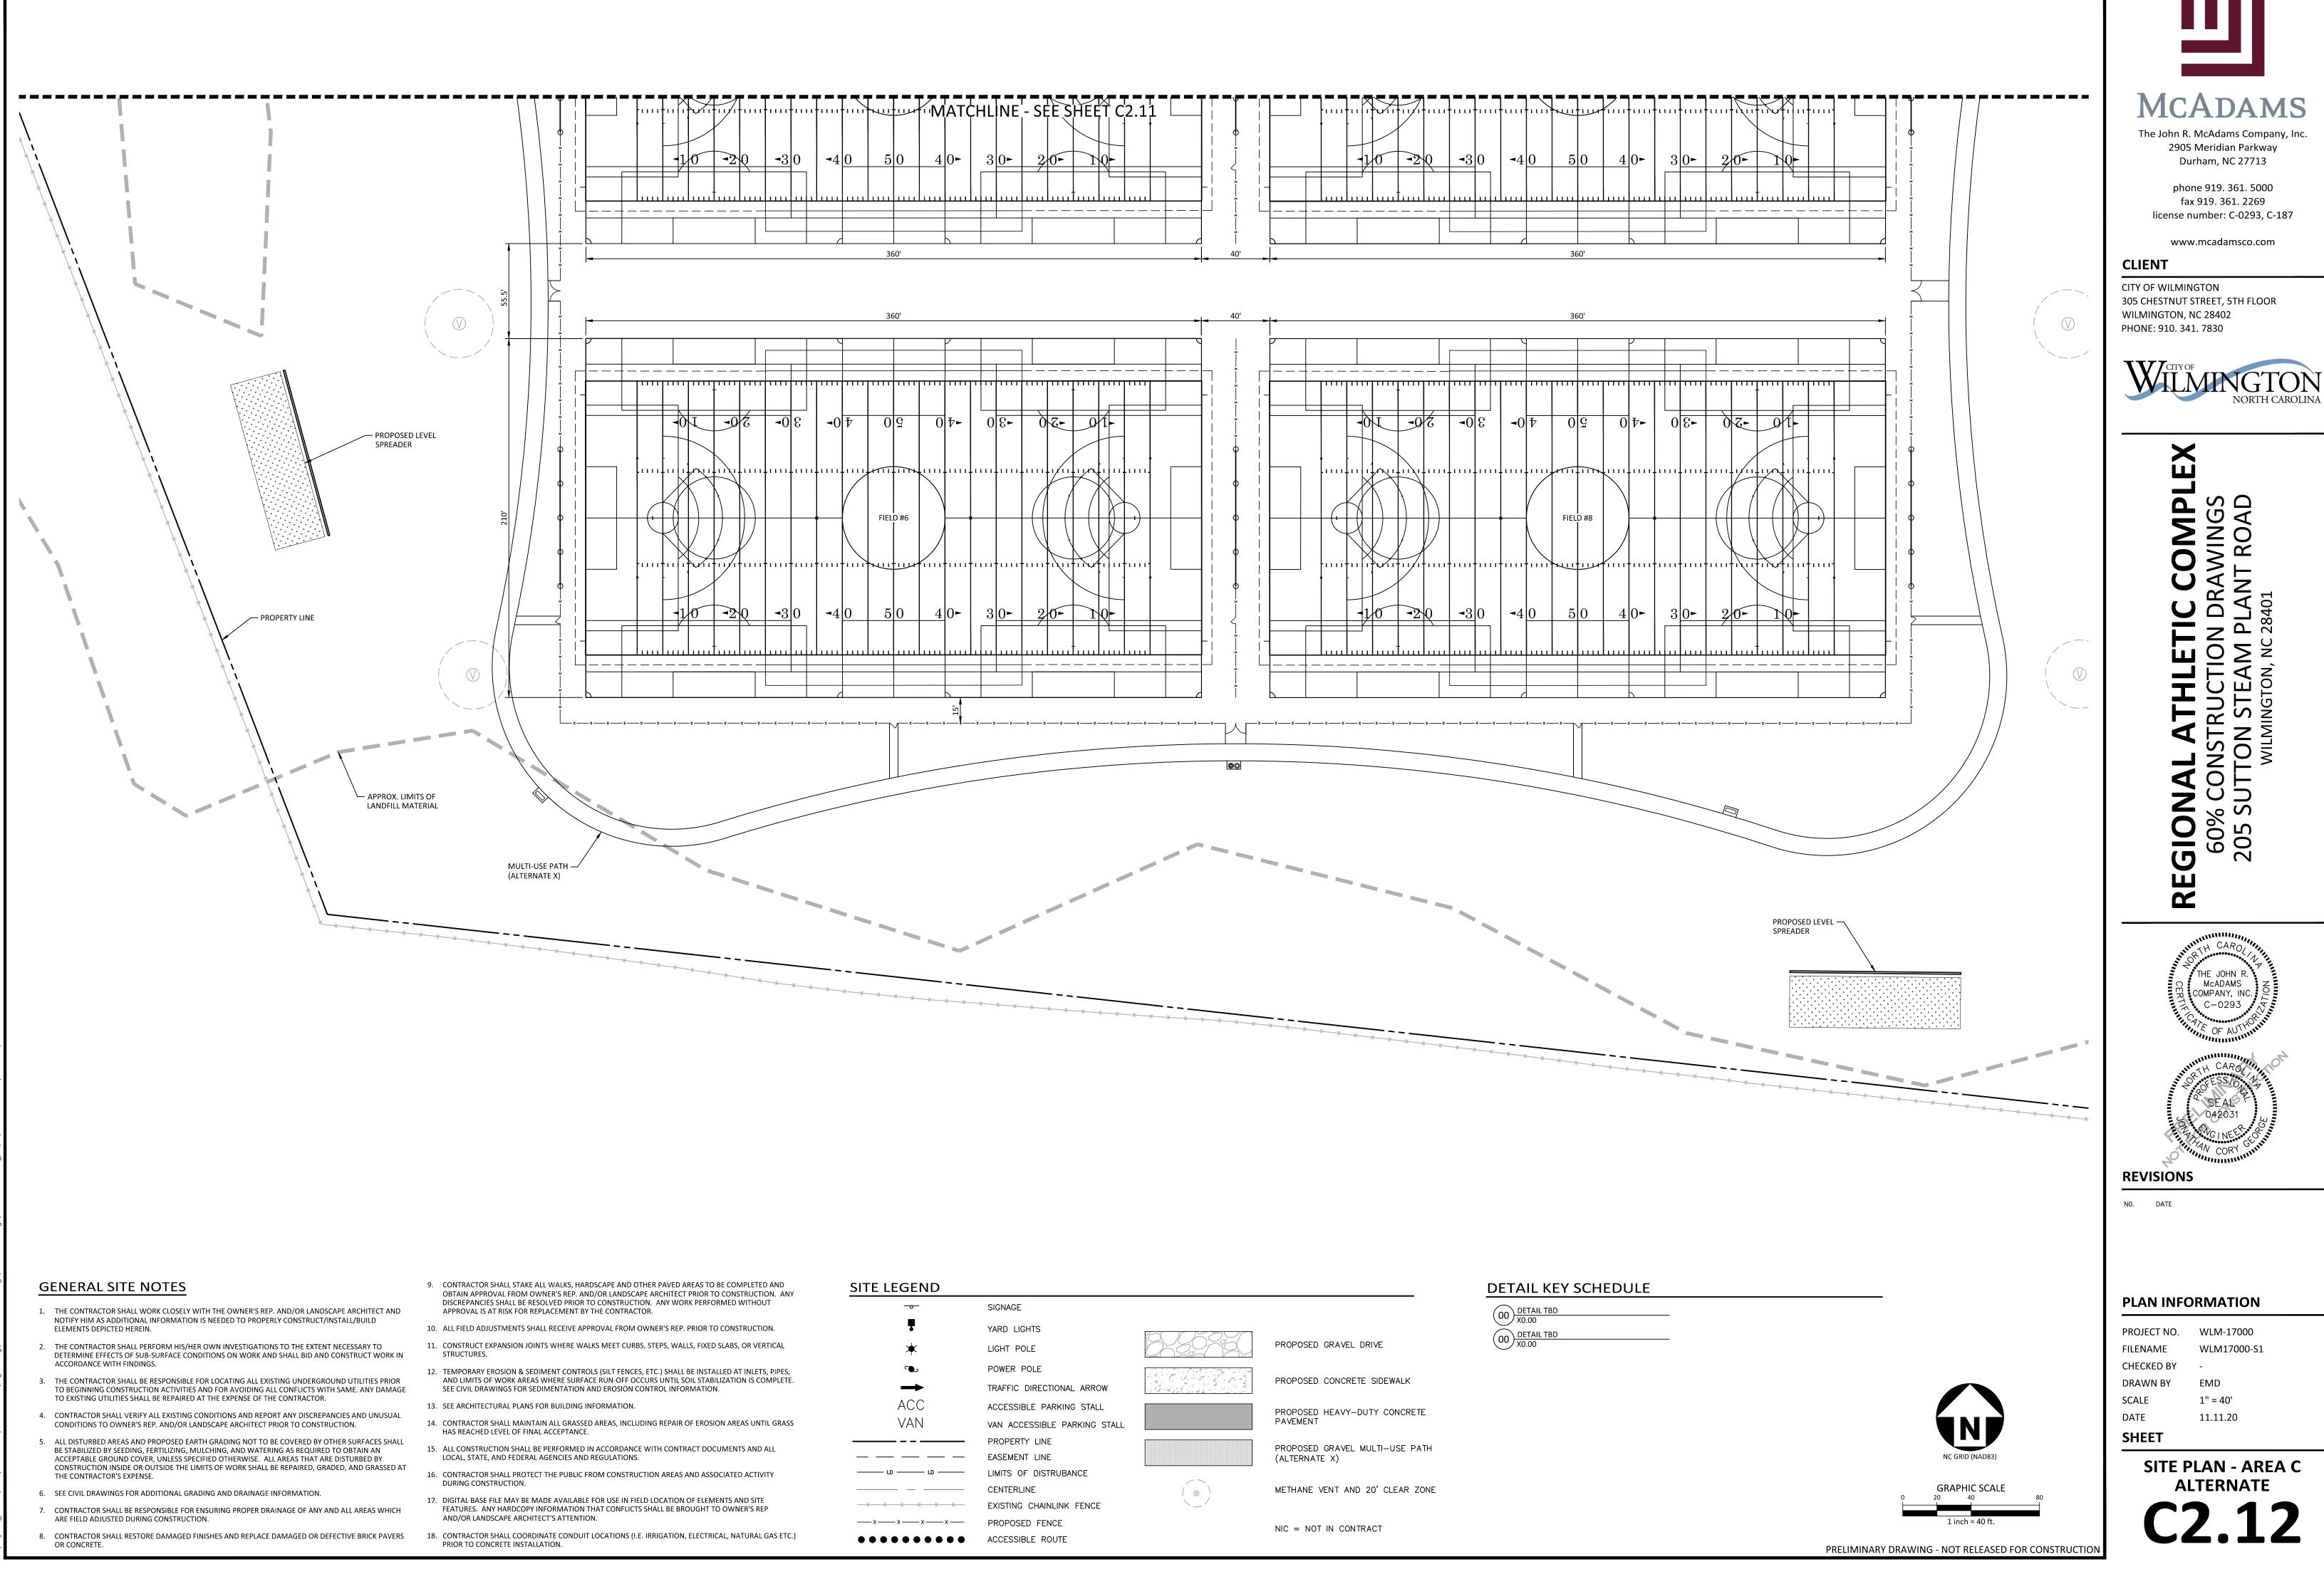
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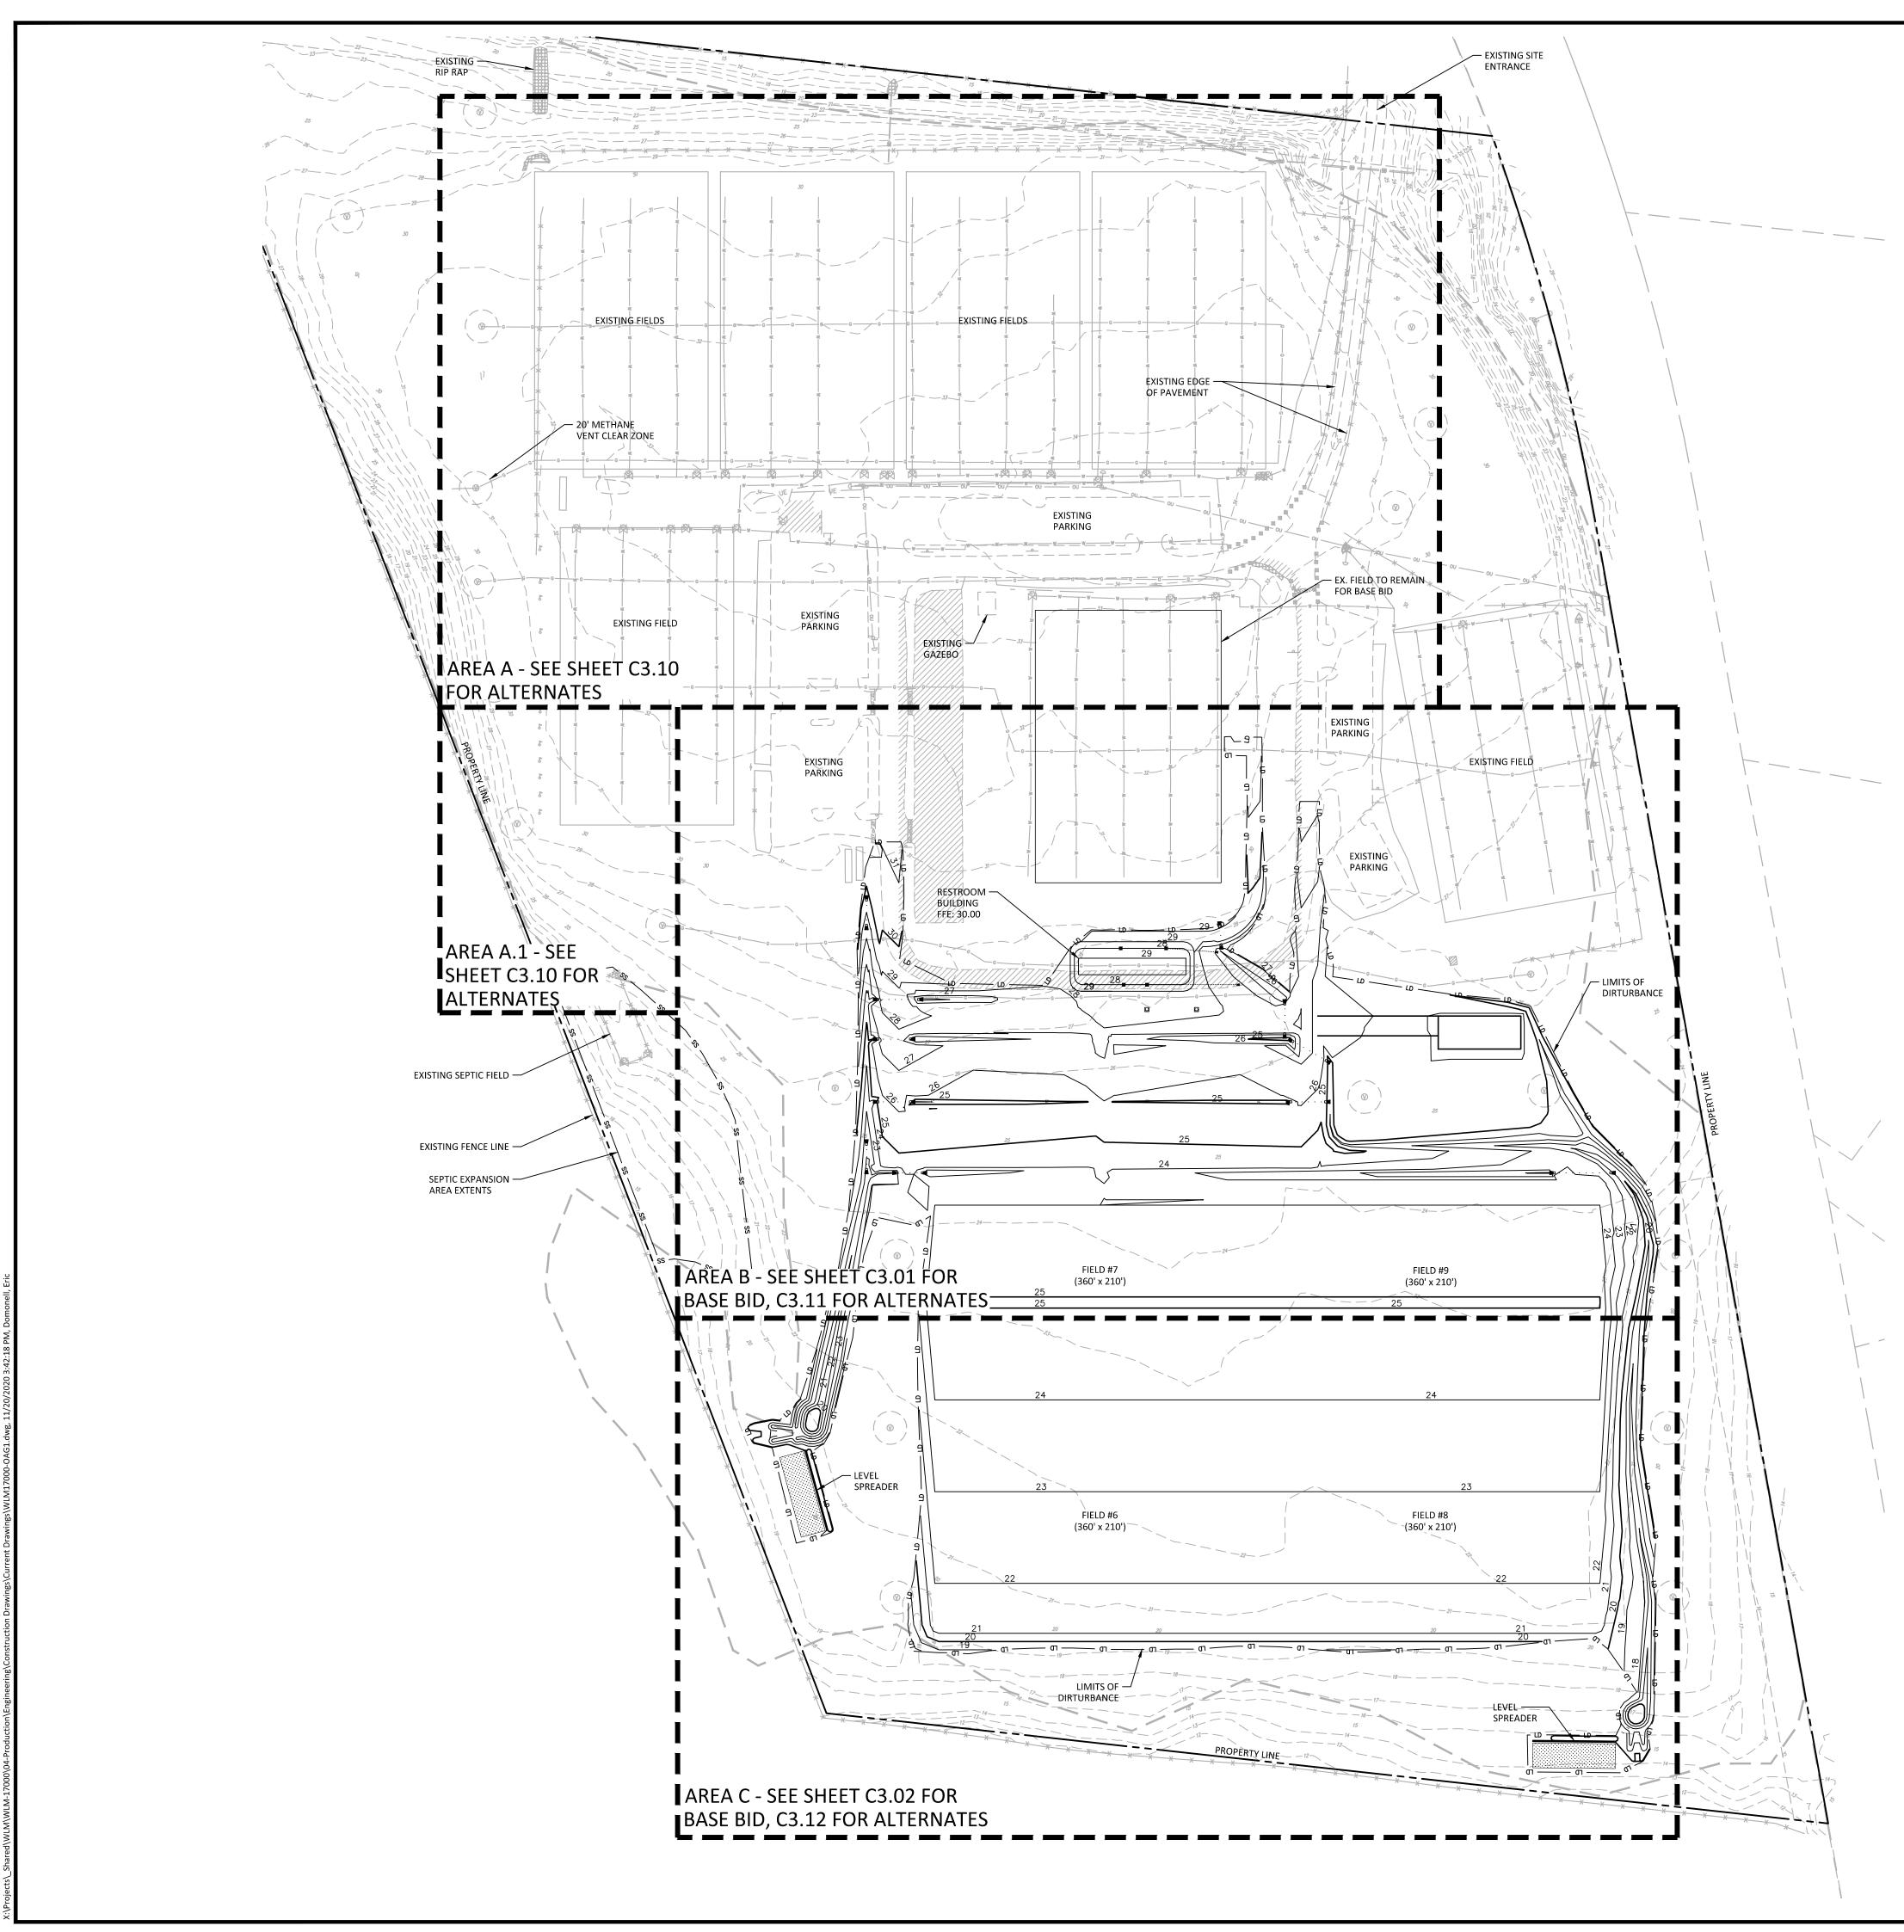


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RAL GAS ETC.)	••••	ACCESSIBLE ROUTE			

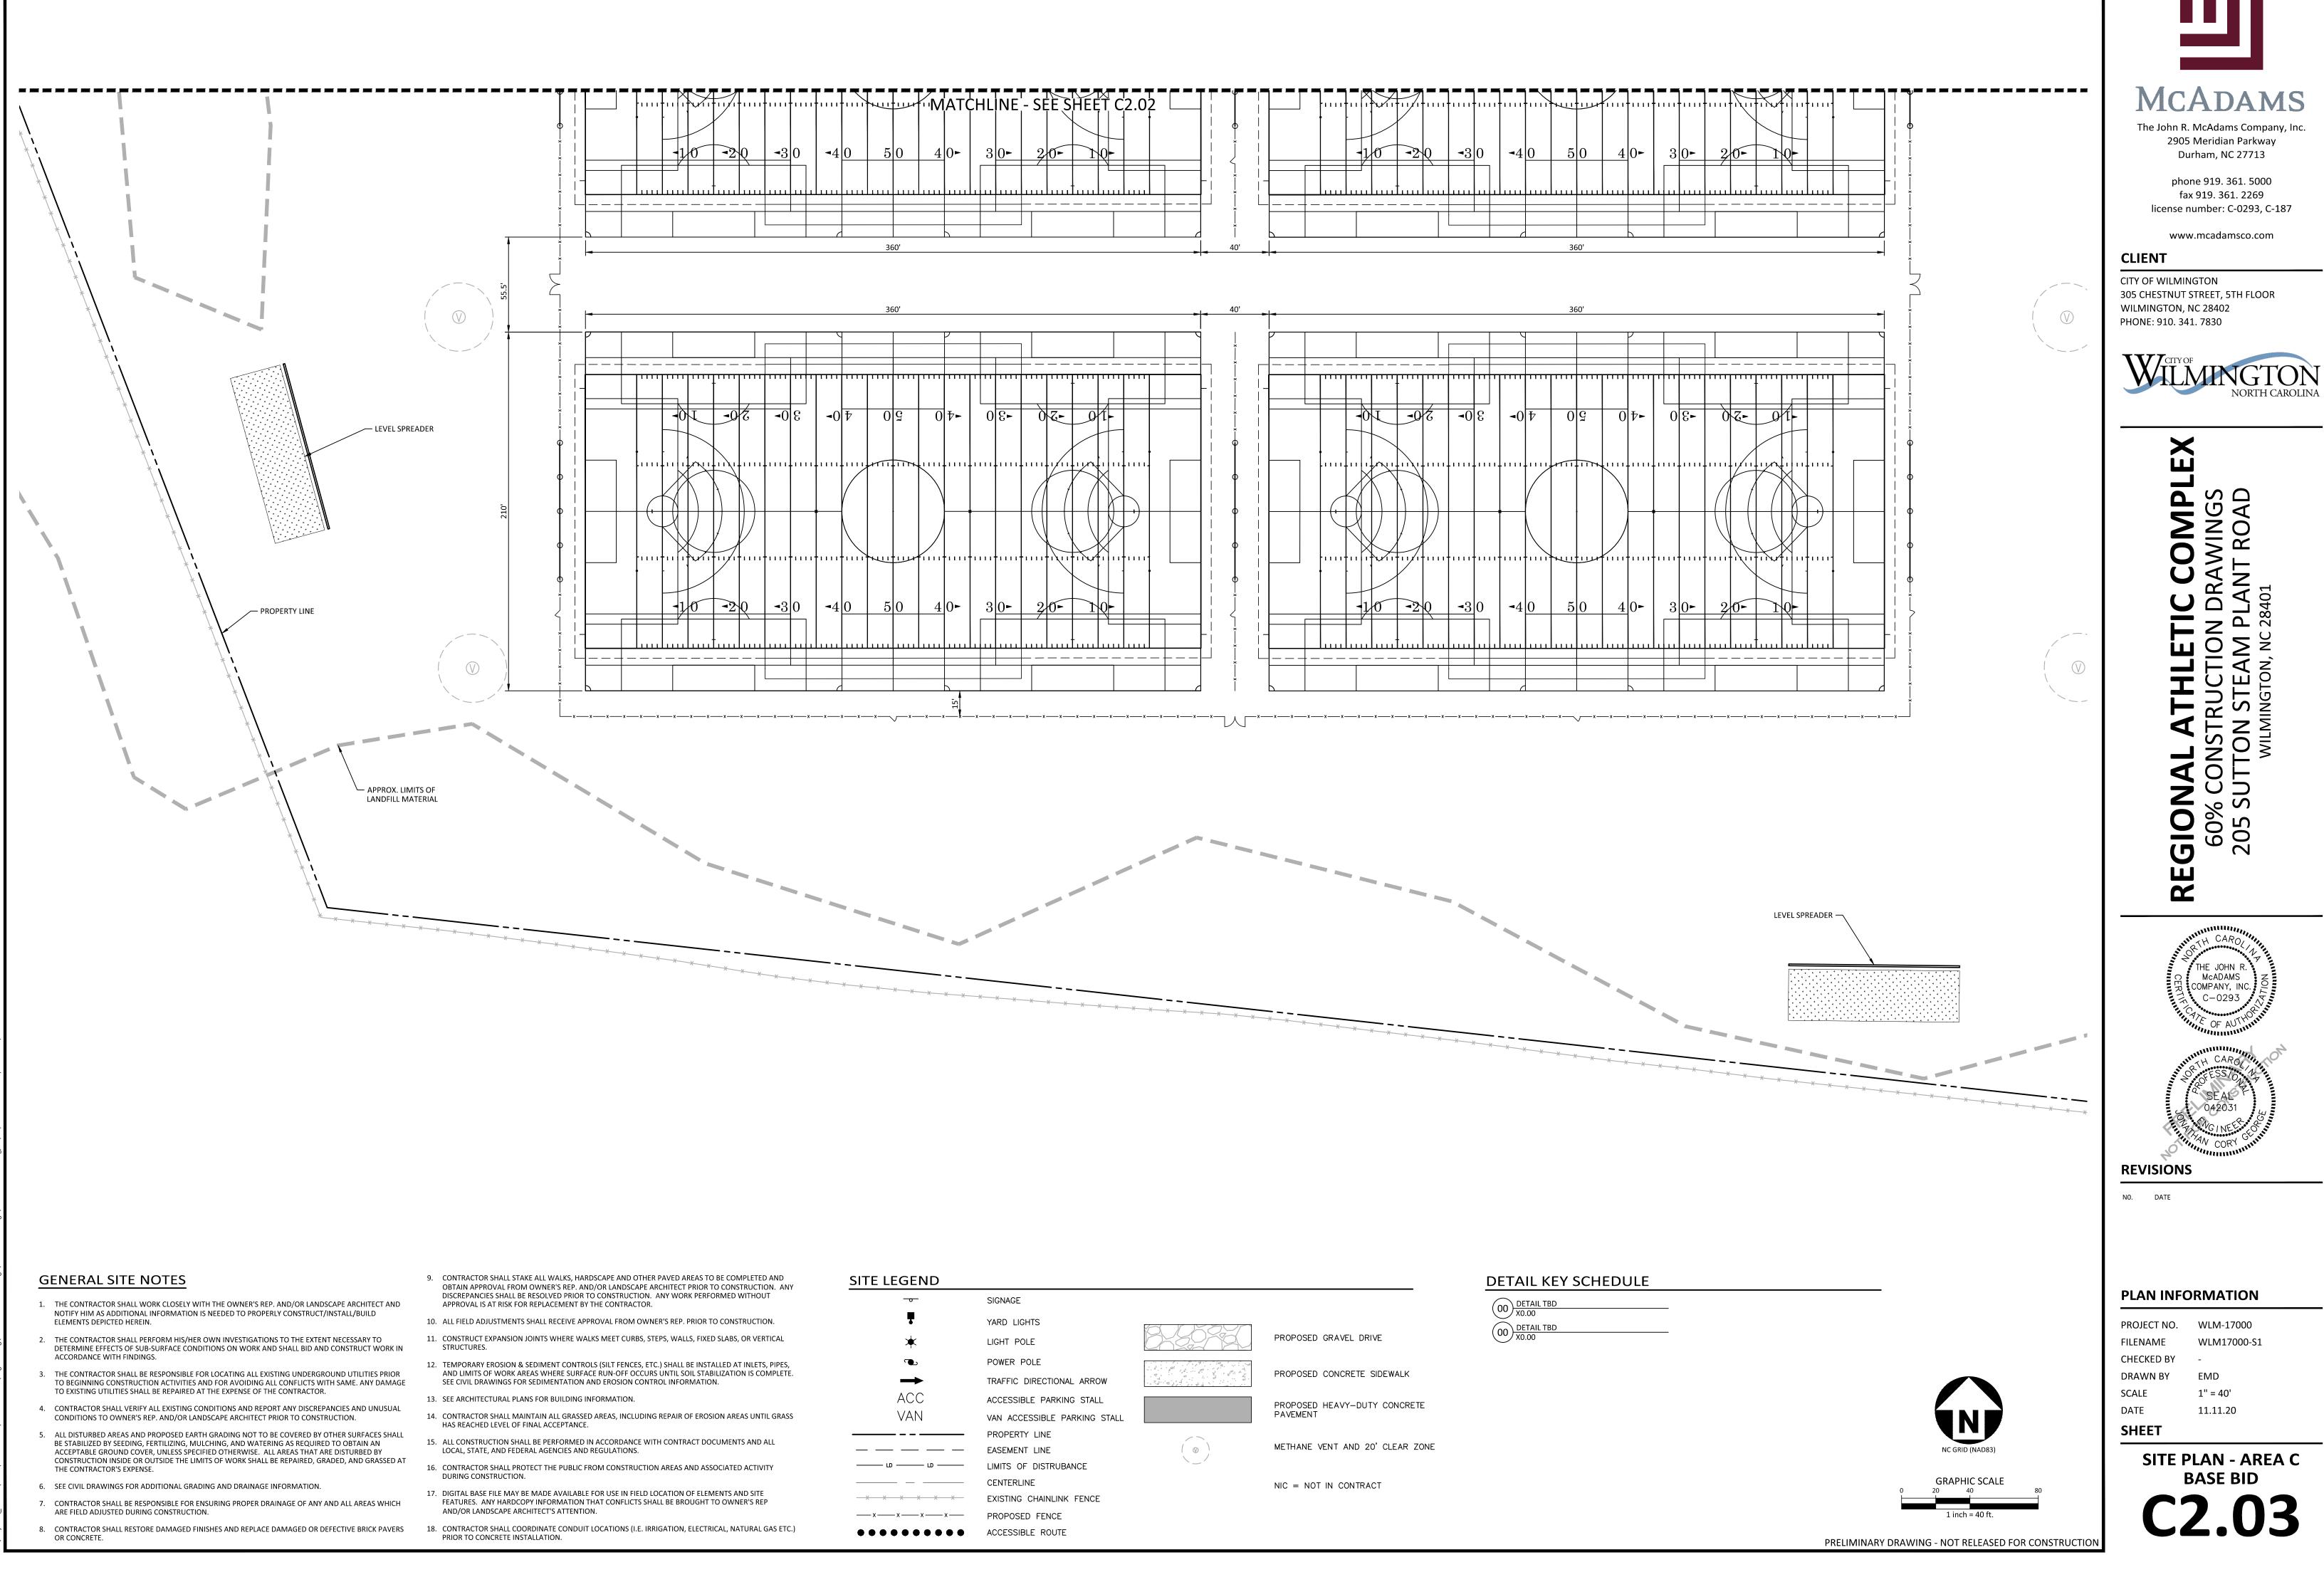


#### **GRADING LEGEND** FLARED END SECTION ENDWALL SECTION CATCH BASIN DROP INLET STORM SERVICE INLET JUNCTION BOX DRAINAGE FLOW ARROW $\sim$ LINE BREAK SYMBOL $\sim$ 250.50 250.00 TOP & BOTTOM CURB ELEVATIONS TW=223.00 TOP OF WALL ELEVATION BW=213.00 BOTTOM OF WALL ELEVATION ----- BOTTOM OF WALL ELEVATION (NOTE: BOTTOM OF WALL IS GROUND ÈLEVATION NOT WALL FOUNDATION) + 250.60 SPOT ELEVATION STORM DRAINAGE ------- STORM SERVICE LINE \_\_\_\_\_LD \_\_\_\_\_LD \_\_\_\_\_ LIMITS OF DISTURBANCE 250 MAJOR CONTOUR 252 \_\_\_\_ MINOR CONTOUR 250 EXISTING MAJOR CONTOUR \_\_\_\_\_252\_\_\_\_ EXISTING MINOR CONTOUR - - FIELD RUNOFF — DITCH CENTERLINE

### **GRADING NOTES**

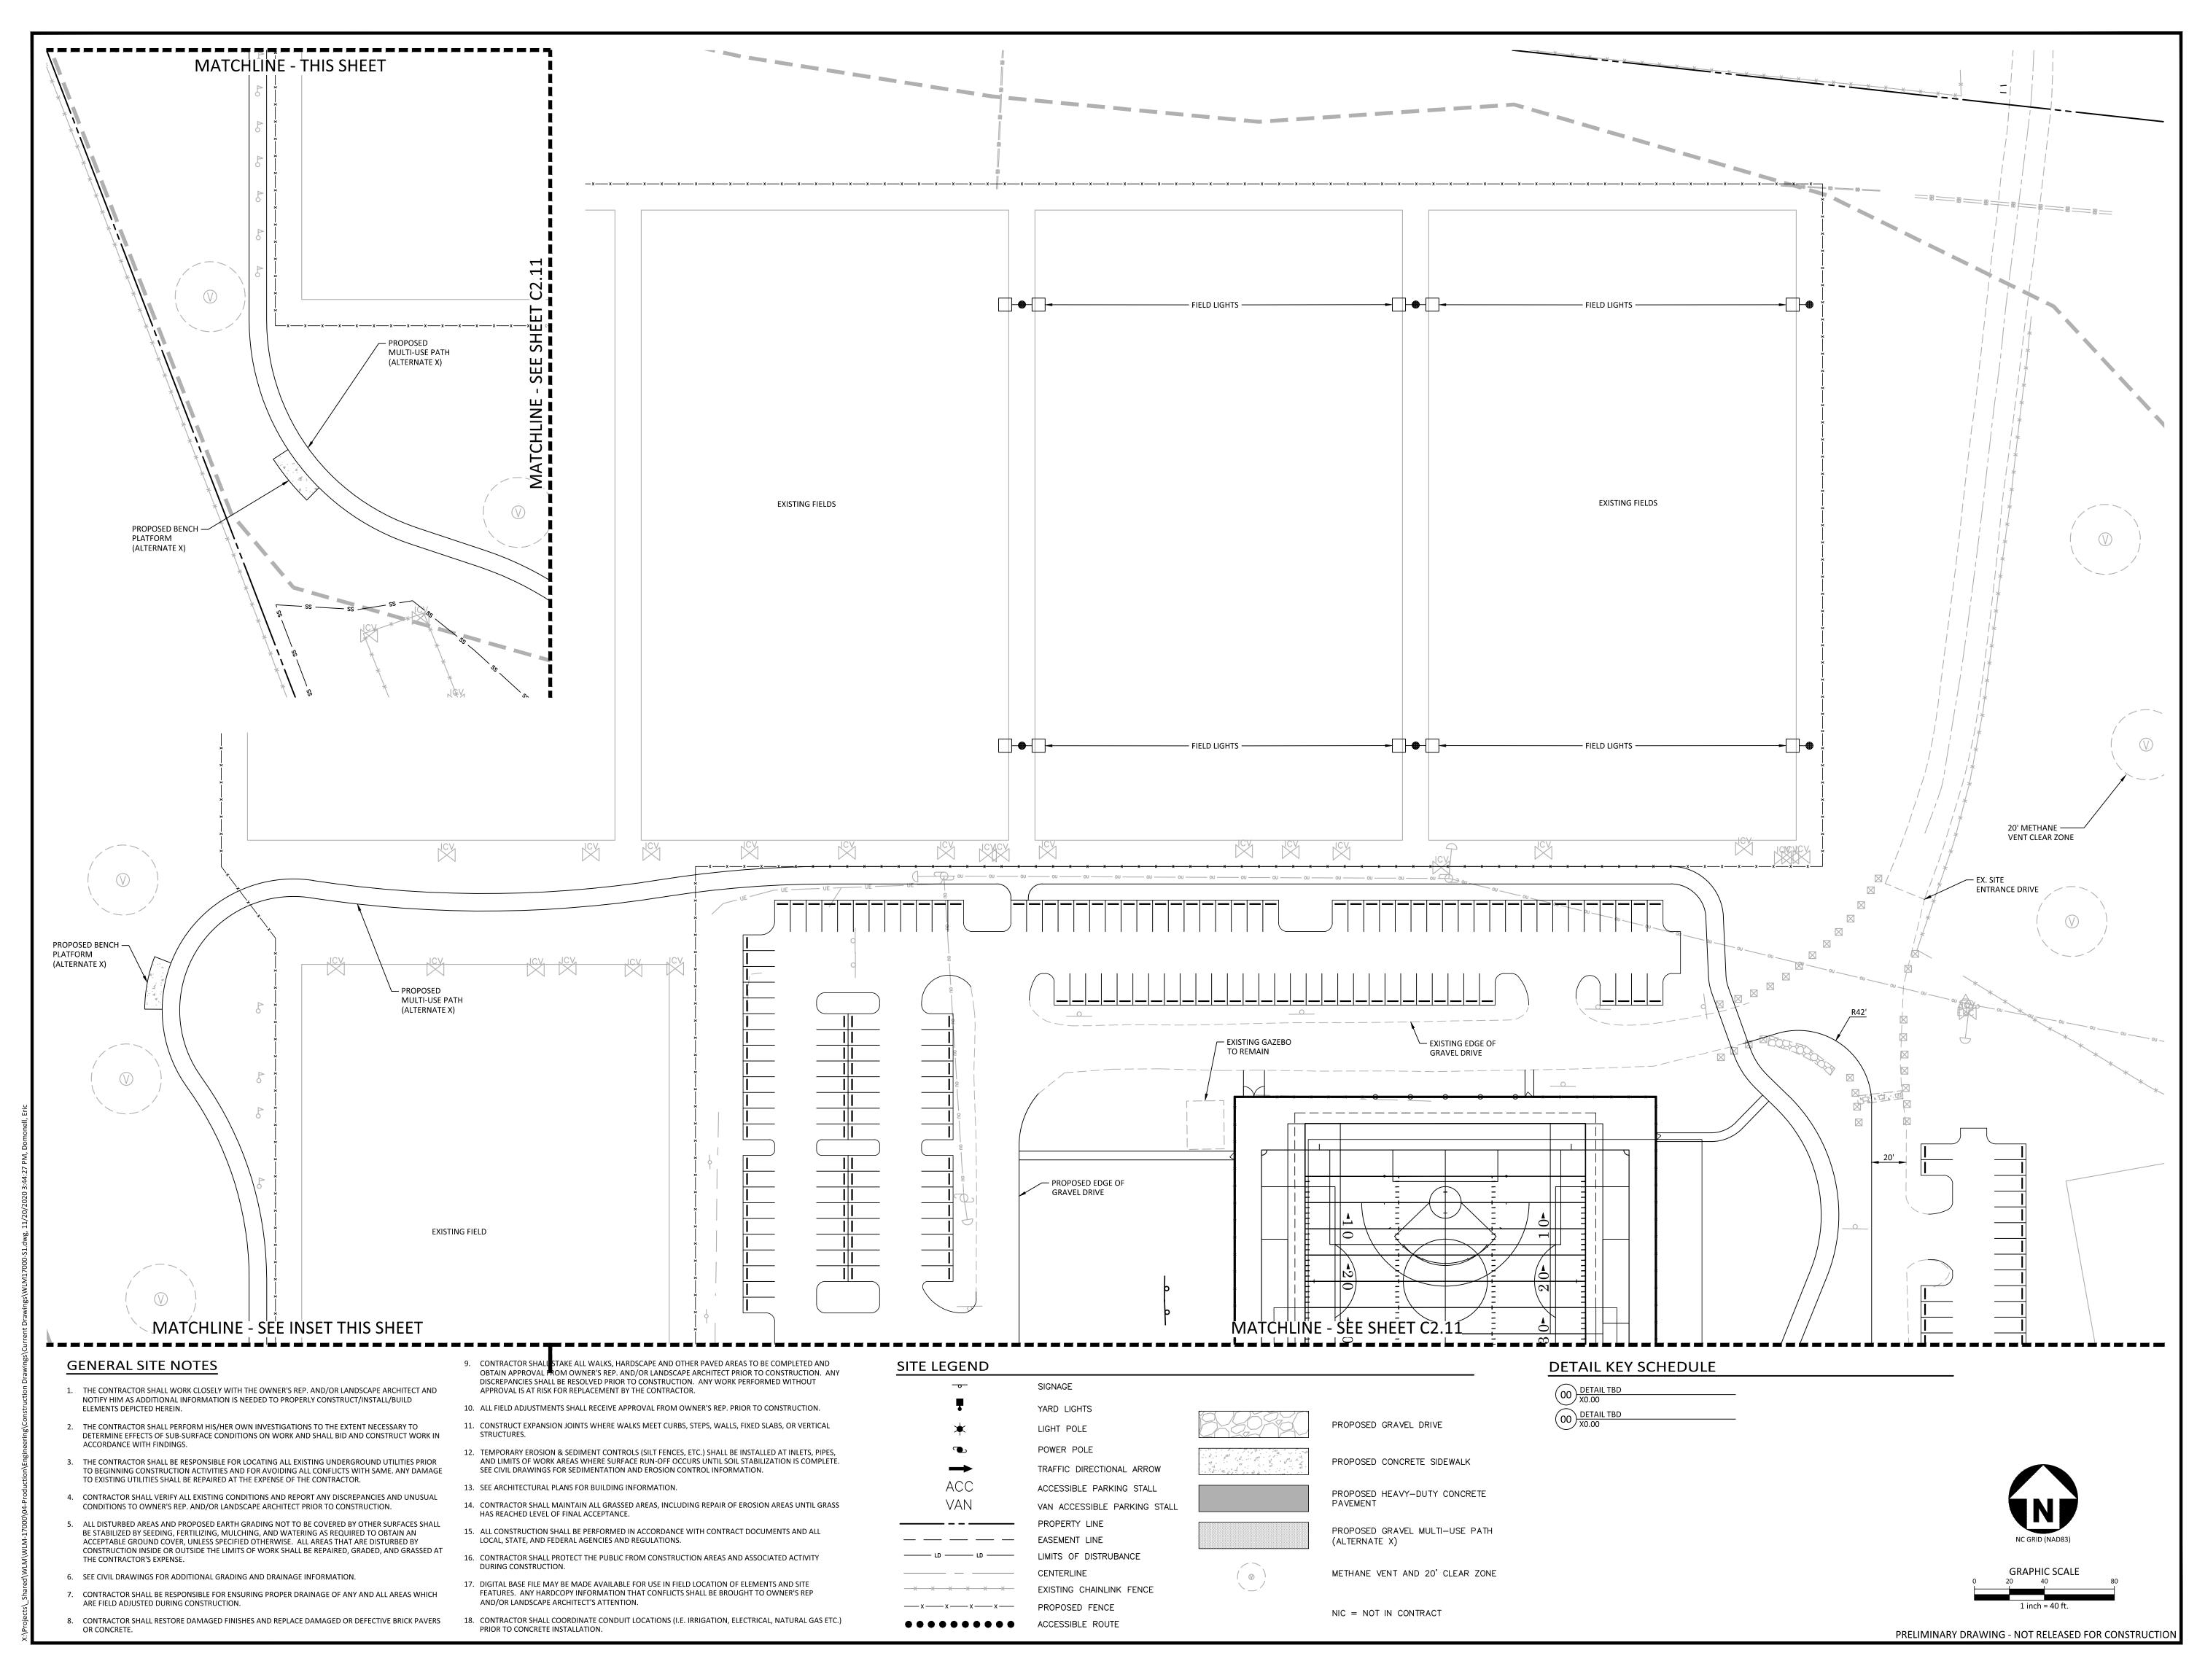- 1. ALL DIMENSIONS AND GRADES SHOWN ON THE PLANS SHALL BE FIELD VERIFIED BY THE CONTRACTOR PRIOR TO CONSTRUCTION. CONTRACTOR SHALL NOTIFY THE ENGINEER IF ANY DISCREPANCIES EXIST PRIOR TO PROCEEDING WITH CONSTRUCTION, FOR NECESSARY PLAN OR GRADE CHANGES. NO EXTRA COMPENSATION SHALL BE PAID TO THE CONTRACTOR FOR ANY WORK DONE DUE TO DIMENSIONS OR GRADES SHOWN INCORRECTLY ON THESE PLANS IF SUCH NOTIFICATION HAS NOT BEEN GIVEN.
- 2. OCCUPATIONAL SAFETY AND HEALTH ADMINISTRATION (OSHA) STANDARDS FOR EXCAVATIONS; FINAL RULE 29CFR PART 1926, SUBPART "P" APPLIES TO ALL EXCAVATIONS EXCEEDING FIVE (5) FEET IN DEPTH. EXCAVATION EXCEEDING TWENTY (20) FEET IN DEPTH REQUIRES THE DESIGN OF A TRENCH SAFETY SYSTEM BY A REGISTERED PROFESSIONAL ENGINEER, PROVIDED BY CONTRACTOR RESPONSIBLE FOR EXCAVATION.
- 3. CONTRACTOR SHALL NOTIFY "NC811" (811) OR (1-800-632-4949) AT LEAST 3 FULL BUSINESS DAYS PRIOR TO BEGINNING CONSTRUCTION OR EXCAVATION TO HAVE EXISTING UTILITIES LOCATED. CONTRACTOR SHALL CONTACT ANY LOCAL UTILITIES THAT PROVIDE THEIR OWN LOCATOR SERVICES INDEPENDENT OF "NC811". REPORT ANY DISCREPANCIES TO THE ENGINEER IMMEDIATELY.
- 4. A PRE-CONSTRUCTION CONFERENCE WILL BE HELD PRIOR TO ANY LAND DISTURBING ACTIVITY. AS DEEMED NECESSARY, THE OWNER, ENGINEER, CONTRACTOR, AND REPRESENTATIVES FROM NCDEQ WILL BE INVITED TO ATTEND THE MEETING. FOR NCDEQ REPRESENTATIVES, CONTACT DIVISION OF LAND QUALITY AT (910) 796-7215 PRIOR TO START OF CONSTRUCTION.
- 5. CONSTRUCTION, MAINTENANCE AND REMOVAL OF ALL EROSION CONTROL DEVICES ARE THE RESPONSIBILITY OF THE GENERAL CONTRACTOR. TIMING OF REMOVAL SHALL BE COORDINATED WITH THE EROSION CONTROL INSPECTOR.
- 6. EXISTING UTILITIES AND STRUCTURES SHOWN, BOTH UNDERGROUND AND ABOVE GROUND, ARE BASED ON A FIELD SURVEY AND THE BEST AVAILABLE RECORD DRAWINGS. THE CONTRACTOR SHALL VERIFY FIELD CONDITIONS PRIOR TO BEGINNING RELATED CONSTRUCTION. ANY DISCREPANCIES SHALL BE REPORTED TO THE ENGINEER IMMEDIATELY.
- 7. SOIL UNDER BUILDINGS, PAVED AREAS AND WITHIN SLOPES GREATER THAN 4:1 (H:V) SHALL BE APPROVED, PLACED AND COMPACTED AS RECOMMENDED BY THE GEOTECHNICAL ENGINEER.

#### STORM DRAINAGE NOTES:

- 1. ALL STORM DRAINAGE PIPES SHOWN SHALL BE REINFORCED CONCRETE (RCP) (MINIMUM CLASS III) UNLESS NOTED OTHERWISE. CONTRACTOR TO COORDINATE WITH THE GEOTECH TO VERIFY TYPE OF BEDDING REQUIRED BASED ON SOIL CONDITIONS. CONTRACTOR TO SELECT REQUIRED CLASS OF PIPE BASED ON DEPTH OF PIPE AND BEDDING PROVIDED PER THE AMERICAN CONCRETE PIPE ASSOCIATION GUIDELINES.
- 2. ALL STORM DRAINAGE CONSTRUCTION SHALL BE IN ACCORDANCE WITH THE LATEST CITY OF WILMINGTON STANDARDS.
- 3. ALL CONCRETE SHALL MEET A MINIMUM 3000 PSI COMPRESSIVE STRENGTH.
- 4. ALL PIPE JOINTS SHALL BE MADE WITH PREFORMED JOINT SEALER, WHICH CONFORMS TO AASHTO SPECIFICATION M-198 FOR TYPE B FLEXIBLE PLASTIC GASKETS UNLESS OTHERWISE NOTED.
- 5. ALL BACKFILL SHALL BE NON-PLASTIC IN NATURE, FREE FROM ROOTS, VEGETATION MATTER, WASTE CONSTRUCTION MATERIAL OR OTHER OBJECTIONABLE MATERIAL. SAID MATERIAL SHALL BE CAPABLE OF BEING COMPACTED BY MECHANICAL MEANS AND SHALL HAVE NO TENDENCY TO FLOW OR BEHAVE IN A PLASTIC MANNER UNDER THE TAMPING BLOWS OR PROOF ROLLING.
- 6. MATERIALS DEEMED BY THE OWNER'S REPRESENTATIVE AS UNSUITABLE FOR BACKFILL PURPOSES SHALL BE REMOVED AND REPLACED WITH SUITABLE MATERIAL.
- 7. BACKFILLING OF TRENCHES SHALL BE ACCOMPLISHED IMMEDIATELY AFTER PIPE IS LAID. THE FILL AROUND THE PIPE SHALL BE THOROUGHLY COMPACTED TO 95% OF THE MAXIMUM DRY DENSITY OBTAINABLE WITH THE STANDARD PROCTOR TEST. THE TOP EIGHT (8) INCHES SHALL BE COMPACTED TO 100 PERCENT STANDARD PROCTOR.
- 8. UNDER NO CIRCUMSTANCES SHALL WATER BE ALLOWED TO RISE IN UNBACKFILLED TRENCHES AFTER PIPE HAS BEEN PLACED.
- 9. IF THE USE OF WAFFLE BOXES ARE ALLOWED AT THIS SITE, ALL PENETRATIONS FOR STORM DRAINAGE PIPES MUST BE MADE WITHIN THE KNOCK-OUT PORTION OF THE BOX AND NOT AT THE CORNERS WHERE THE STRUCTURAL INTEGRITY MAY BE COMPROMISED.

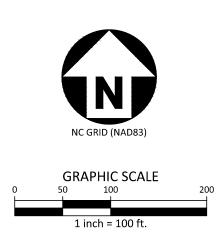



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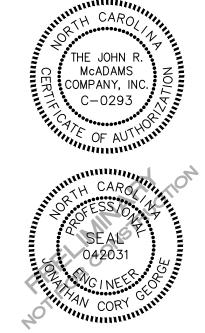
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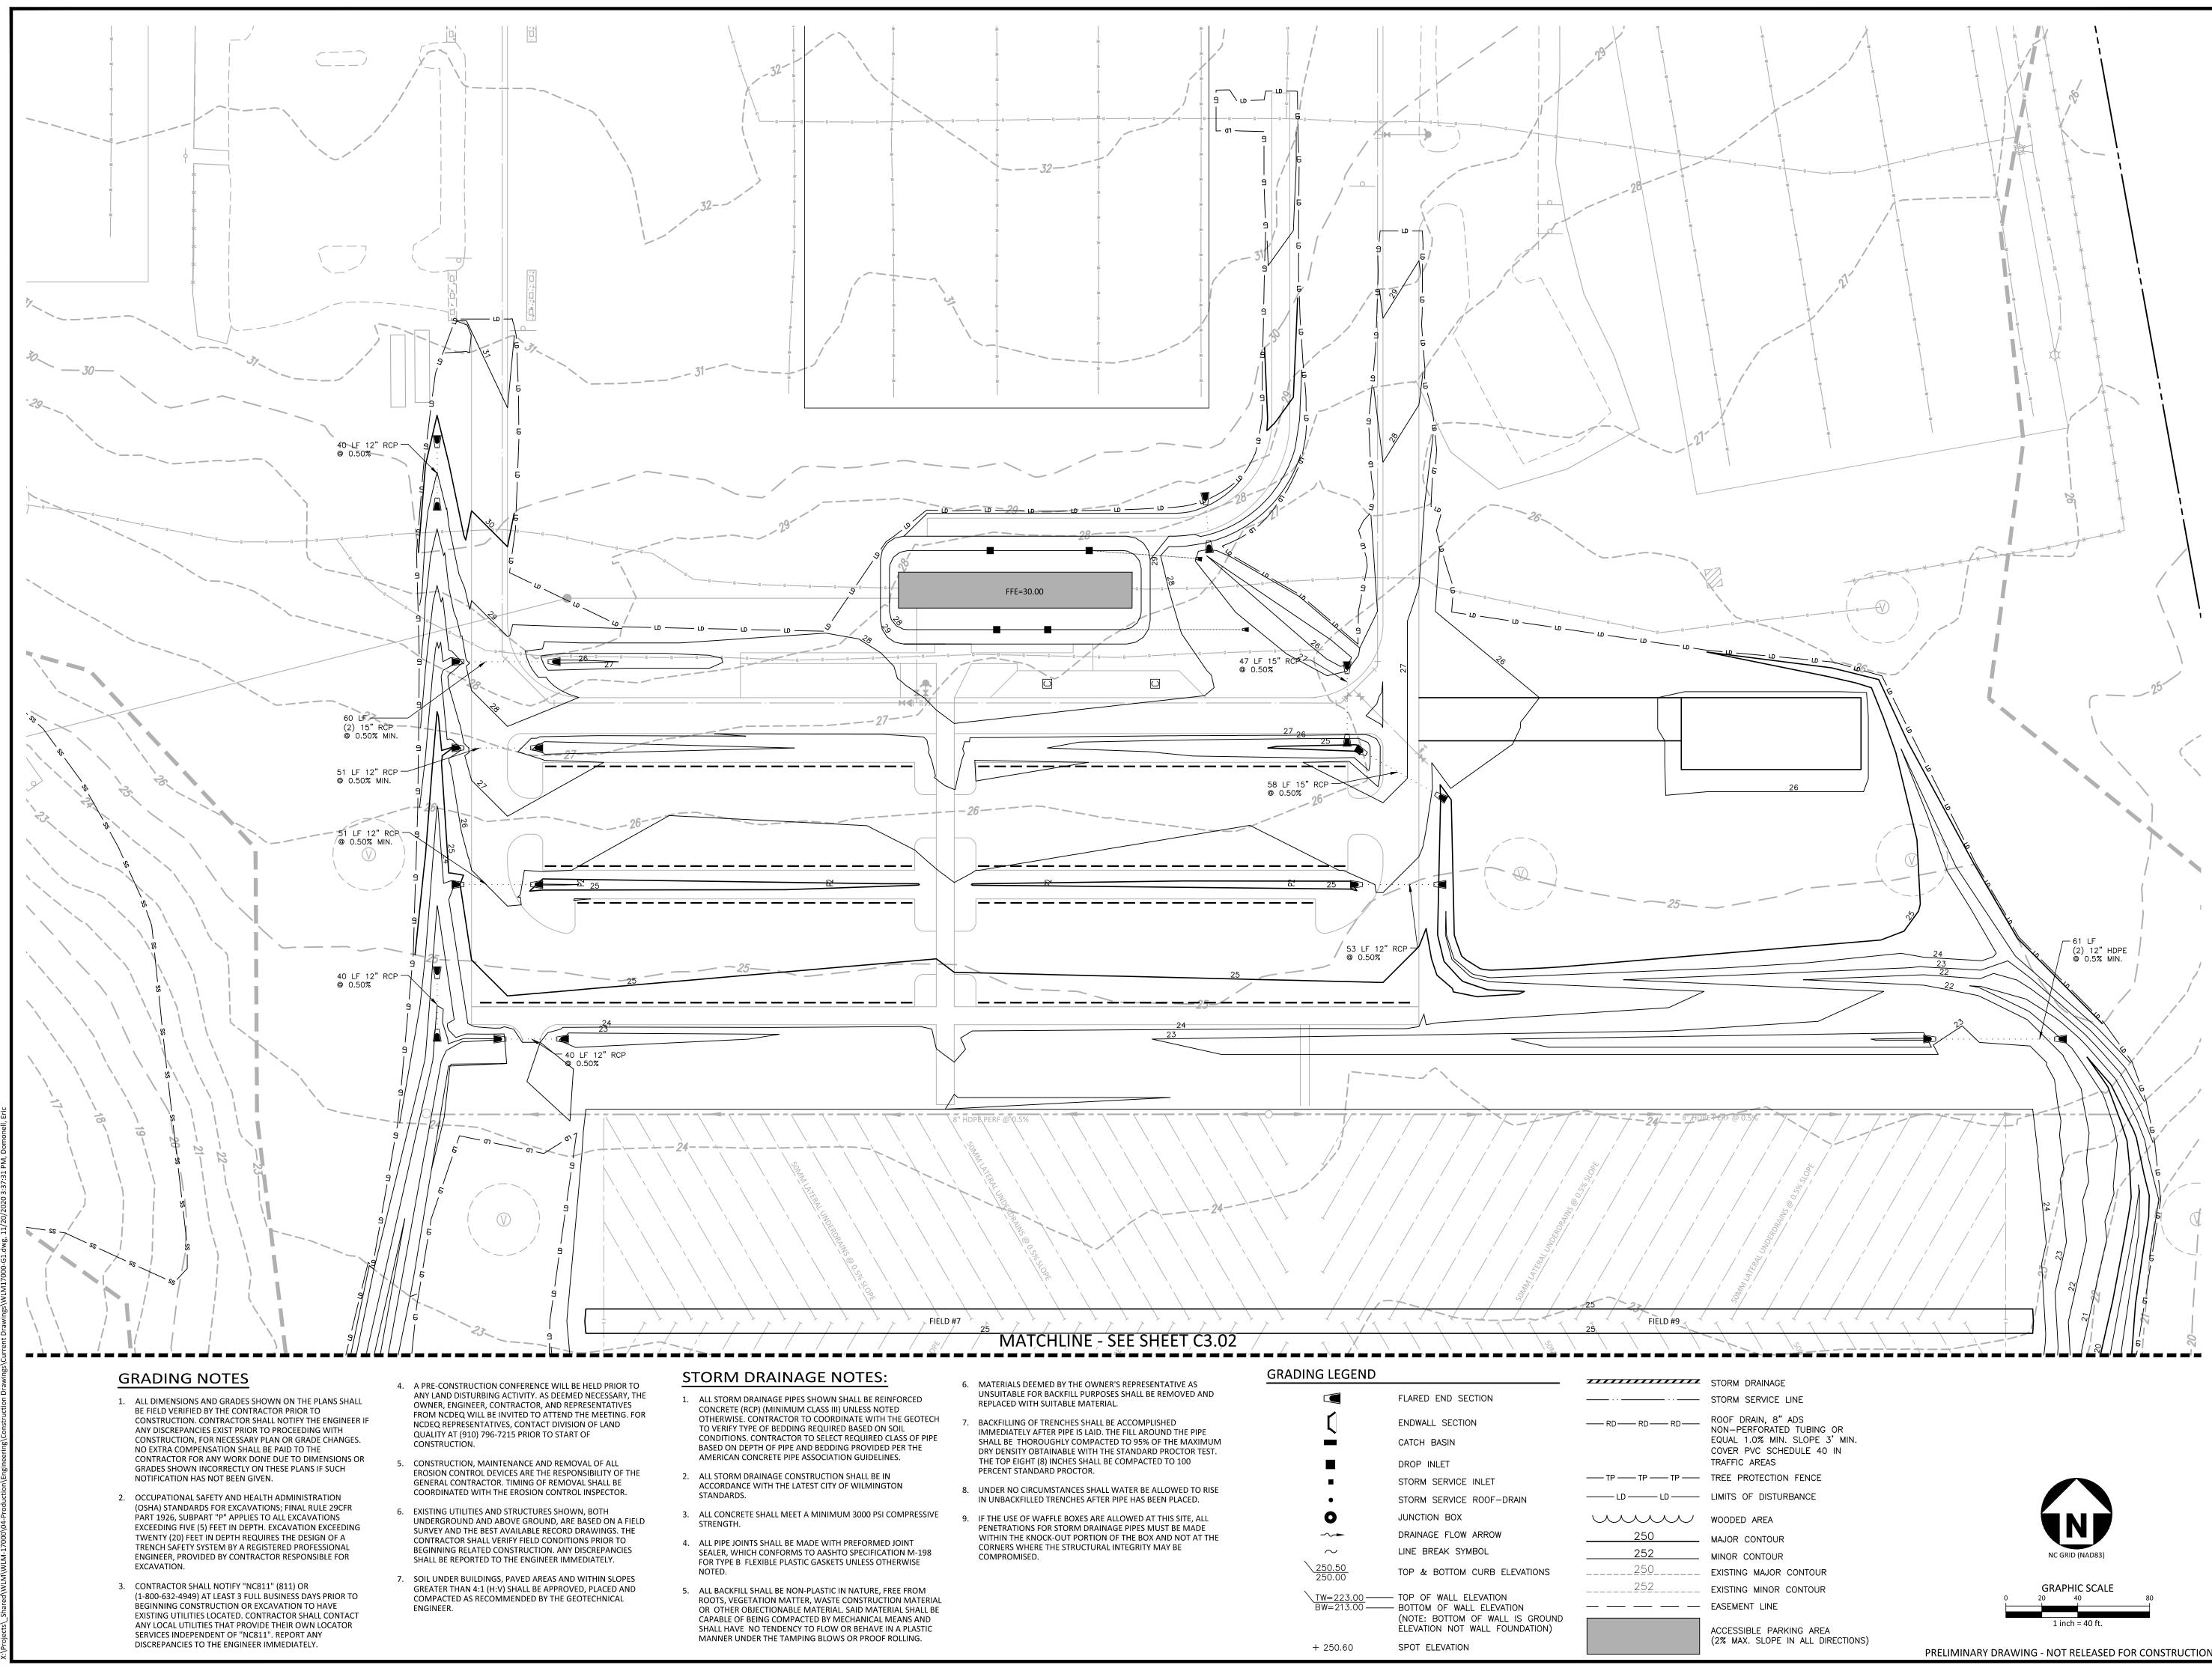


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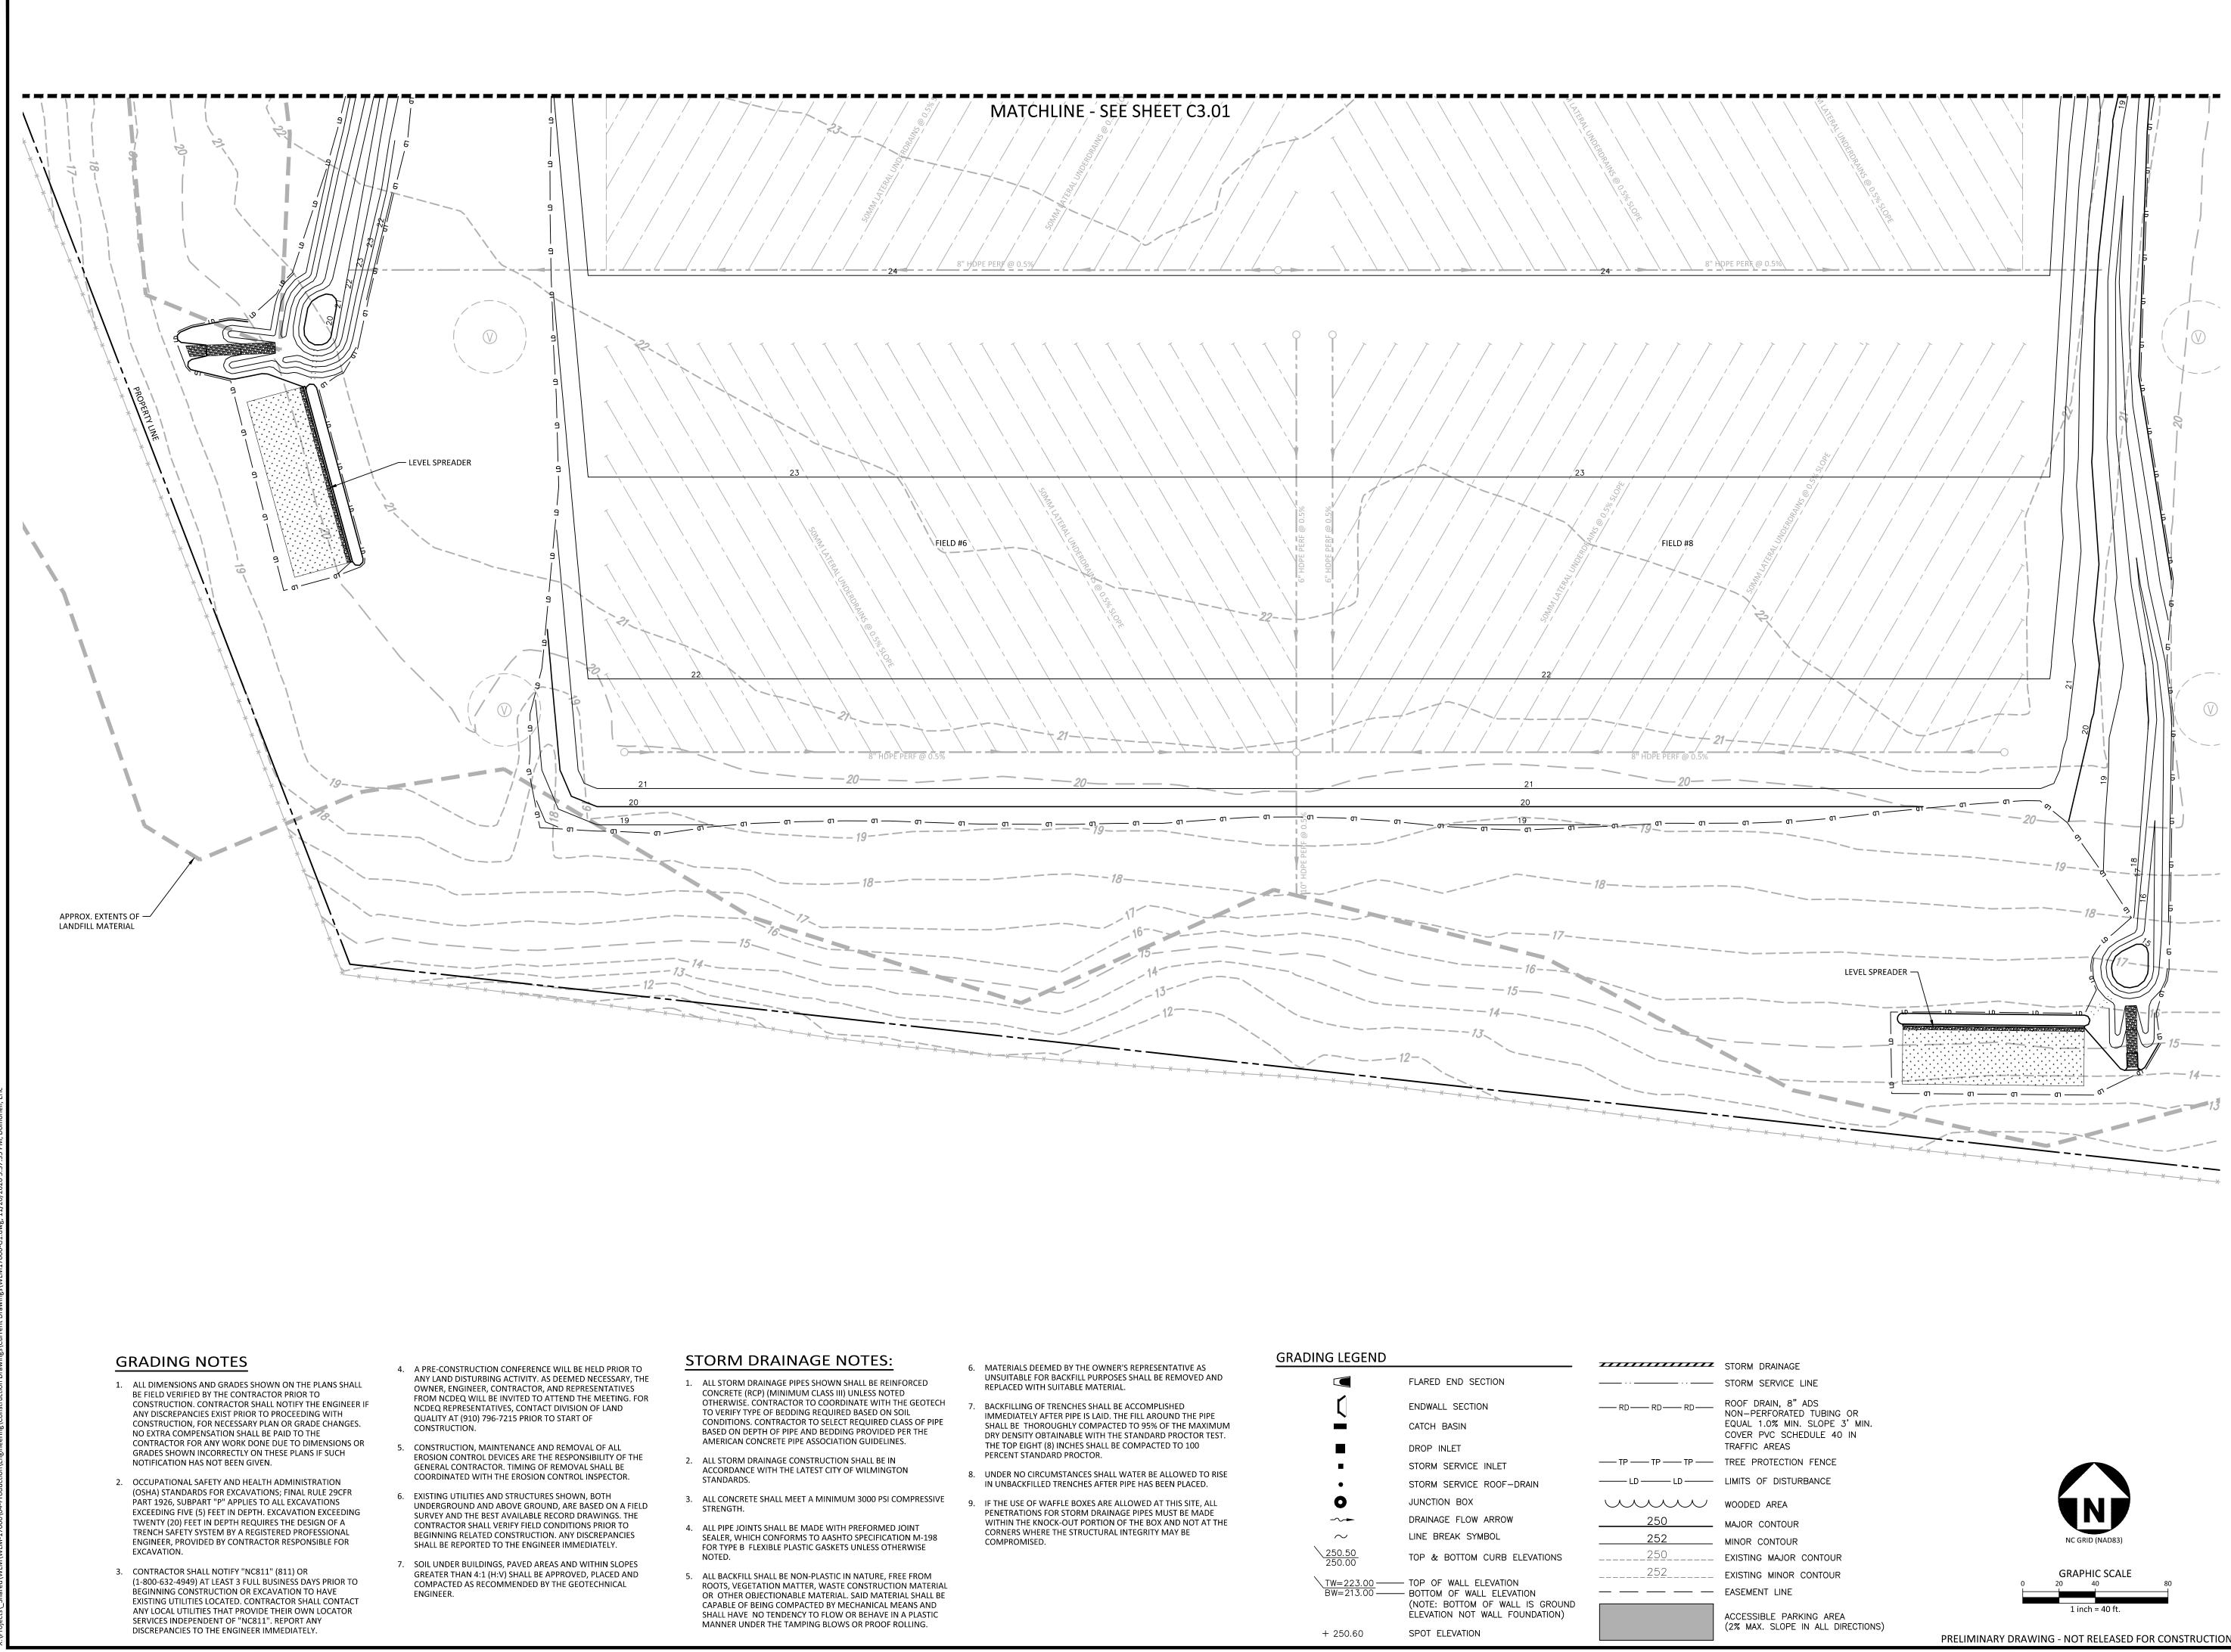




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**GRADING PLAN - AREA B BASE BID** 



	FLARED END SECTION	<u> </u>
(	ENDWALL SECTION	
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	DROP INLET	
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•	STORM SERVICE ROOF-DRAIN	LD LD -
0	JUNCTION BOX	uuu
-~-	DRAINAGE FLOW ARROW	250
$\sim$	LINE BREAK SYMBOL	252
<u>250.50</u> 250.00	TOP & BOTTOM CURB ELEVATIONS	250
TW=223.00 BW=213.00	— TOP OF WALL ELEVATION — BOTTOM OF WALL ELEVATION (NOTE: BOTTOM OF WALL IS GROUND ELEVATION NOT WALL FOUNDATION)	<u>252</u>
± 250.60		



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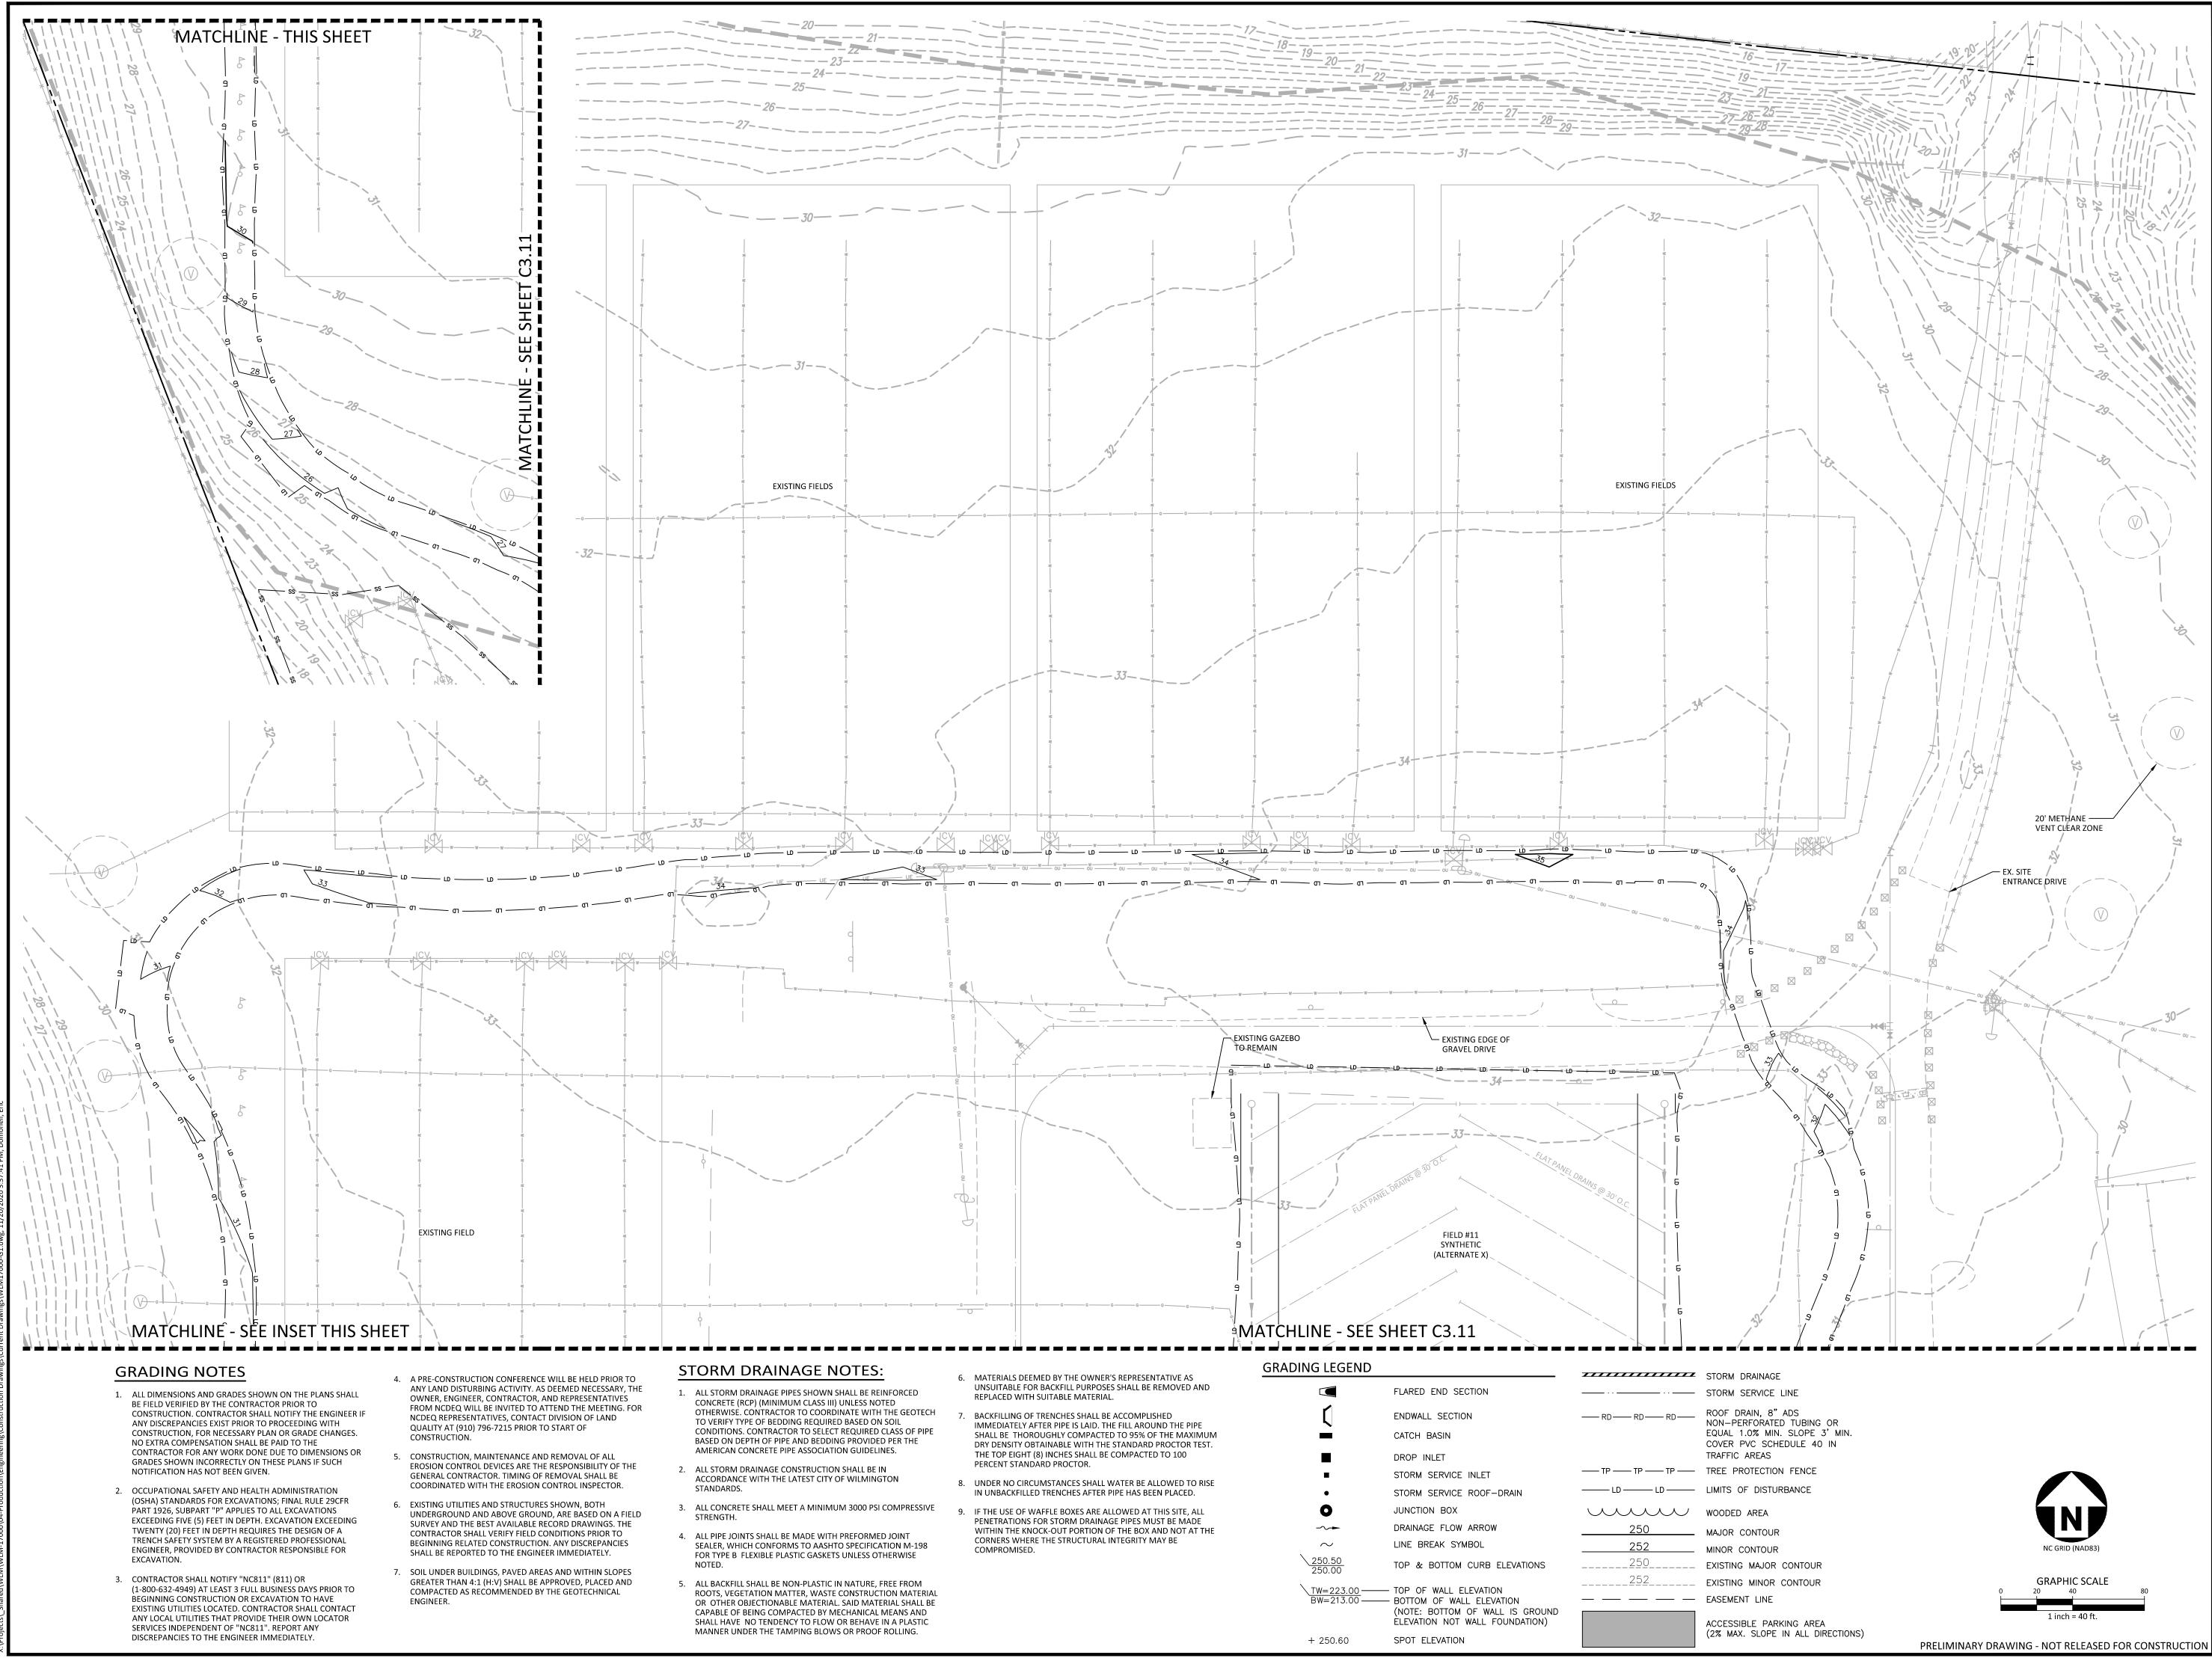
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**GRADING PLAN - AREA C BASE BID** 





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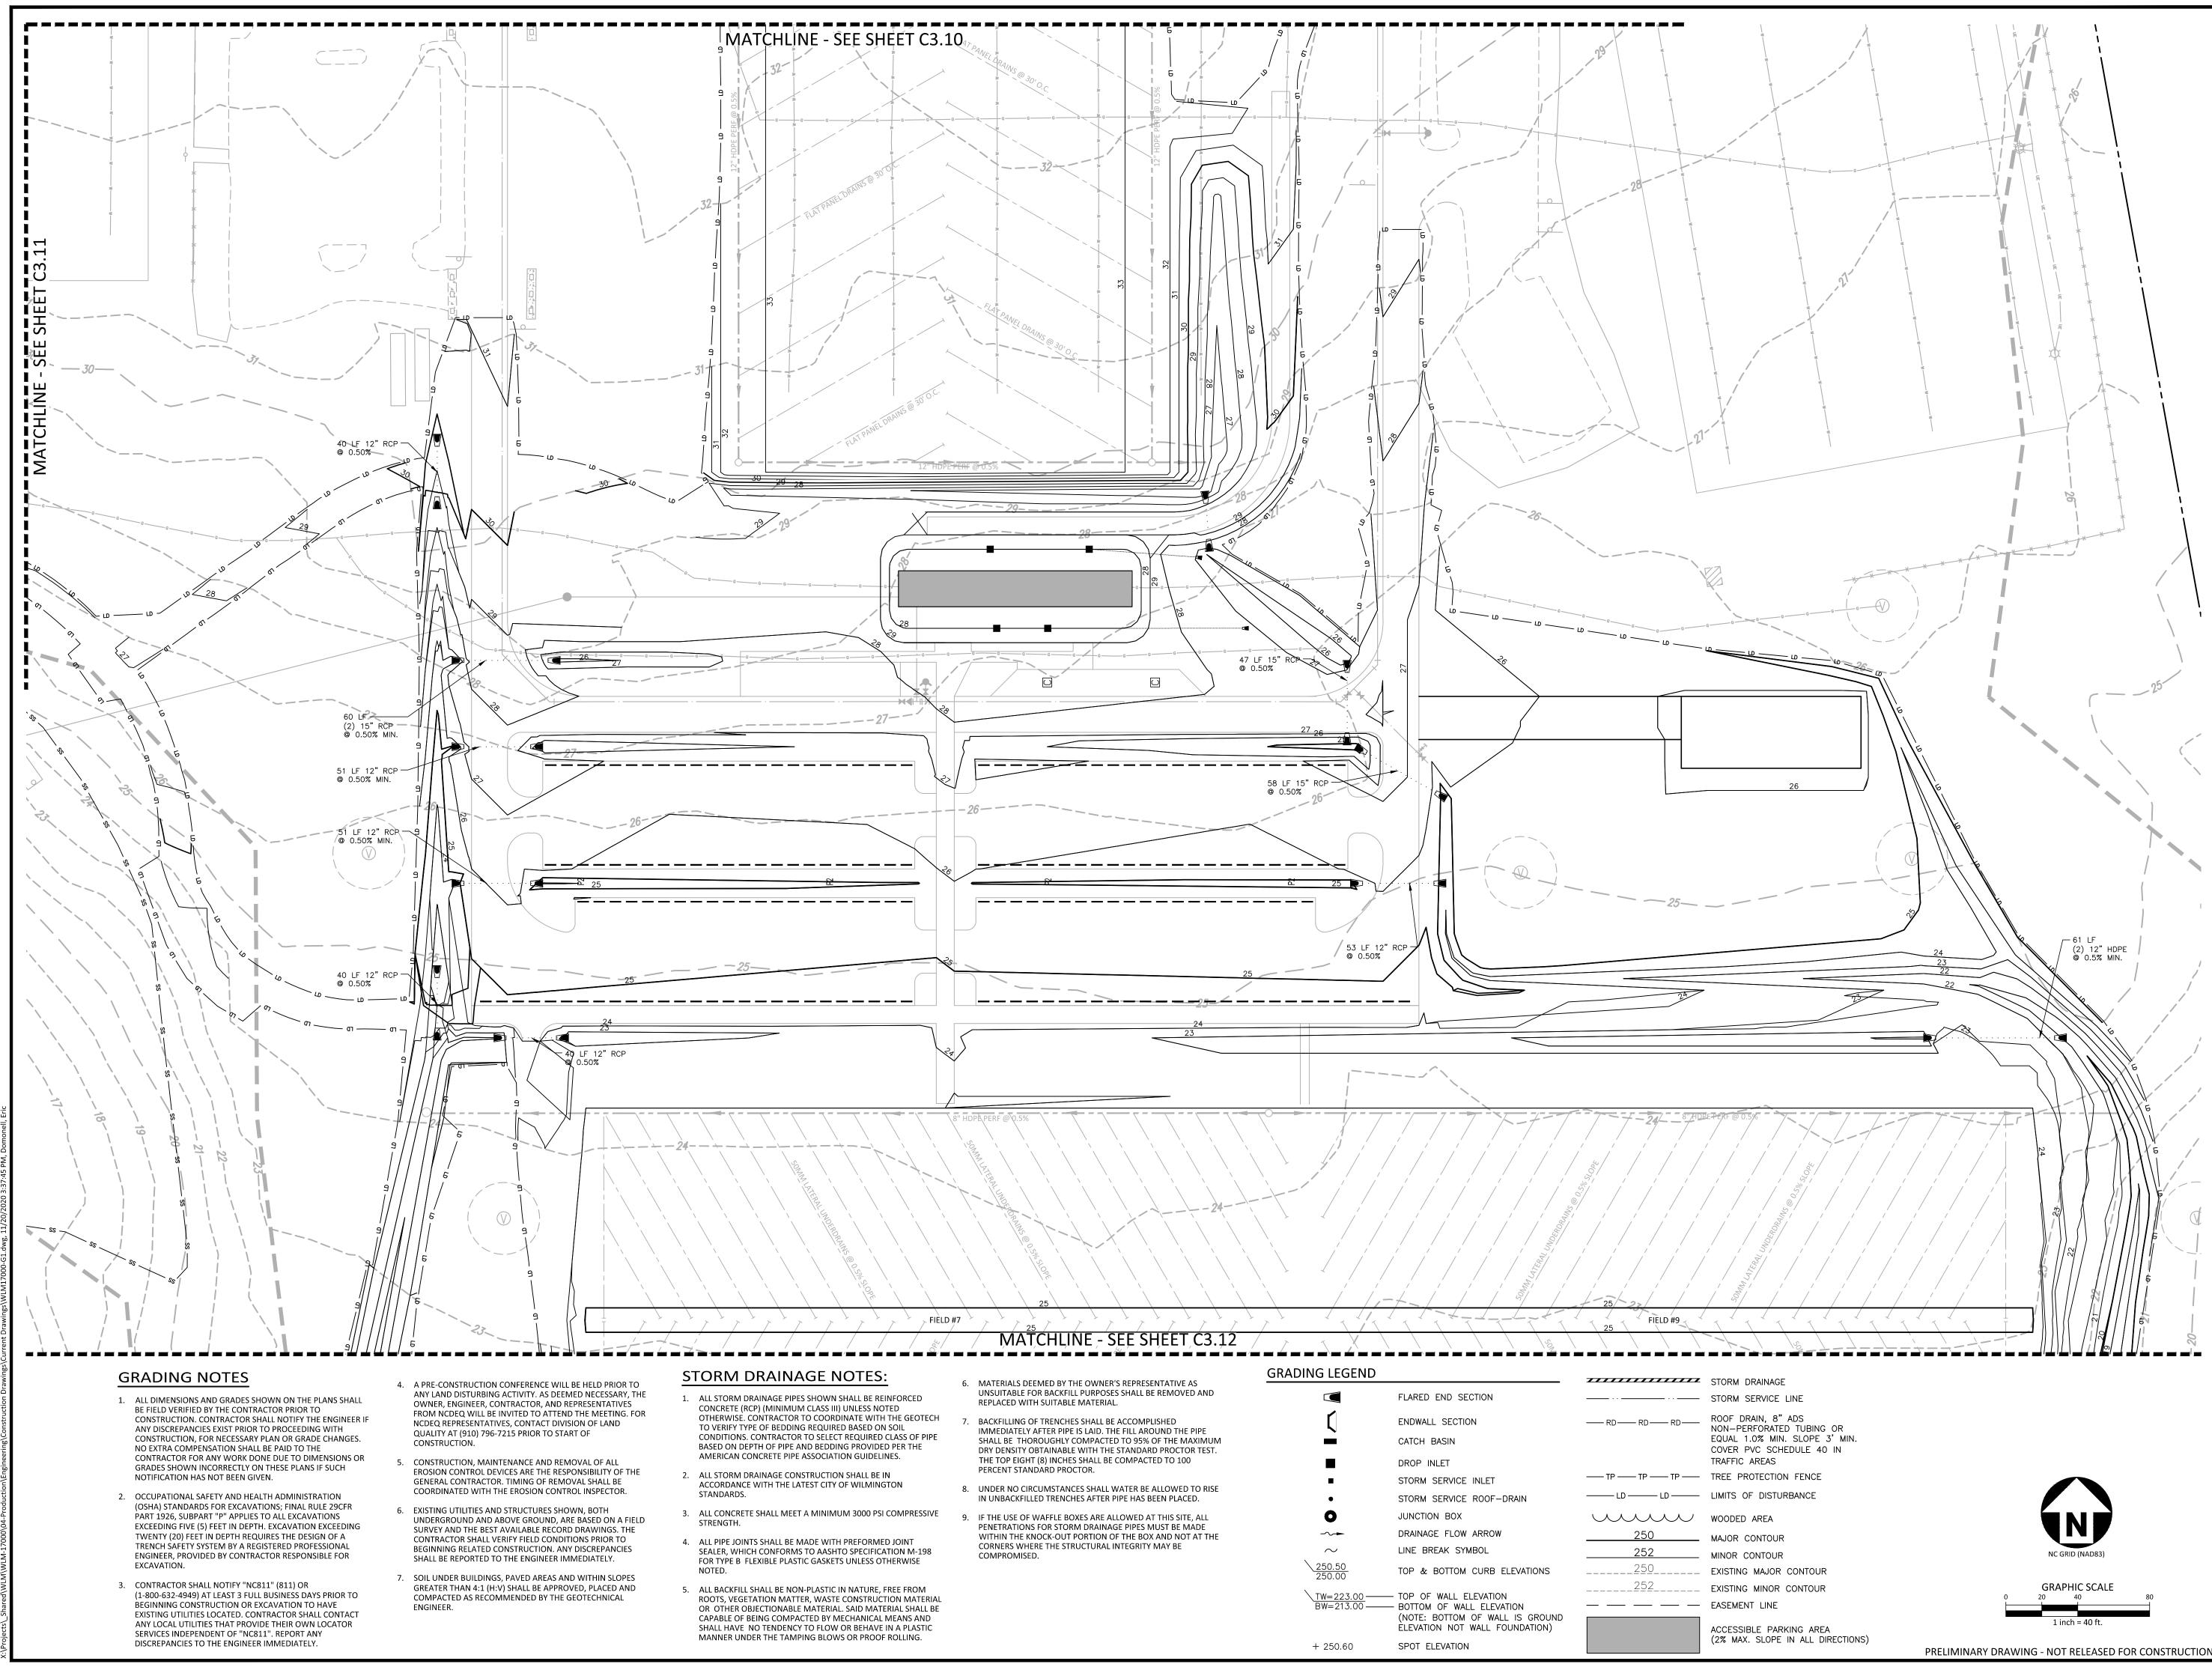




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**GRADING PLAN - AREA A** ALTERNATE



I-PLASTIC IN NATURE, FREE FROM
ER, WASTE CONSTRUCTION MATERIAL
MATERIAL. SAID MATERIAL SHALL BE
CTED BY MECHANICAL MEANS AND
TO FLOW OR BEHAVE IN A PLASTIC




phone 919. 361. 5000 fax 919. 361. 2269 license number: C-0293, C-187

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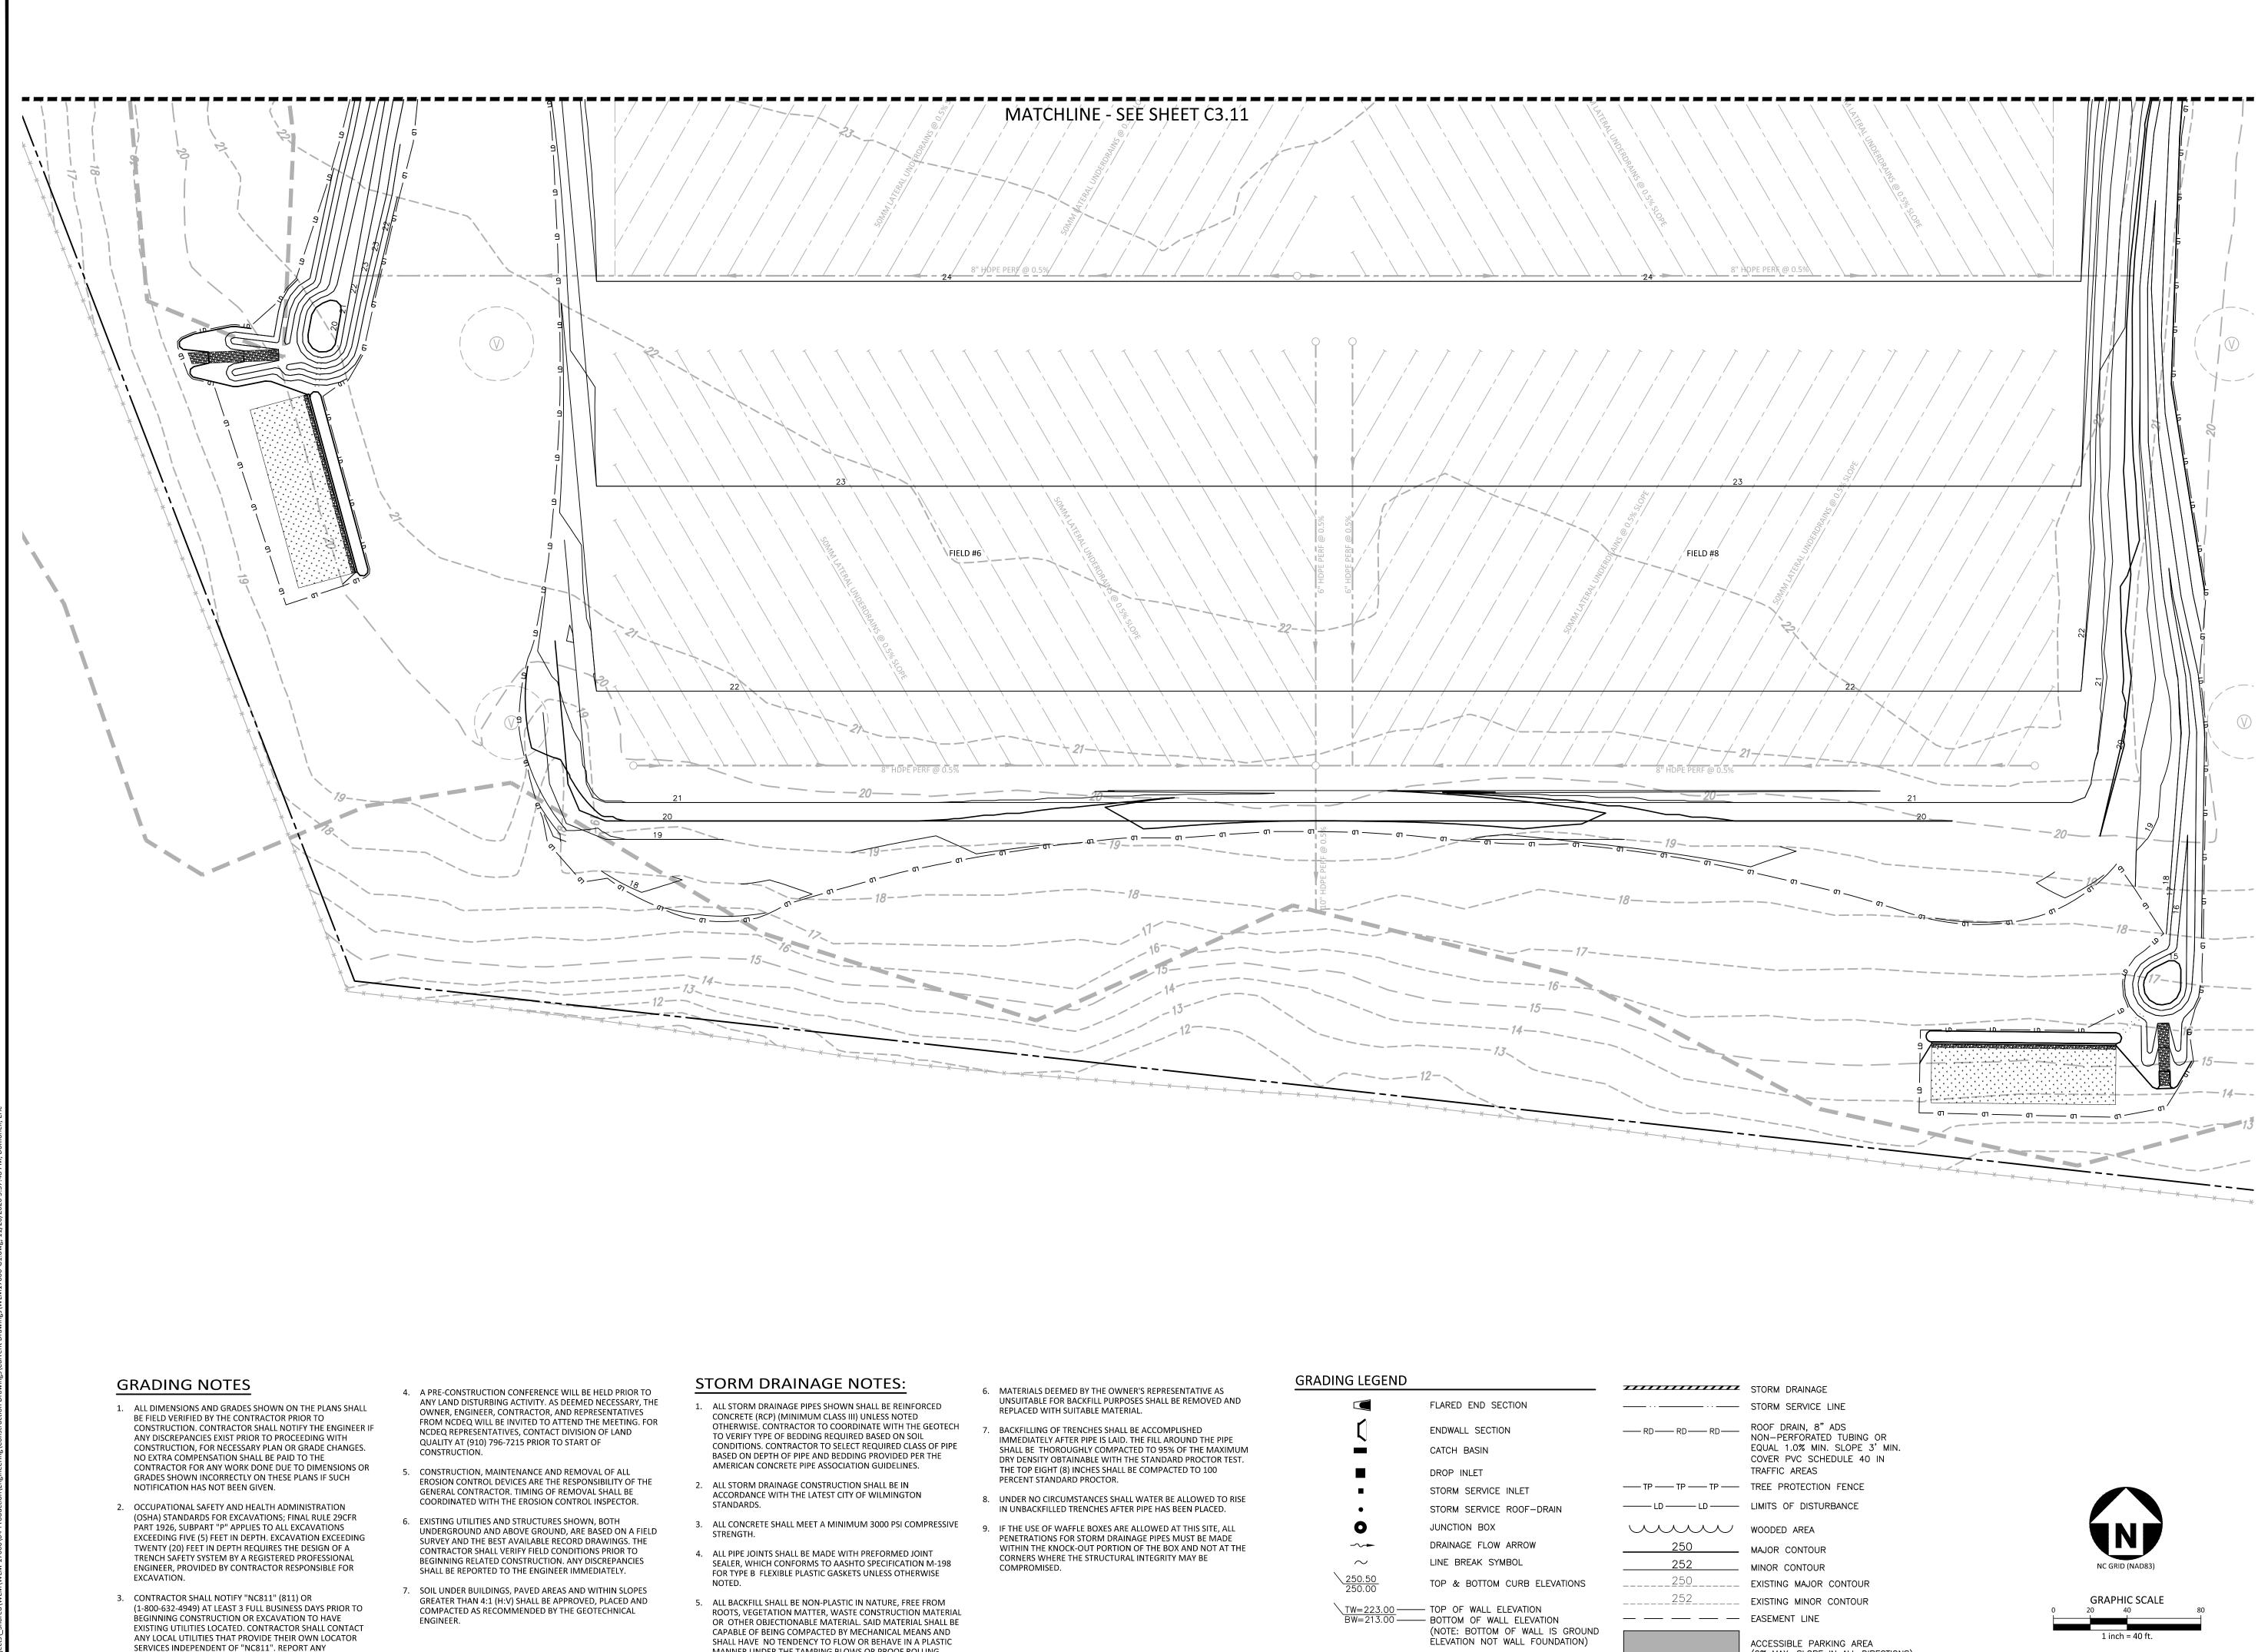
CITY OF WILMINGTON 305 CHESTNUT STREET, 5TH FLOOR WILMINGTON, NC 28402 PHONE: 910. 341. 7830





date <b>SHEET</b>	11.11.20
SCALE	1'' = 40'
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FILENAME	WLM17000-G1
PROJECT NO.	WLM-17000

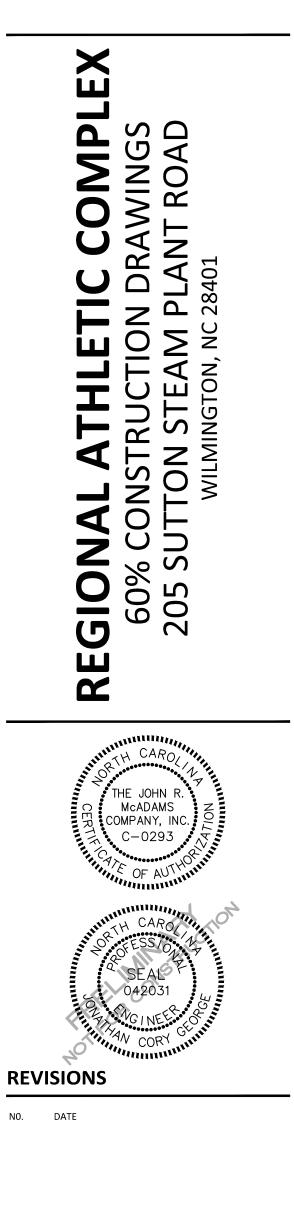



DISCREPANCIES TO THE ENGINEER IMMEDIATELY.

- MANNER UNDER THE TAMPING BLOWS OR PROOF ROLLING.

	FLARED END SECTION	
(	ENDWALL SECTION	
	CATCH BASIN	
	DROP INLET	
-	STORM SERVICE INLET	TP TP TF
•	STORM SERVICE ROOF-DRAIN	——— LD ——— LD —
0	JUNCTION BOX	uuu
~~	DRAINAGE FLOW ARROW	250
$\sim$	LINE BREAK SYMBOL	252
<u>250.50</u> 250.00	TOP & BOTTOM CURB ELEVATIONS	250
TW=223.00 BW=213.00	<ul> <li>TOP OF WALL ELEVATION</li> <li>BOTTOM OF WALL ELEVATION</li> <li>(NOTE: BOTTOM OF WALL IS GROUND</li> <li>ELEVATION NOT WALL FOUNDATION)</li> </ul>	252 
+ 250.60	SPOT ELEVATION	

ACCESSIBLE PARKING AREA (2% MAX. SLOPE IN ALL DIRECTIONS)

PRELIMINARY DRAWING - NOT RELEASED FOR CONSTRUCTION



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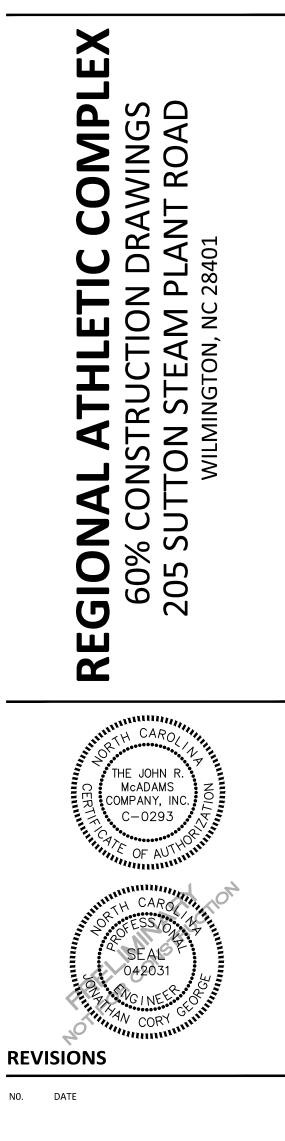
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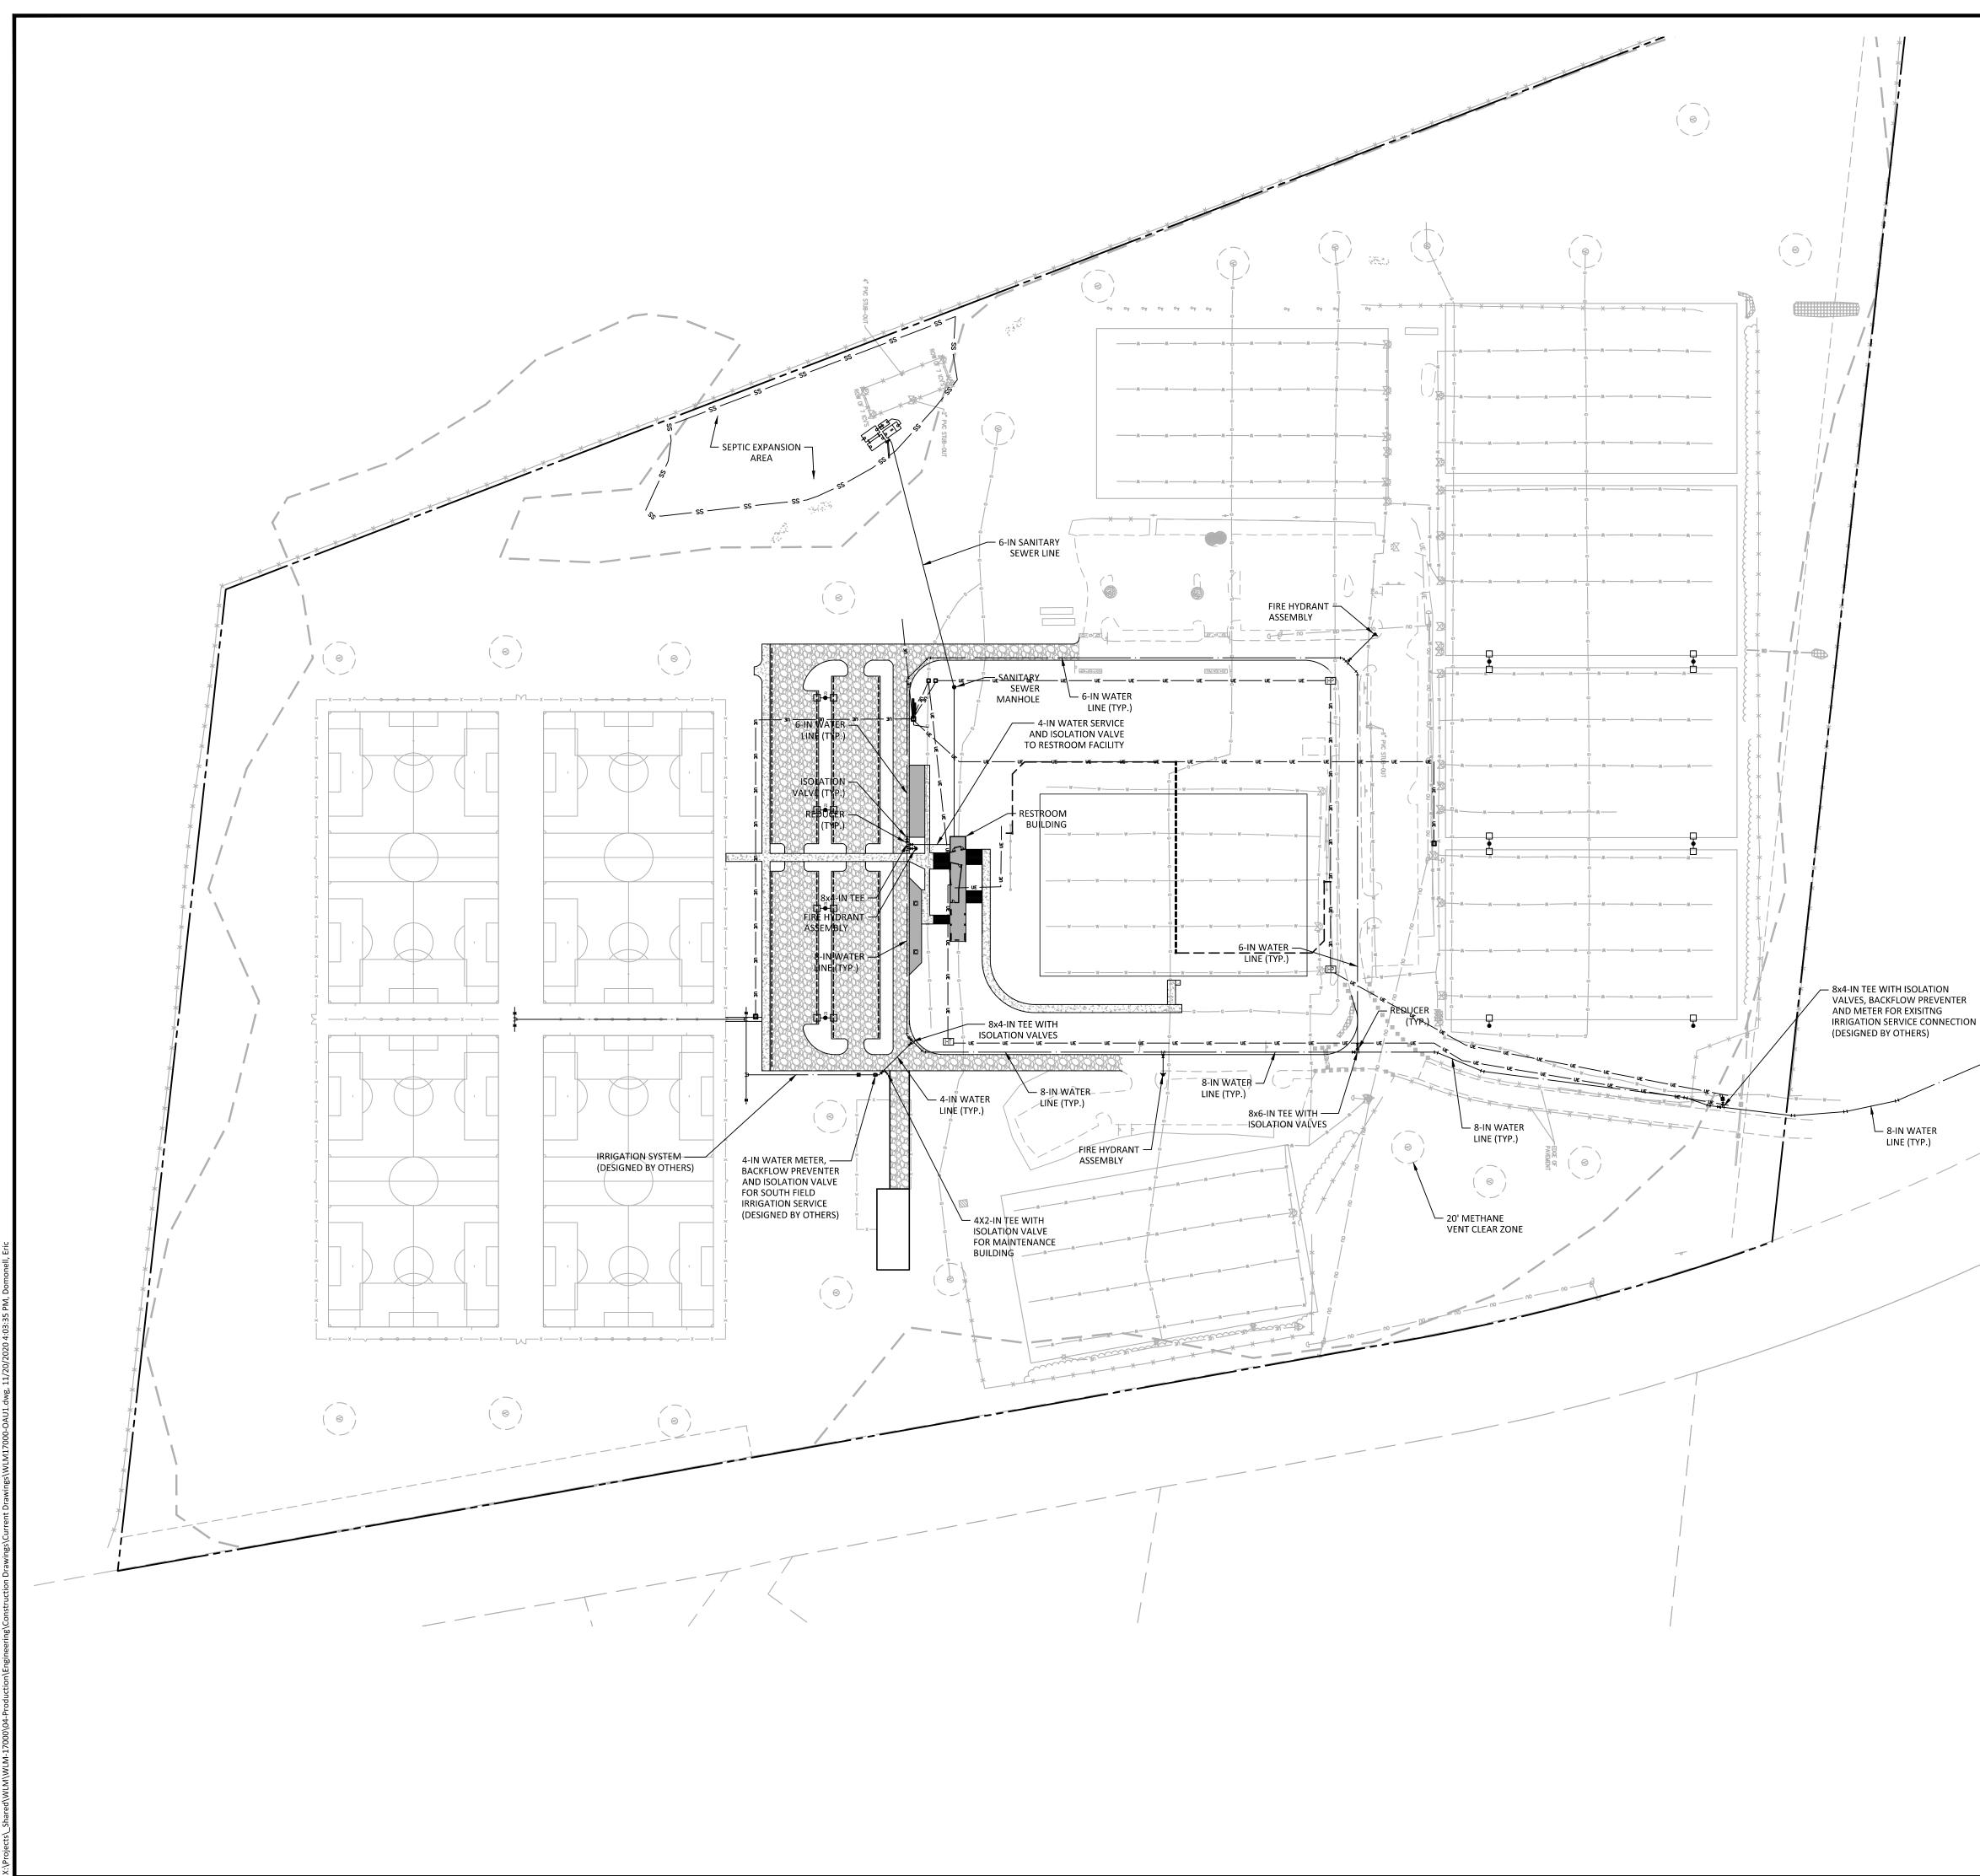
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#### UTILITY LEGEND


<b>→ → →</b>	FIRE HYDRANT ASSEMBLY
₩	FIRE DEPARTMENT CONNECTION (FDC)
	WATER METER
M	WATER VALVE
Ν	BACKFLOW PREVENTER
•	REDUCER
	PLUG
•	SEWER CLEAN-OUT
• •	GREASE TRAP
>	SEWER FLOW DIRECTION ARROW
	WATERLINE
	WATER SERVICE LINE
	UTILITY SLEEVE
	SEWER SERVICE LINE
——— FM——— FM———	SEWER FORCE MAIN
GGG	GAS LINE
OU OU	OVERHEAD UTILITY
UE UE	UNDERGROUND ELECTRIC
TTT	TELEPHONE
	FIELD RUNOFF

#### **GENERAL NOTES:**

- 1. THE CONTRACTOR SHALL BE RESPONSIBLE FOR ANY DAMAGE TO GAS OR WATER PIPES, PUBLIC OR PRIVATE SEWERS, DRAINS OR CULVERTS, RAILROAD OR TRAFFIC SIGNAL CABLES, TELEPHONE OR POWER CONDUITS, OR OTHER STRUCTURES. WHEN UTILITY LINES THAT ARE TO BE REMOVED ARE ENCOUNTERED WITHIN THE AREA OF OPERATIONS, THE CONTRACTOR SHALL NOTIFY THE OWNER'S REPRESENTATIVE WITH AMPLE TIME FOR THE NECESSARY MEASURES TO BE TAKEN TO PREVENT INTERRUPTION OF THE SERVICES. REASONABLE CARE HAS BEEN EXERCISED IN SHOWING THE LOCATION OF EXISTING UTILITIES ON THE PLANS. THE EXACT LOCATION OF SUCH UTILITIES IS NOT KNOWN IN ALL CASES. THE CONTRACTOR SHALL EXPLORE THE AREA AHEAD OF THE GRADING OPERATION BY OBSERVATIONS, ELECTRONIC DEVICES, AND BY PERSONAL CONTACTS WITH UTILITY COMPANIES, AND LOCATE SUCH UTILITIES IN ADVANCE OF THE TRENCHING OR GRADING OPERATIONS, AND SHALL CONDUCT HIS WORK SO AS TO ELIMINATE OR MINIMIZE DAMAGE TO THE EXISTING STRUCTURES OR UTILITIES.
- 2. THE GENERAL CONTRACTOR SHALL BE RESPONSIBLE FOR CONFORMANCE WITH ALL CURRENT LOCAL, STATE, AND OSHA SAFETY CODES DURING ALL PHASES OF THE WORK. CONTRACT PRICES ESTABLISHED FOR THE WORK SHALL INCLUDE COSTS ASSOCIATED WITH THE PROVISION OF SAFETY EQUIPMENT, AND PERSONNEL NECESSARY TO COMPLETE THE WORK, INCLUDING, BUT NOT LIMITED TO, TRENCH BRACING, AND PERSONNEL LICENSED BY OSHA AS COMPETENT FOR EVALUATING SOIL STABILITY.
- 3. ALL DISTURBED AREAS SHALL BE RESTORED TO EXISTING OR BETTER CONDITIONS AT NO ADDITIONAL EXPENSE TO THE OWNER.
- 4. CONTRACTOR SHALL DETERMINE THE EXACT LOCATION OF EXISTING 8" WATER LINE PRIOR TO TIE-IN AND NOTIFY THE ENGINEER OF ANY DISCREPANCIES.

#### UTILITY NOTES:

- 1. ALL SITE WATER & SEWER IMPROVEMENTS SHALL BE IN ACCORDANCE WITH THE LATEST STANDARDS AND SPECIFICATIONS OF THE CAPE FEAR PUBLIC UTILITY AUTHORITY (CFPUA). CONTRACTOR SHALL COORDINATE WITH CFPUA PERSONNEL ON THE TIMING FOR TIE-IN TO EXISTING WATER LINE.
- 2. WATER LINE SHALL HAVE A MINIMUM COVER OF 36" FROM FINISHED GROUND.
- 3. THE LOCATIONS INDICATED FOR WATER AND SEWER TO ENTER THE BUILDINGS ARE APPROXIMATE. THE CONTRACTOR SHALL REFER TO PLUMBING PLANS FOR THE EXACT LOCATION OF TIE-IN OR EXTENSIONS INTO THE BUILDINGS AND PROVIDE ADAPTERS AS NECESSARY.
- 4. THE CONTRACTOR SHALL VERIFY THE LOCATIONS, BOTH HORIZONTALLY AND VERTICALLY, OF ALL EXISTING UNDERGROUND UTILITIES PRIOR TO WATER AND SEWER LINE INSTALLATION. ANY CONFLICTS OR DISCREPANCIES SHOULD BE BROUGHT TO THE ATTENTION TO THE ENGINEER IMMEDIATELY.
- 5. CONTRACTOR SHALL REPAIR ANY UTILITY OR STRUCTURE DAMAGED DUE TO CONSTRUCTION AT NO EXPENSE TO THE OWNER. ANY REPAIRS SHALL BE COORDINATED WITH THE UTILITY OWNER AND ENGINEER.
- 6. ALL NEW BACKFLOW DEVICES SHALL BE IN ACCORDANCE WITH CAPE FEAR PUBLIC UTILITY AUTHORITY DETAILS AND SPECIFICATIONS. HOT BOX SIZE SHALL BE BASED ON RPDA SELECTED.
- 7. CLEANOUTS LOCATED IN PAVEMENT OR OTHER TRAFFIC AREAS TO BE LOAD BEARING. 8. ALL UNDERGROUND LINES OUTSIDE THE BUILDING FOOTPRINT, EXCEPT LAWN
- IRRIGATION LINES, SHALL HAVE A WARNING TAPE INSTALLED IN THE BACKFILL BETWEEN 6 INCHES TO 24 INCHES BELOW FINISHED GRADE DIRECTLY OVER PIPING.
- 8.1. METALLIC LINES SHALL BE IDENTIFIED WITH DURABLE PRINTED PLASTIC WARNING TAPES, MINIMUM 3 INCHES WIDE WITH LETTERING TO IDENTIFY BURIED LINE BELOW.
- 8.2. NON-METALLIC PIPES, OTHER THAN GAS LINES, SHALL BE IDENTIFIED BY DETECTABLE WARNING TAPE, MINIMUM 2 INCHES WIDE, WITH LETTERING TO IDENTIFY BURIED LINE BELOW.
- 8.3. 2012 NC FUEL GAS CODE, SECTION 404.15.3 TRACER: AN INSULATED COPPER TRACER WIRE OR OTHER APPROVED CONDUCTOR SHALL BE INSTALLED ADJACENT TO UNDERGROUND NONMETALLIC PIPING. ACCESS SHALL BE PROVIDED TO THE TRACER WIRE OR THE TRACER WIRE SHALL TERMINATE ABOVE GROUND AT THE END OF THE NONMETALLIC PIPING. THE TRACER WIRE SIZE SHALL NOT BE LESS THAN 18-AWG AND THE INSULATION TYPE SUITABLE FOR DIRECT BURIAL.

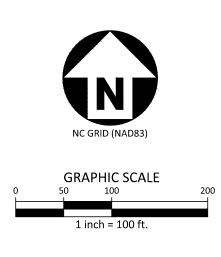





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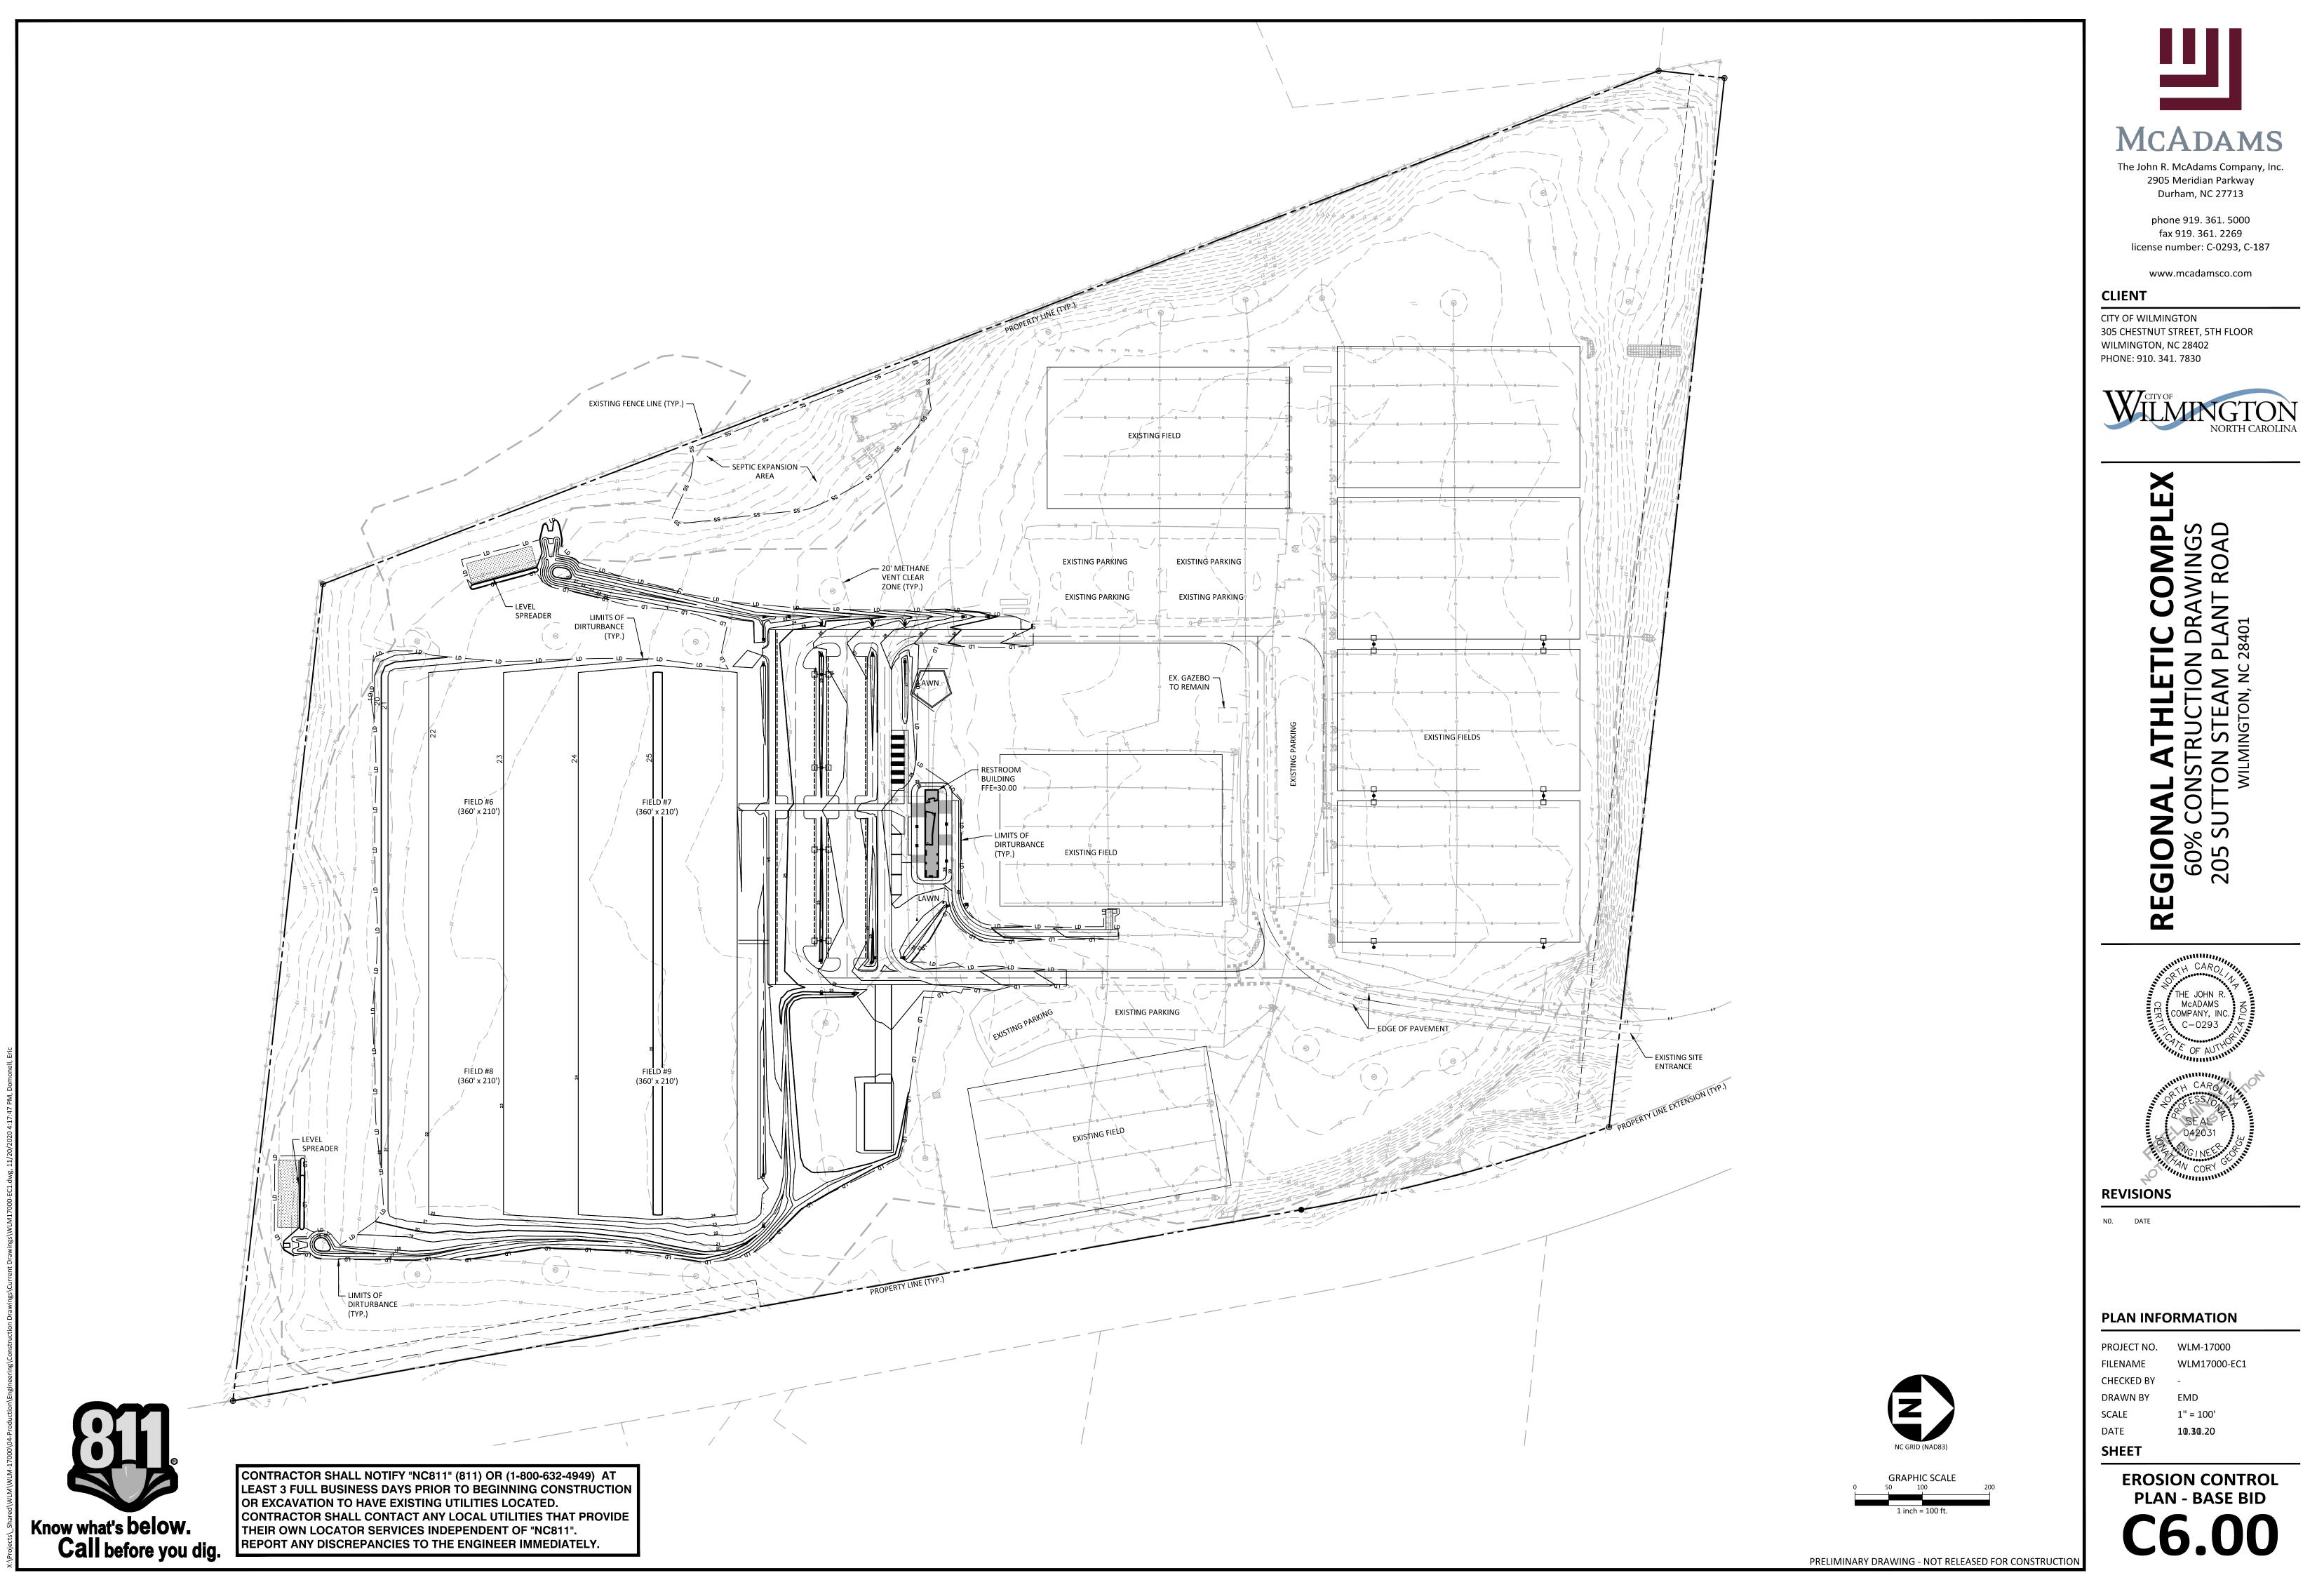





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FILENAME	WLM17000-OAU1
PROJECT NO.	WLM-17000





DRAWN BY CHECKED BY	JSR/CMR B.P., P.E. OT TO SCALE	PARKING FACILITY DESIGN NOTES	NORTH CAROLINA CITY OF WILMINGTON ENGINEERING PO BOX 1810 WILMINGTON, NC 28402 (910) 341–7807 SD 15-13	DRAWN E CHECKEE SCALE	) BY
DATE: 2001		STANDARD DETAIL	WILMINGTON	DATE:	2001
	portab	le barricades.			
		be prevented by standard signs	and as needed by		
9.	0	in fire lanes and in non-resid	, ,		
		a parked vehicle.			
	stall w	which would prevent safe ingress	s and egress		
8.	No obs	tructions will be allowed adjace	nt to a parking		
		r interpretation of the Manual o I Devices (MUTCD).	on Unitorm Trattic		
		I devices shall conform to the			
7.	All othe	er pavement markings, signs or	other traffic		
	white.	-			
6.	All parl	king stall markings and lane ar	rows shall be		
	five (2	provide for a minimum turning 25) feet, as measured from the portion.			
5.		bays which terminate at a cir	-		
4.	All med	dians shall be a minimum of si	ix (6) feet wide.		
3.		, crossties, utility poles, etc., c eel stops. (Must be anchored			
~	deep s				
2.	-	stops shall be required three (3	3) feet from the		
	will be Engine	allowed only upon approval of er	the Traffic		
1.		es on stall widths, angle and o			



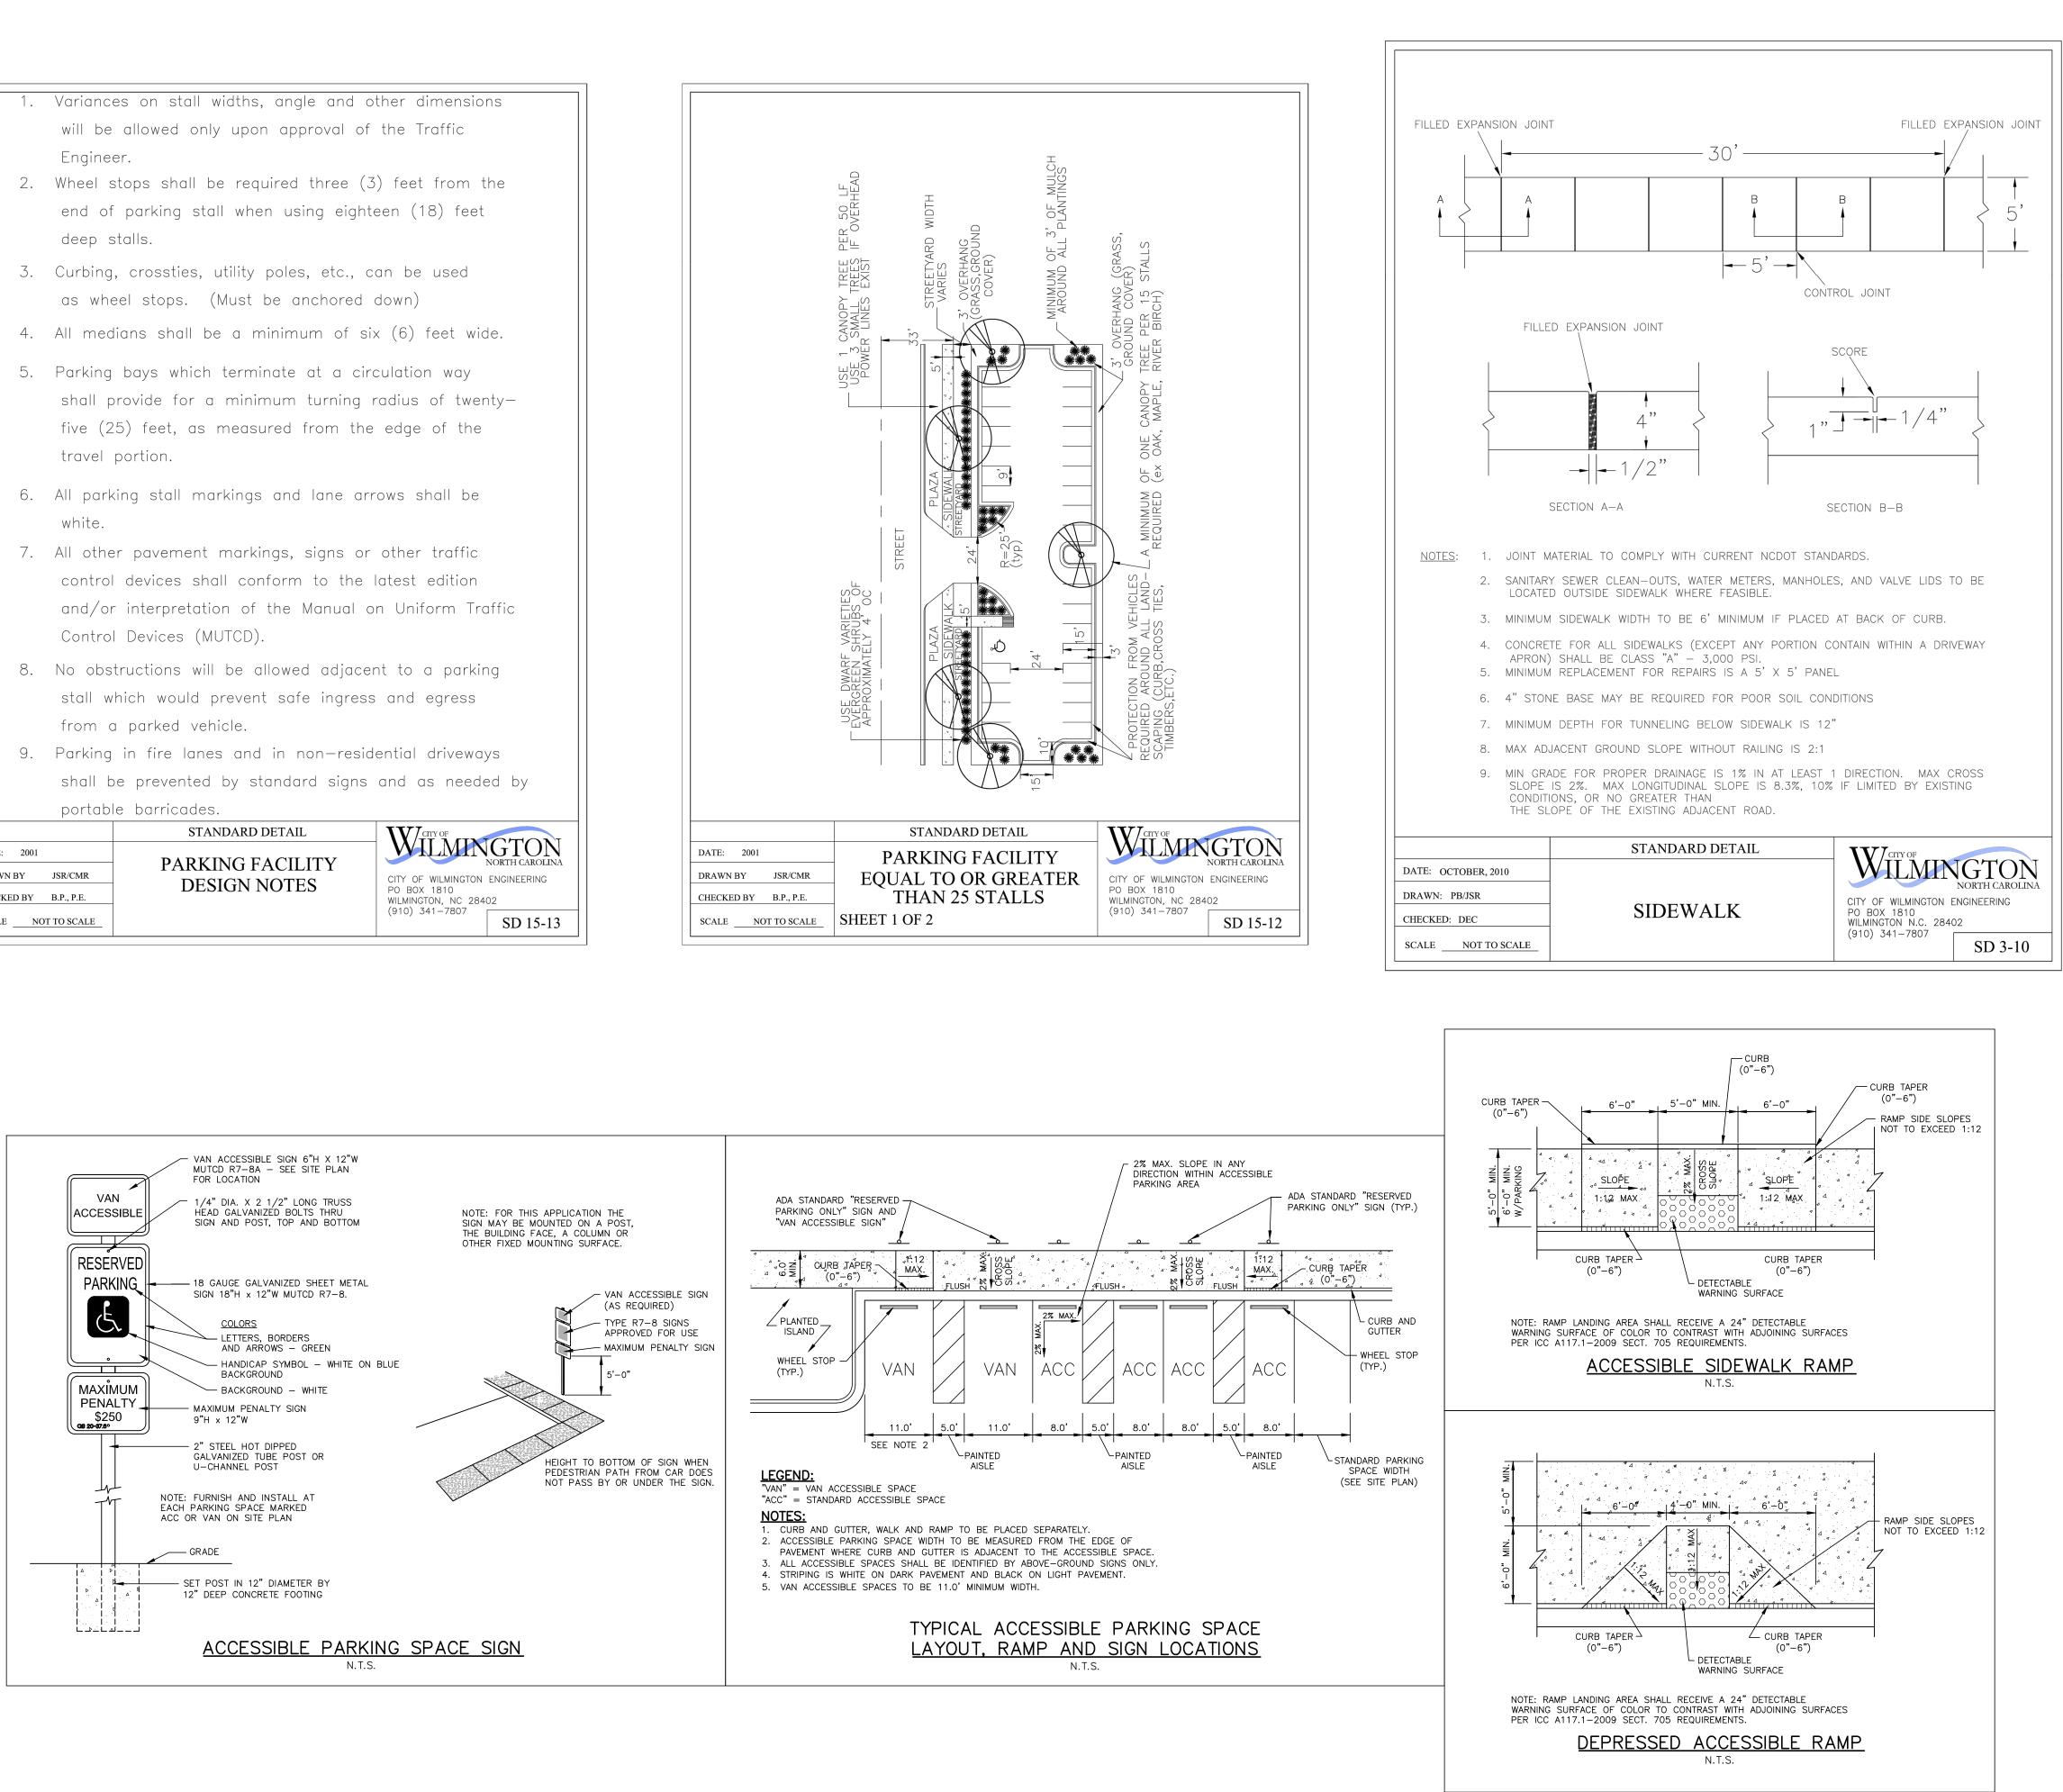

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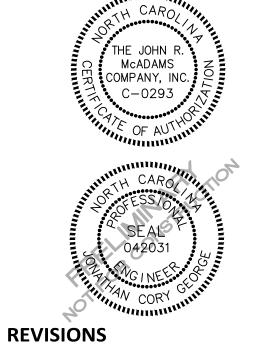
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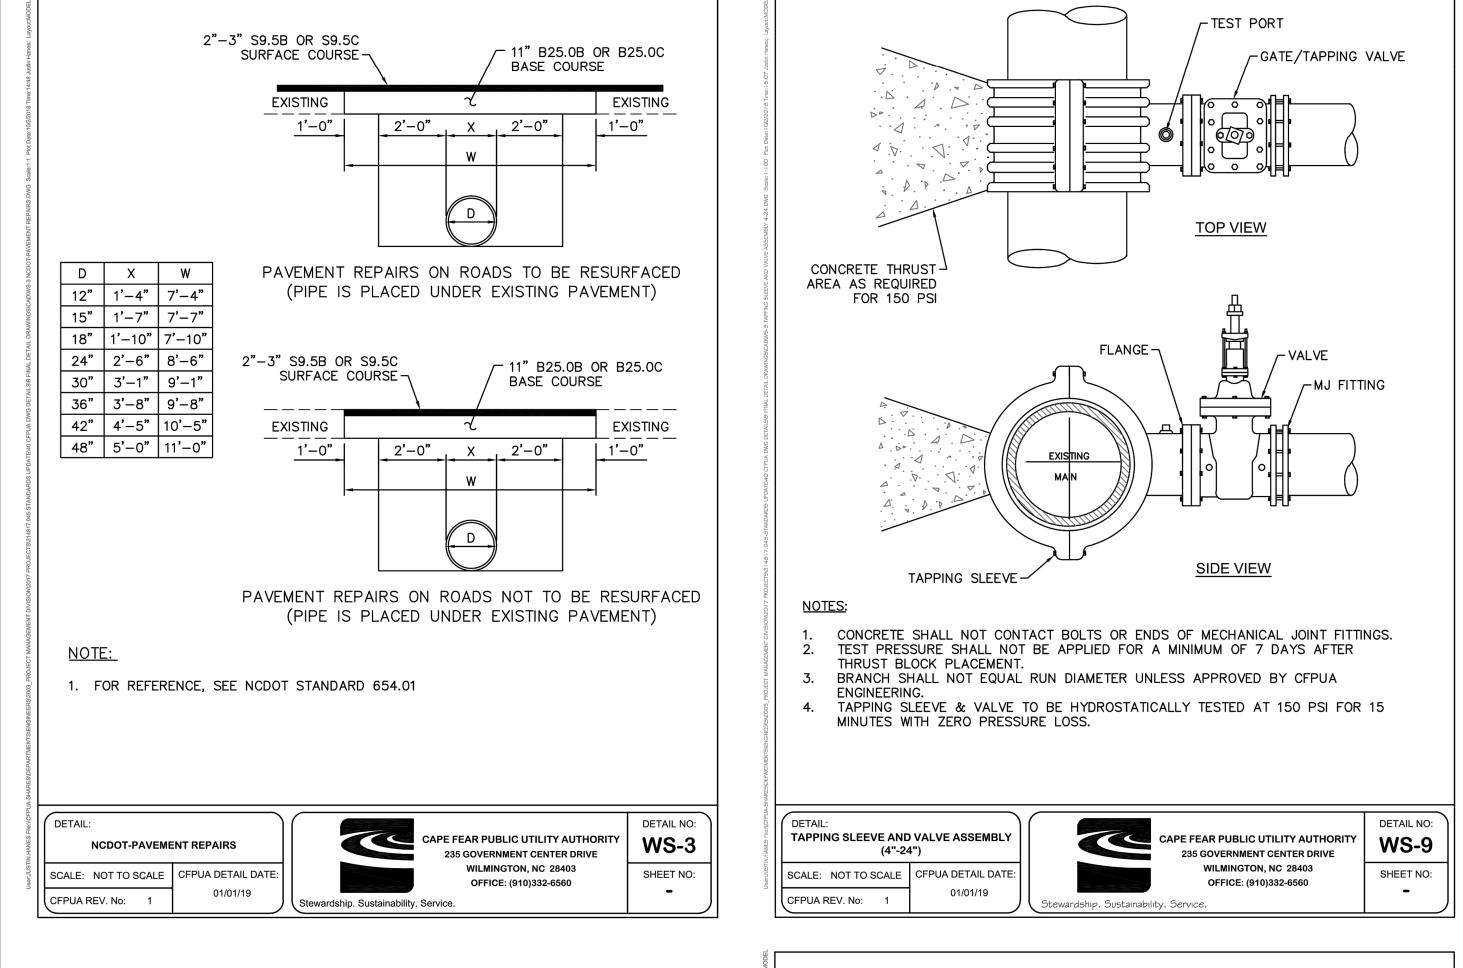
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## **PLAN INFORMATION**


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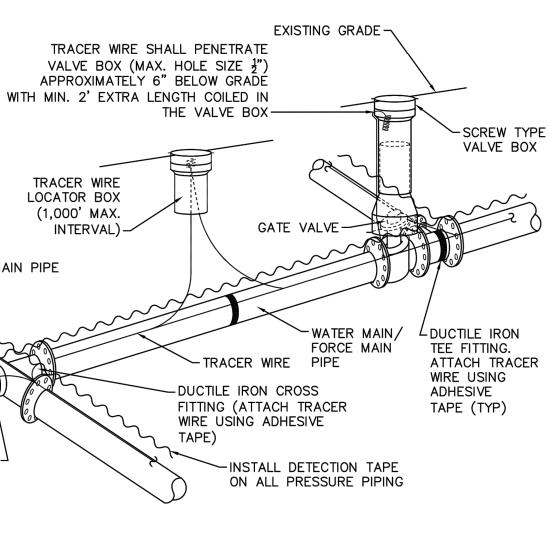
SITE DETAILS









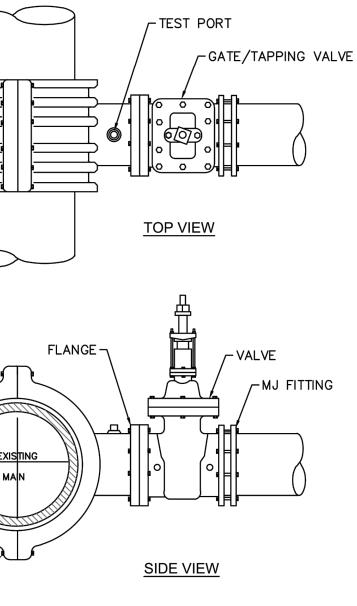

TRACER WIRE

LOCATOR BOX

(1,000' MAX.

-MAIN PIPE

ATTACH TRACER-

FITTING USING

ADHESIVE TAPE

INTERVALS.

TRACER WIRE DETAIL

SCALE: NOT TO SCALE CFPUA DETAIL DATE:

01/01/19

DETAIL:

CFPUA REV. No:


WIRE TO


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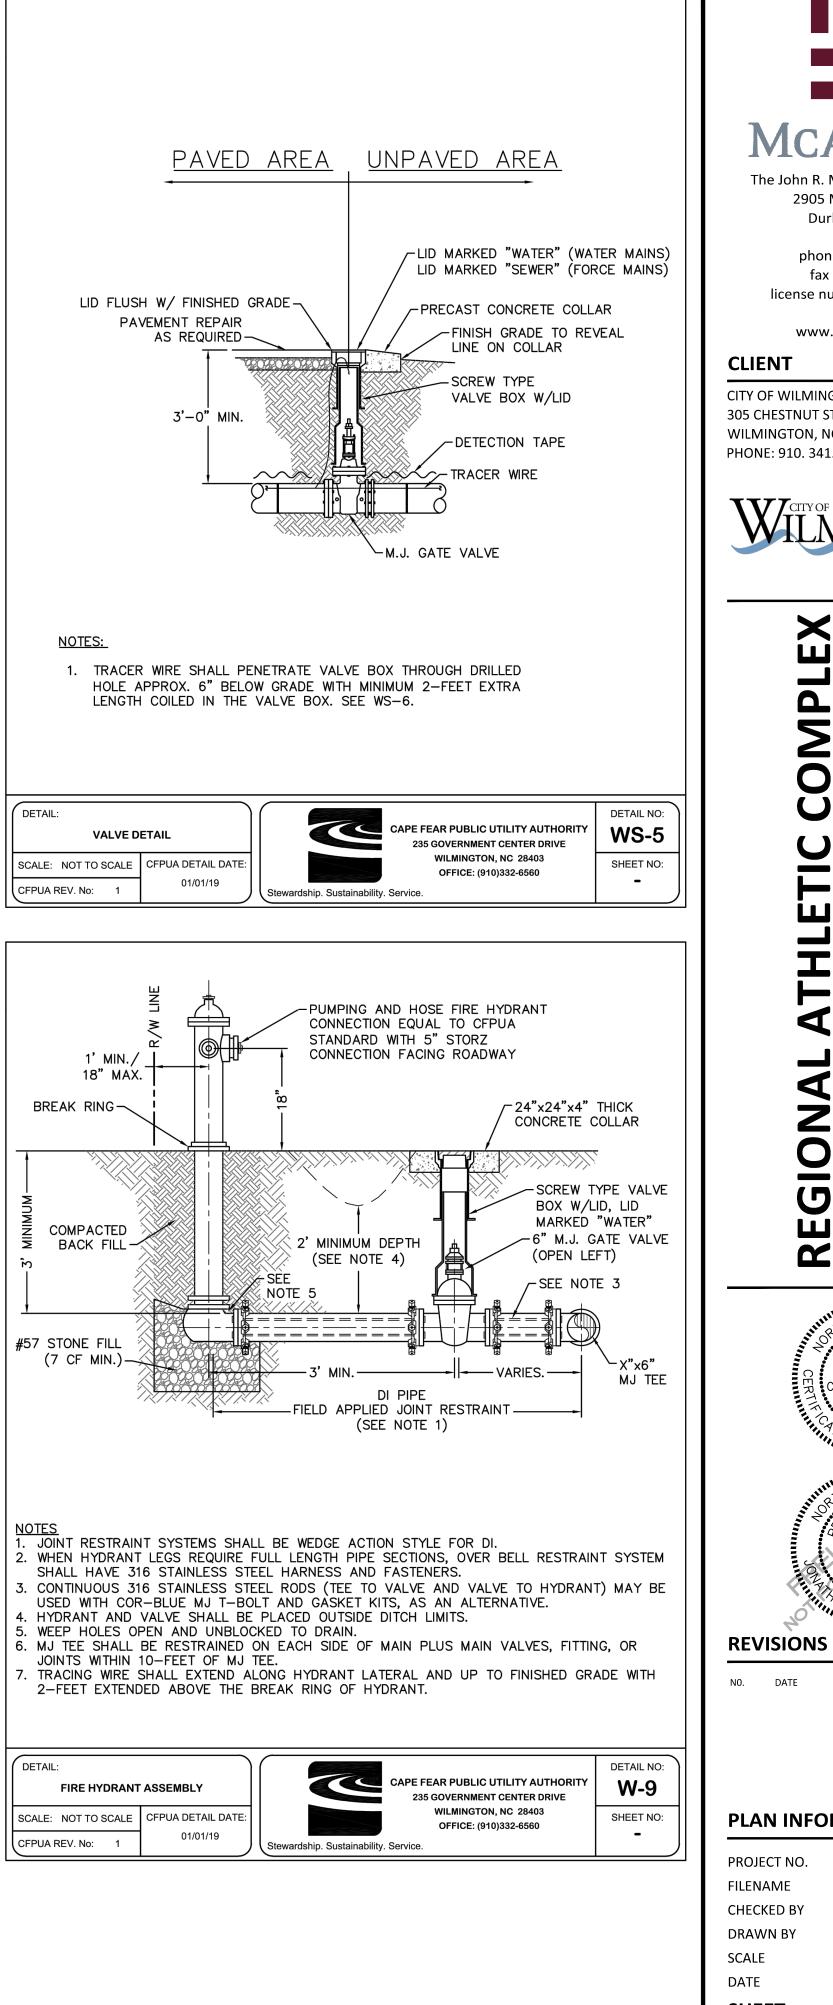
INTERVAL)-

NOTES: 1. TRACER WIRE SHALL BE #10 COPPER SOLID CORE COPPER WIRE WITH GAS AND OIL RESISTANT INSULATION AND DIRECT BURY RATING. WIRE SHALL BE STRAPPED TO ALL PVC PIPING WITH ADHESIVE TAPE AT 12 FOOT 3. SECURE WIRE TO ALL TEE AND CROSS FITTINGS WITH ADHESIVE TAPE. 4. ALL SPLICES IN THE WIRE SHALL BE MADE WITH 3M DBR DIRECT BURY SPLICE KITS.





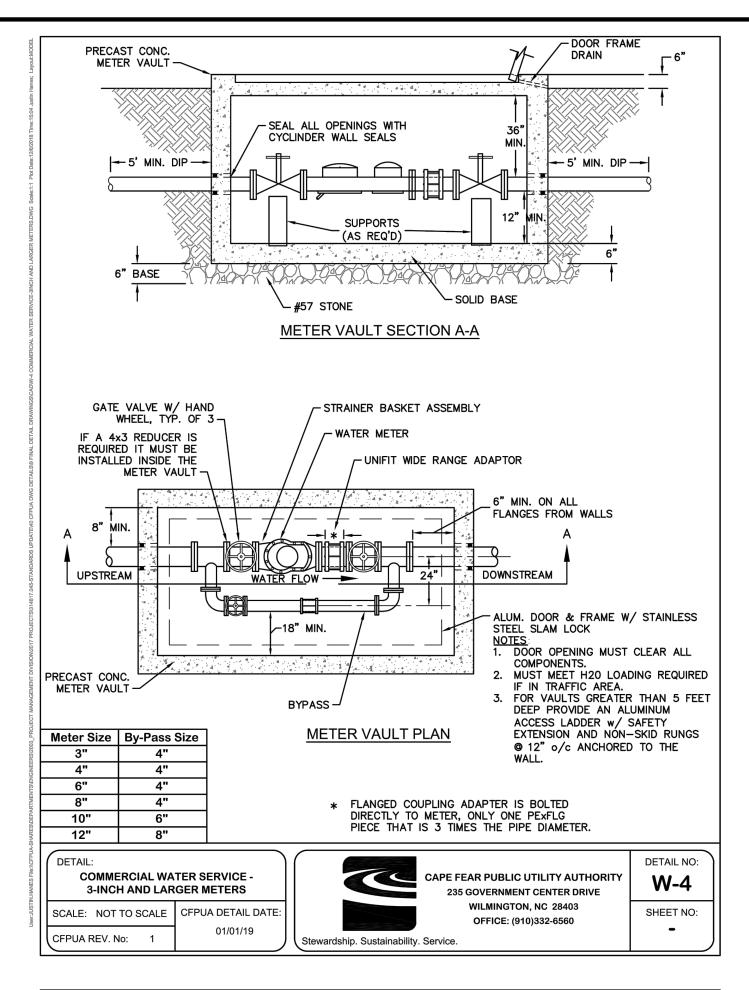

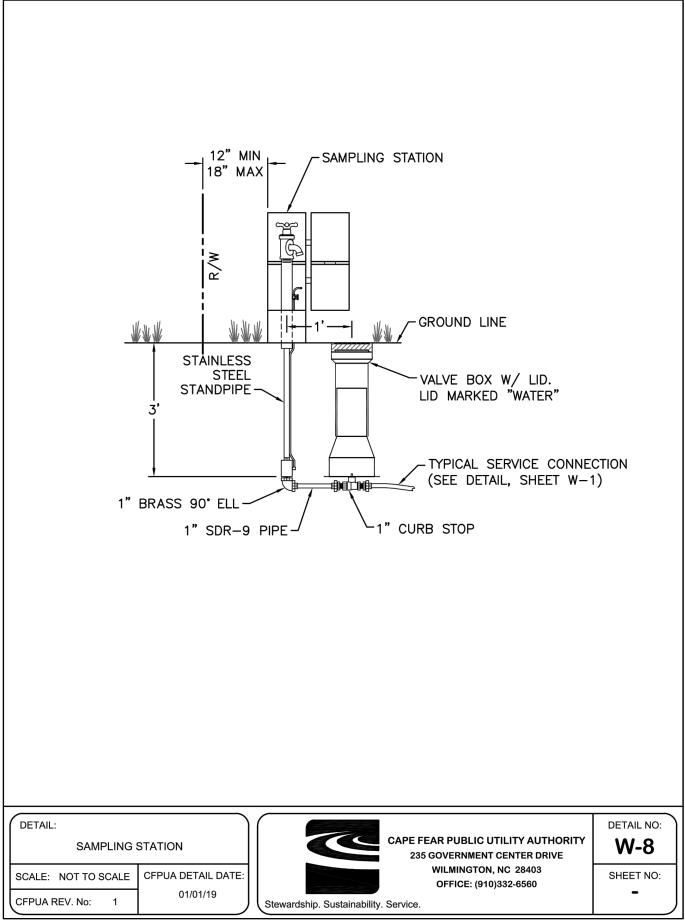

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# PLAN INFORMATION

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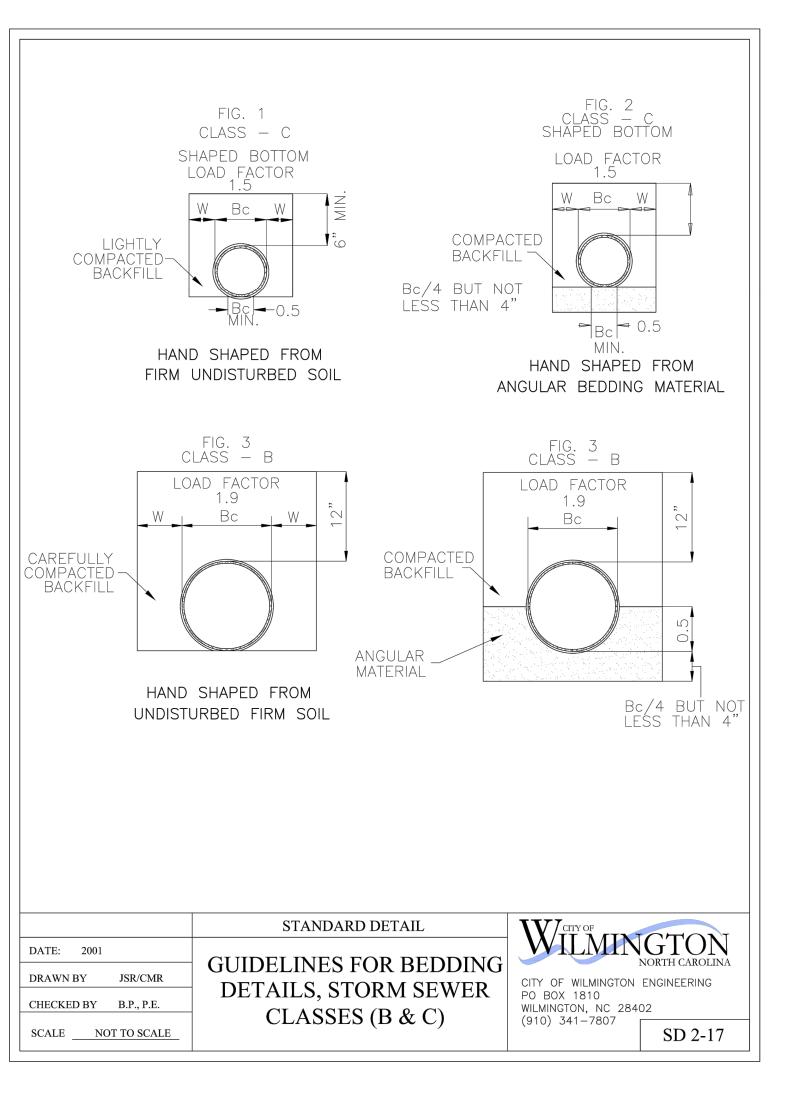
## WATER DETAILS



ojects\\_Shared\WLM\WLM-17000\04-Production\Engineering\Construction Drawings\Current Drawings\WLM17000-D1.dwg, 11/20/2020 4:18:05 PM, Domonell, I

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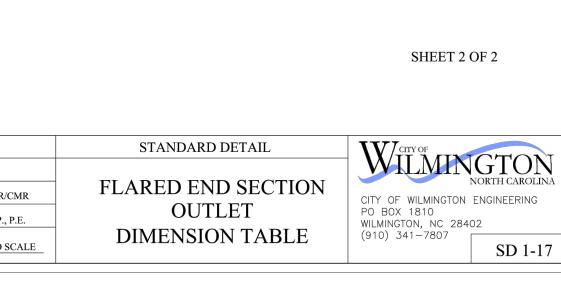






1. STRUCTURAL DESIGN OF END SECTION SHALL CONFORM WITH THAT OF STANDARD REINFORCED CONCRETE.

PE 1eter	WALL THICKNESS	SLOPE	В	С	D	E	UNIT WEIGHT
2	2 1/4	3:1	24	49	73	24	730
5	2 1/4	3:1	27	46	73	30	910
8	2 1/2	3:1	27	46	73	36	1190
21	2 3/4	3:1	36	37	73	42	1370
24	3	3:1	42	31 1/2	73 1/2	48	1770
27	3 1/4	3:1	48	25 1/2	73 1/2	54	2130
30	3 1/2	3:1	54	19 3/4	73 3/4	60	2380
33	3 3/4	3:1	60	36	96	66	3870
36	4	3:1	63	34 3/4	97 3/4	72	5320
12	4 1/2	3:1	63	35	98	78	5920
18	5	3:1	72	26	98	84	7470
54	5 1/2	2.4:1	66	34	100	90	8810
60	6	2:1	60	39	99	96	11180
72	7	2:1	78	21	99	108	13980

NSIONS IN INCHES WEIGHTS IN POUNDS



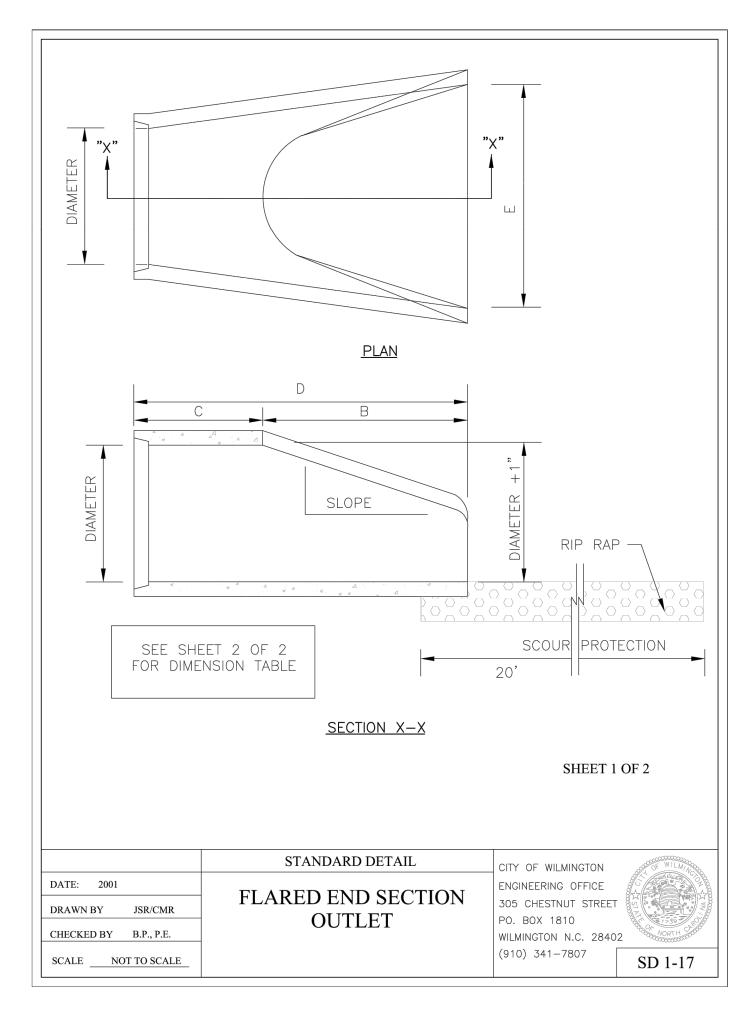

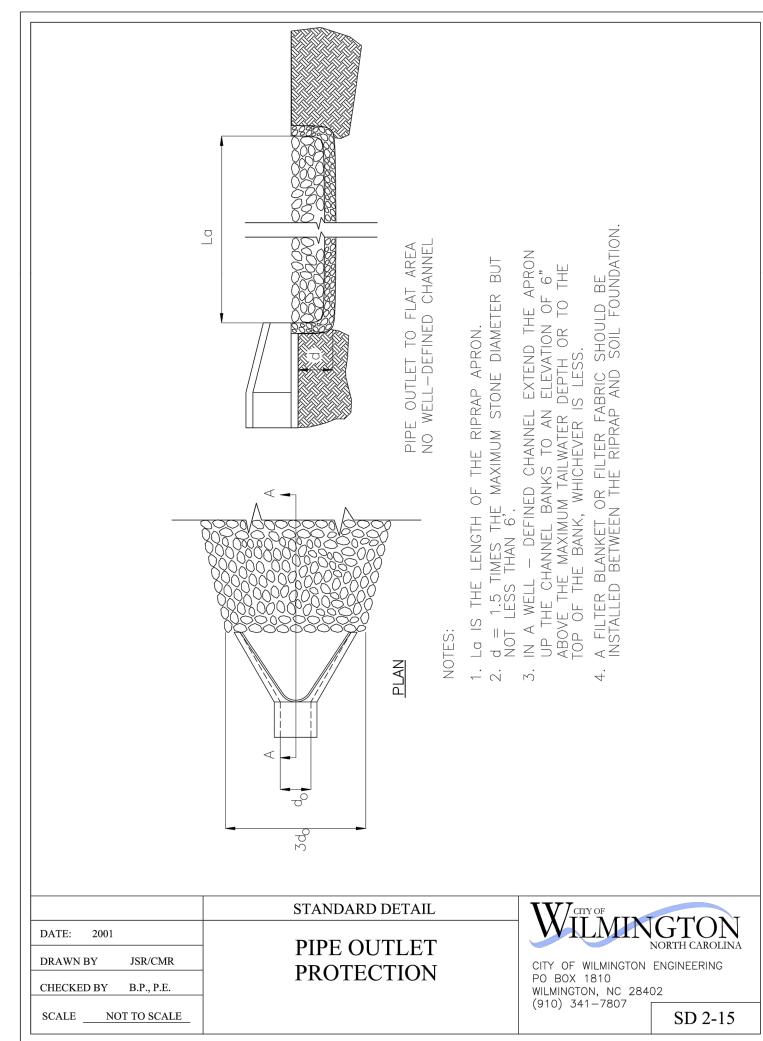



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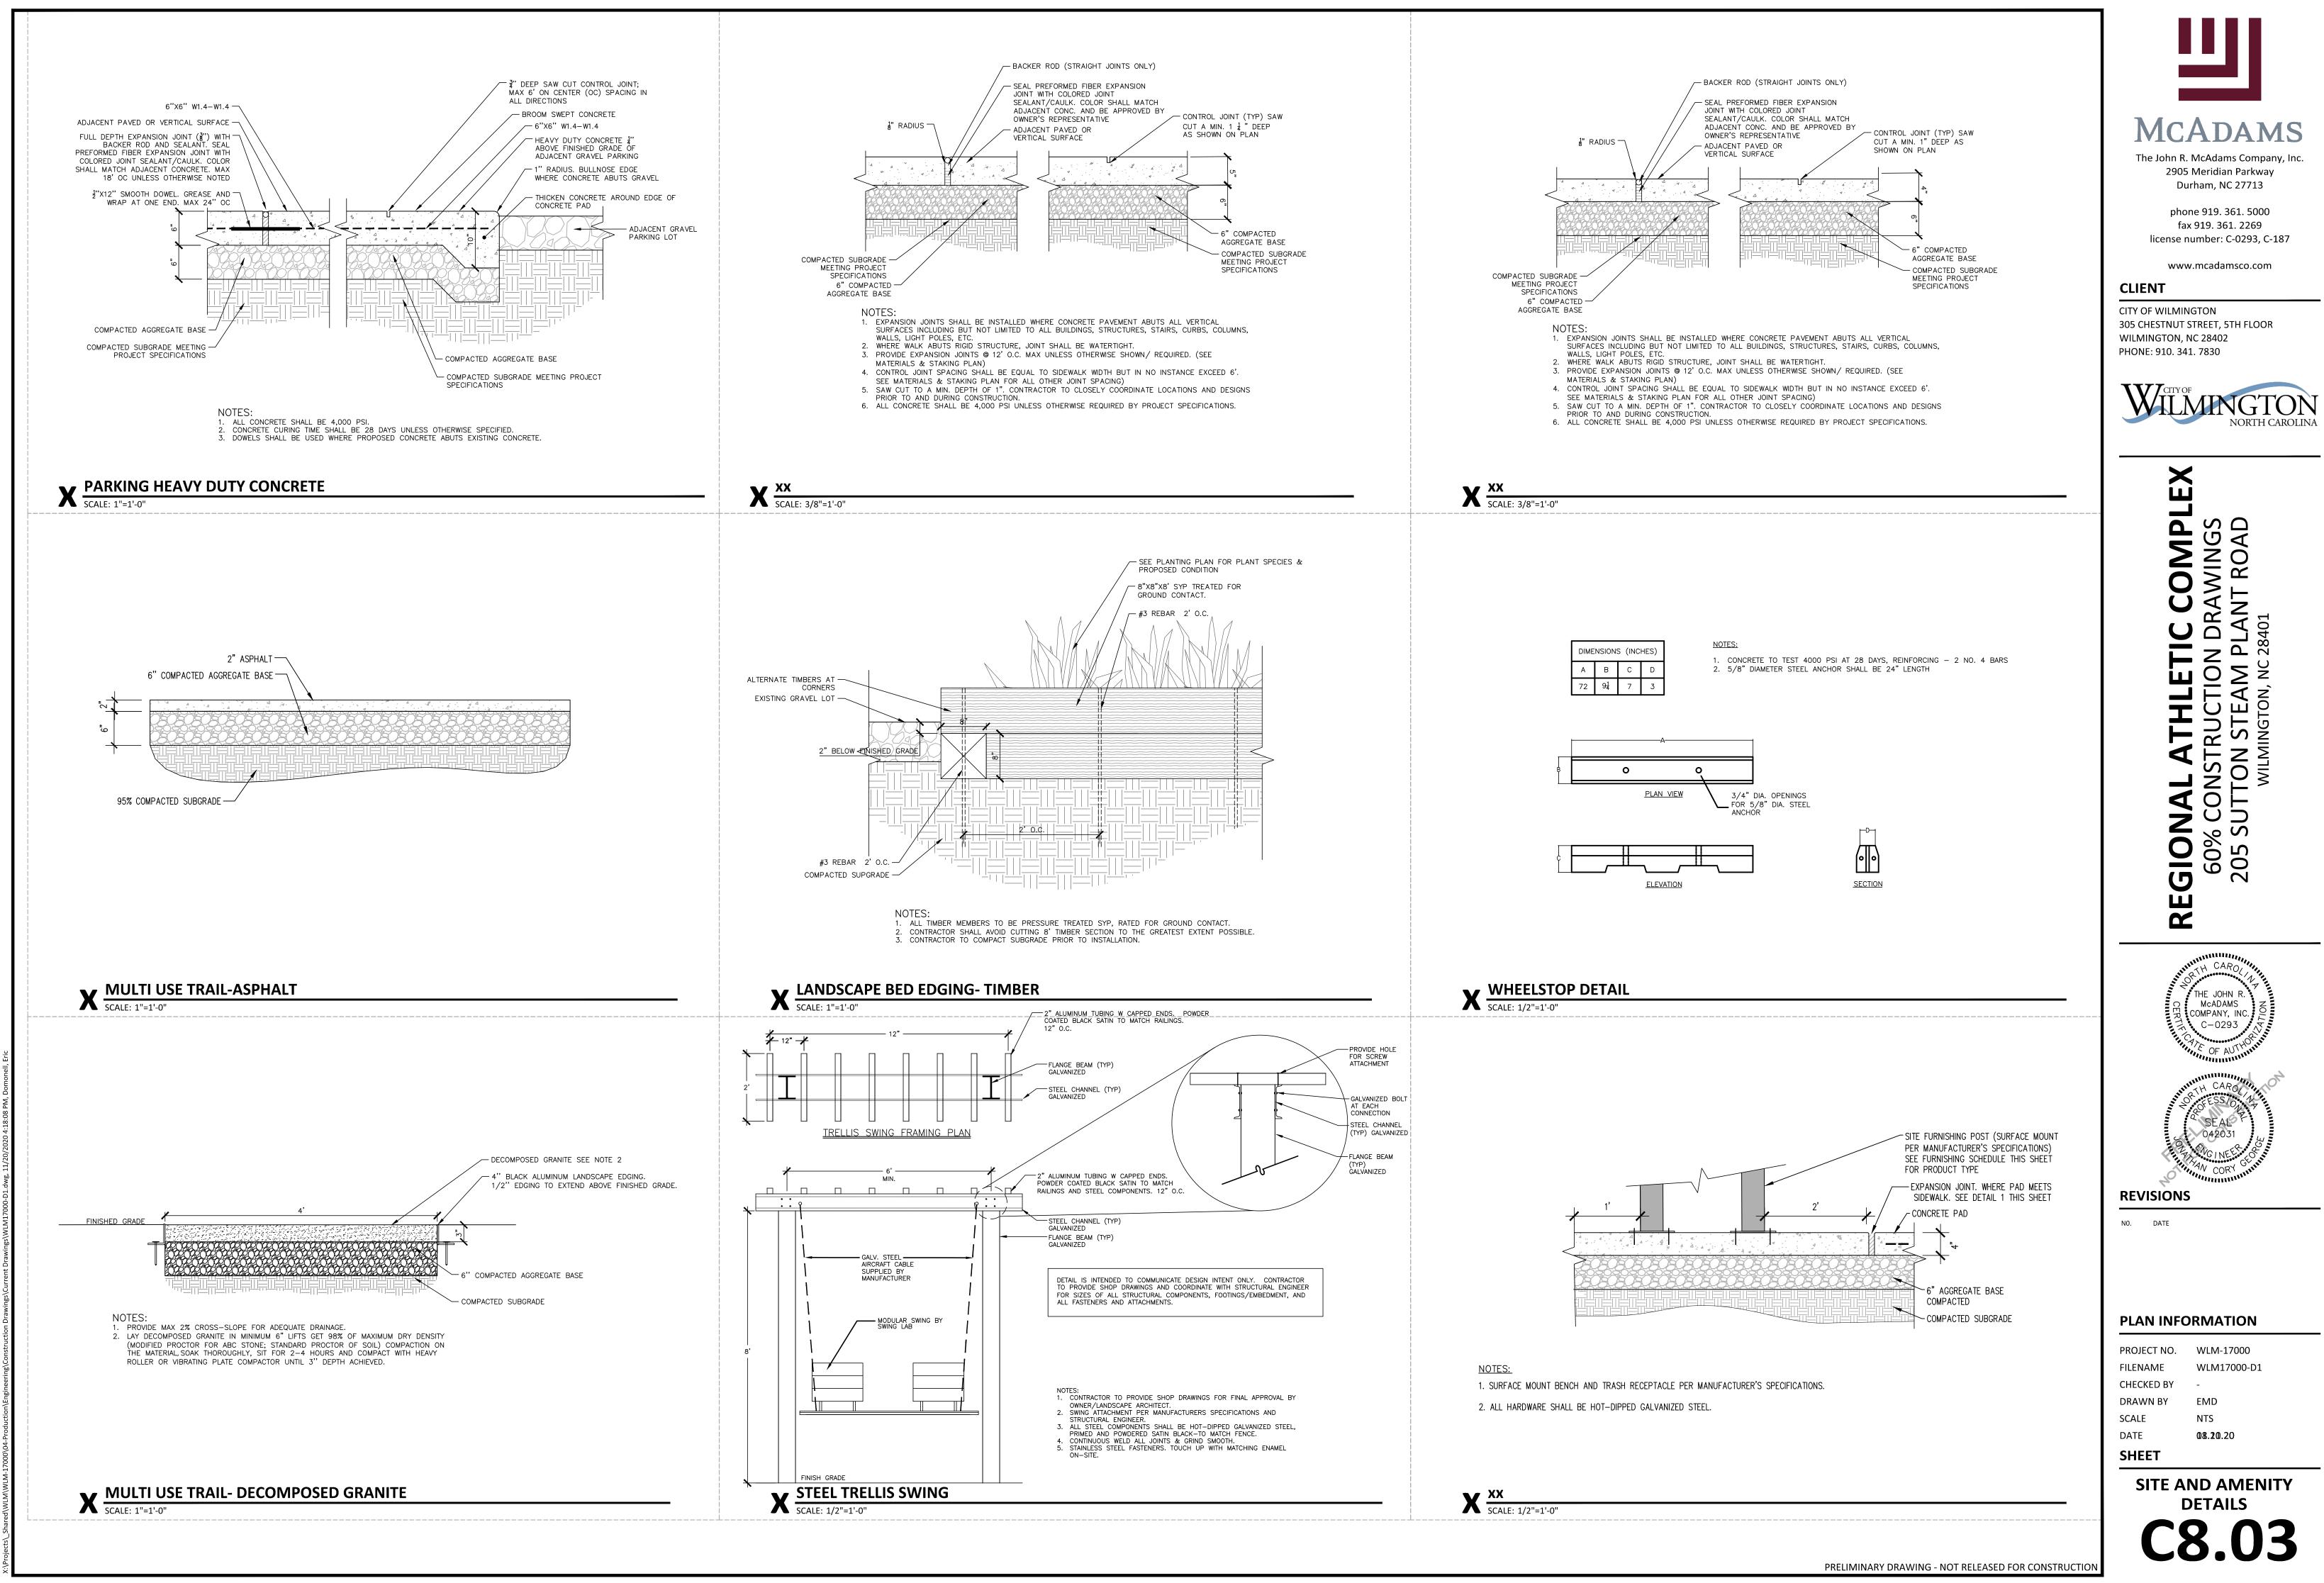





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<form><form></form></form>	<ol> <li>ALL CONSTRUCTION ACTIVITY RELATED TO THE PROPOSED FAC DRAWINGS. SOILS, COMPACTION, AND OTHER MISCELLANEOU RECOMMENDATIONS OF THE ON-SITE GEOTECHNICAL ENGINE</li> </ol>	CILITIES SHALL BE PER THE DETAILS AND SI JS DETAILS AND SPECIFICATIONS MAY BE I SER. HOWEVER, <u>PRIOR TO IMPLEMENTATION</u>	PECIFICATIONS SHOWN IN THESE MODIFIED PER THE ON, THE DESIGN ENGINEER SHALL BE	\$ \$ \$ \$ \$ \$ \$ \$ \$ \$ \$ \$ \$ \$
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<text><section-header><section-header><section-header></section-header></section-header></section-header></text>	SHALL FURNISH, INSTALL, OPERATE, AND MAINTAIN ANY PUMI PARTS OF THE LEVEL SPREADER SITES. DURING PLACEMENT OF BELOW THE BOTTOM OF THE EXCAVATION / CONSTRUCTION A THE EXCAVATION BOTTOM AND SIDE SLOPES ARE STABLE, WIT	IPING EQUIPMENT, ETC. NEEDED FOR REM F FILL WITHIN THESE AREAS, THE CONTRA AREAS. THE MANNER IN WHICH THE WATE TH NO SEDIMENT DISCHARGED FROM THE	IOVAL OF WATER FROM VARIOUS CTOR SHALL KEEP THE WATER LEVEL ER IS REMOVED SHALL BE SUCH THAT E SITE (I.E. PUMPED WATER MAY NEED	
<form><form><form><form></form></form></form></form>	PRIOR TO DISCHARGE).	,		* * 17-17-18-
<form></form>	MAINTENANCE AGREEMENT.	UDE AN OPERATIONS AND MAINTENAN	ICE MANUAL (O&M MANUAL) WITH A	BYPASS CHANN WITH CLASS 'I (SEE
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<form></form>	2. INSTALL ALL SEDIMENT AND EROSION CONTROL MEASURES PE CONTRACTOR SHALL MAINTAIN ALL APPROVED SEDIMENT AN REQUIRED. THE CONTRACTOR SHALL RECEIVE APPROVAL FROM	ID EROSION CONTROL MEASURES THROU	GHOUT THE ENTIRE PROJECT, AS	
<form></form>	FROM THE SCM FOOTPRINT AREA AND BACK FILLED WITH SUI STANDARDS SET FORTH IN NOTE #4. PRIOR TO CONSTRUCTING AREAS FOR THE ABOVE SHALL BE STRIPPED TO A SUITABLE DEI	TABLE SOIL MATERIAL. THE BACK FILLED A G THE LEVEL SPREADER STRUCTURE AND I PTH AS DIRECTED BY THE ON-SITE GEOTE	AREAS SHALL BE COMPACTED TO THE BYPASS BERM AT EACH SCM, THE CHNICAL ENGINEER. ANY RESIDUAL	*
<form><list-item><list-item><list-item><list-item><list-item><list-item><list-item><list-item><text></text></list-item></list-item></list-item></list-item></list-item></list-item></list-item></list-item></form>	MAXIMUM DRY DENSITY (ASTM-698). THE FILL SOILS SHALL BE OPTIMUM MOISTURE CONTENT. COMPACTION TESTS SHALL B CONSTRUCTION TO VERIFY THAT THE PROPER COMPACTION L SHEEPSFOOT TYPE COMPACTOR. IN ORDER TO PREVENT DAM,	E COMPACTED AT A MOISTURE CONTENT BE PERFORMED BY THE ON-SITE GEOTECH LEVEL HAS BEEN REACHED. THE FILL SHOU	WITHIN -1 TO +3 PERCENT OF ITS NICAL ENGINEER DURING LD BE COMPACTED USING A	
<form></form>	5. THE ON-SITE GEOTECHNICAL ENGINEER SHALL INSPECT THE LE THE SCM PRIOR TO PLACEMENT / COMPACTION OF ANY BACK UP THESE AREAS PRIOR TO INSPECTION, THEN THE SUBGRADE CONSTRUCTION OF THE LEVEL SPREADER STRUCTURE AND DIV	K FILL WITHIN THESE AREAS. IF THE CONTR E SHALL BE UNCOVERED AND TESTED AT T VERSION BERM AT THE SCM SHALL NOT O	ACTOR CONSTRUCTS AND COVERS HE CONTRACTOR'S EXPENSE. THE	PROPERTY LINE
TOTAL CONCENTRATION CONCENTRATION CONTINUES IN A LESS ON A DOTAL THAT INFORMATION CONTINUES AND A DOTAL DOTAL THAT INFORMATION CONTINUES AND A DOTAL THAT INFORMATION	STRUCTURE, INSTALL THE SPLITTER BOX, AND THEN INSTALL T THE OUTLET FROM THE SPLITTER BOX TO THE LEVEL SPREADE ONCE A PRELIMINARY AS-BUILT OF THE CONSTRUCTED FACILIT THAT THE SCM HAS BEEN CONSTRUCTED IN GENERAL COMPLI ENGINEER WILL NOTIFY THE THE CONTRACTOR THAT THE PLUG	THE BYPASS CHANNEL/BERM. FOR THE FAC R STRUCTURE BE PLUGGED UNTIL THE LEV TY IS PROVIDED TO THE DESIGN ENGINEEI IANCE WITH THE PLANS AND SPECIFICATIO IG CAN BE REMOVED. BASED ON THE RESU	CILITY, IT IS RECOMMENDED THAT VEL SPREADER HAS BEEN INSTALLED. R AND IT HAS BEEN DETERMINED DNS FOR THE FACILITIES, THE DESIGN JLTS OF THE AS-BUILT SURVEYS, THE	30–FOOT STRIP MAXI 3 FT WID
<text><list-item><list-item><list-item><list-item><list-item><list-item><list-item><list-item><list-item><list-item></list-item></list-item></list-item></list-item></list-item></list-item></list-item></list-item></list-item></list-item></text>	ELEVATIONS FOR THE CONCRETE LEVEL SPREADER MAY BE MC	טטורובט דאטא THOSE PROVIDED IN THESE	E UKAWINGS.	(4–INCHE WITH FILT
<pre>town intermediate concrete fourier for the shall be taken to hist, relationed to the relationed concrete wail. i. The relationed concrete fourier for the shall be taken to an advance of a should be of a should be of a should be taken to an advance of a should be of a should be taken to an advance of a should be taken to a sh</pre>	SHALL BE PLACED WITH A 3-5" SLUMP, UNLESS OTHERWISE INI ENGINEER. CONCRETE TESTING SHALL BE PROVIDED WITH THE	DICATED OR DIRECTED BY THE DESIGN EN	GINEER OR THE ONSITE GEOTECHNICAL	
<list-item><list-item><list-item><list-item><list-item><section-header><section-header><section-header></section-header></section-header></section-header></list-item></list-item></list-item></list-item></list-item>	COVER.			
<form></form>	4. NOTE THAT NO CONCRETE SHALL BE PLACED WHEN THE AMBI	ENT AIR TEMPERATURES ARE EXPECTED T		
<section-header></section-header>	5. A FILTER BLANKET IS TO BE INSTALLED BETWEEN THE RIPRAP A	AND SOIL FOUNDATION. THE FILTER BLAN		GRAPHIC
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phone 919. 361. 5000 fax 919. 361. 2269 license number: C-0293, C-187

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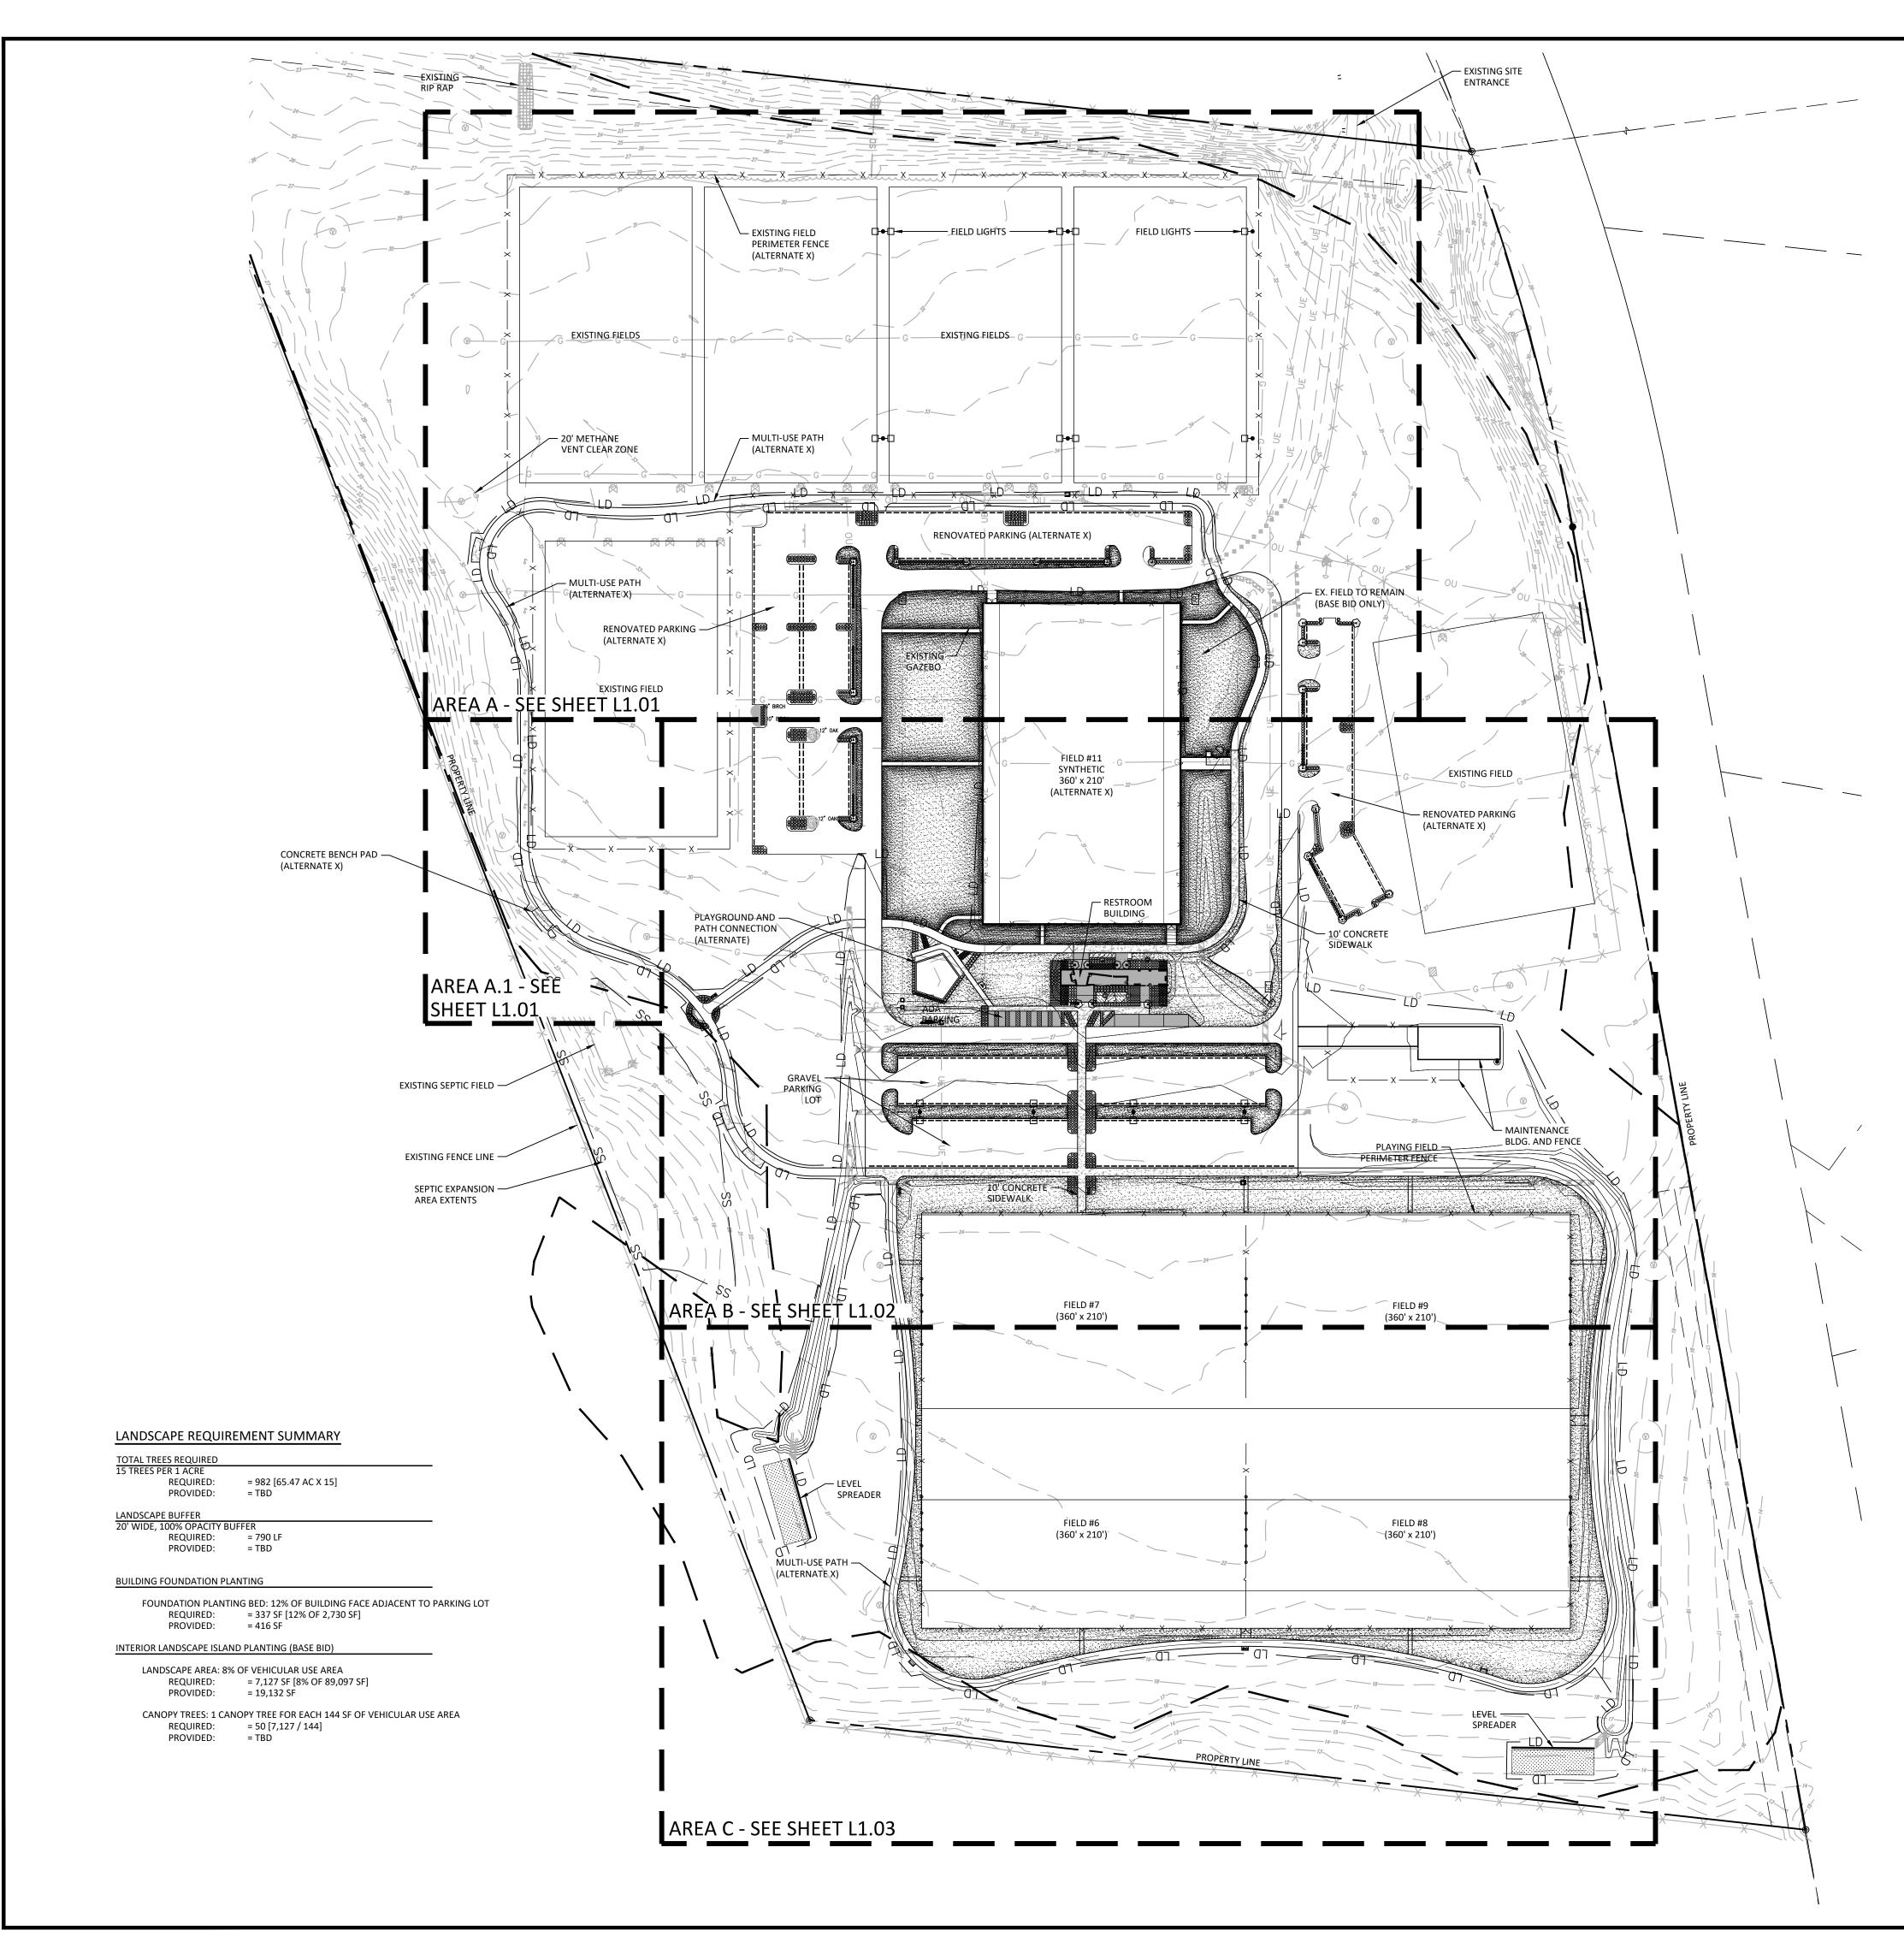


REVISIONS

NO. DATE

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DATE	11.11.20
SCALE	N.T.S.
DRAWN BY	HBD
CHECKED BY	JES
FILENAME	WLM17000-SW
PROJECT NO.	WLM-17000

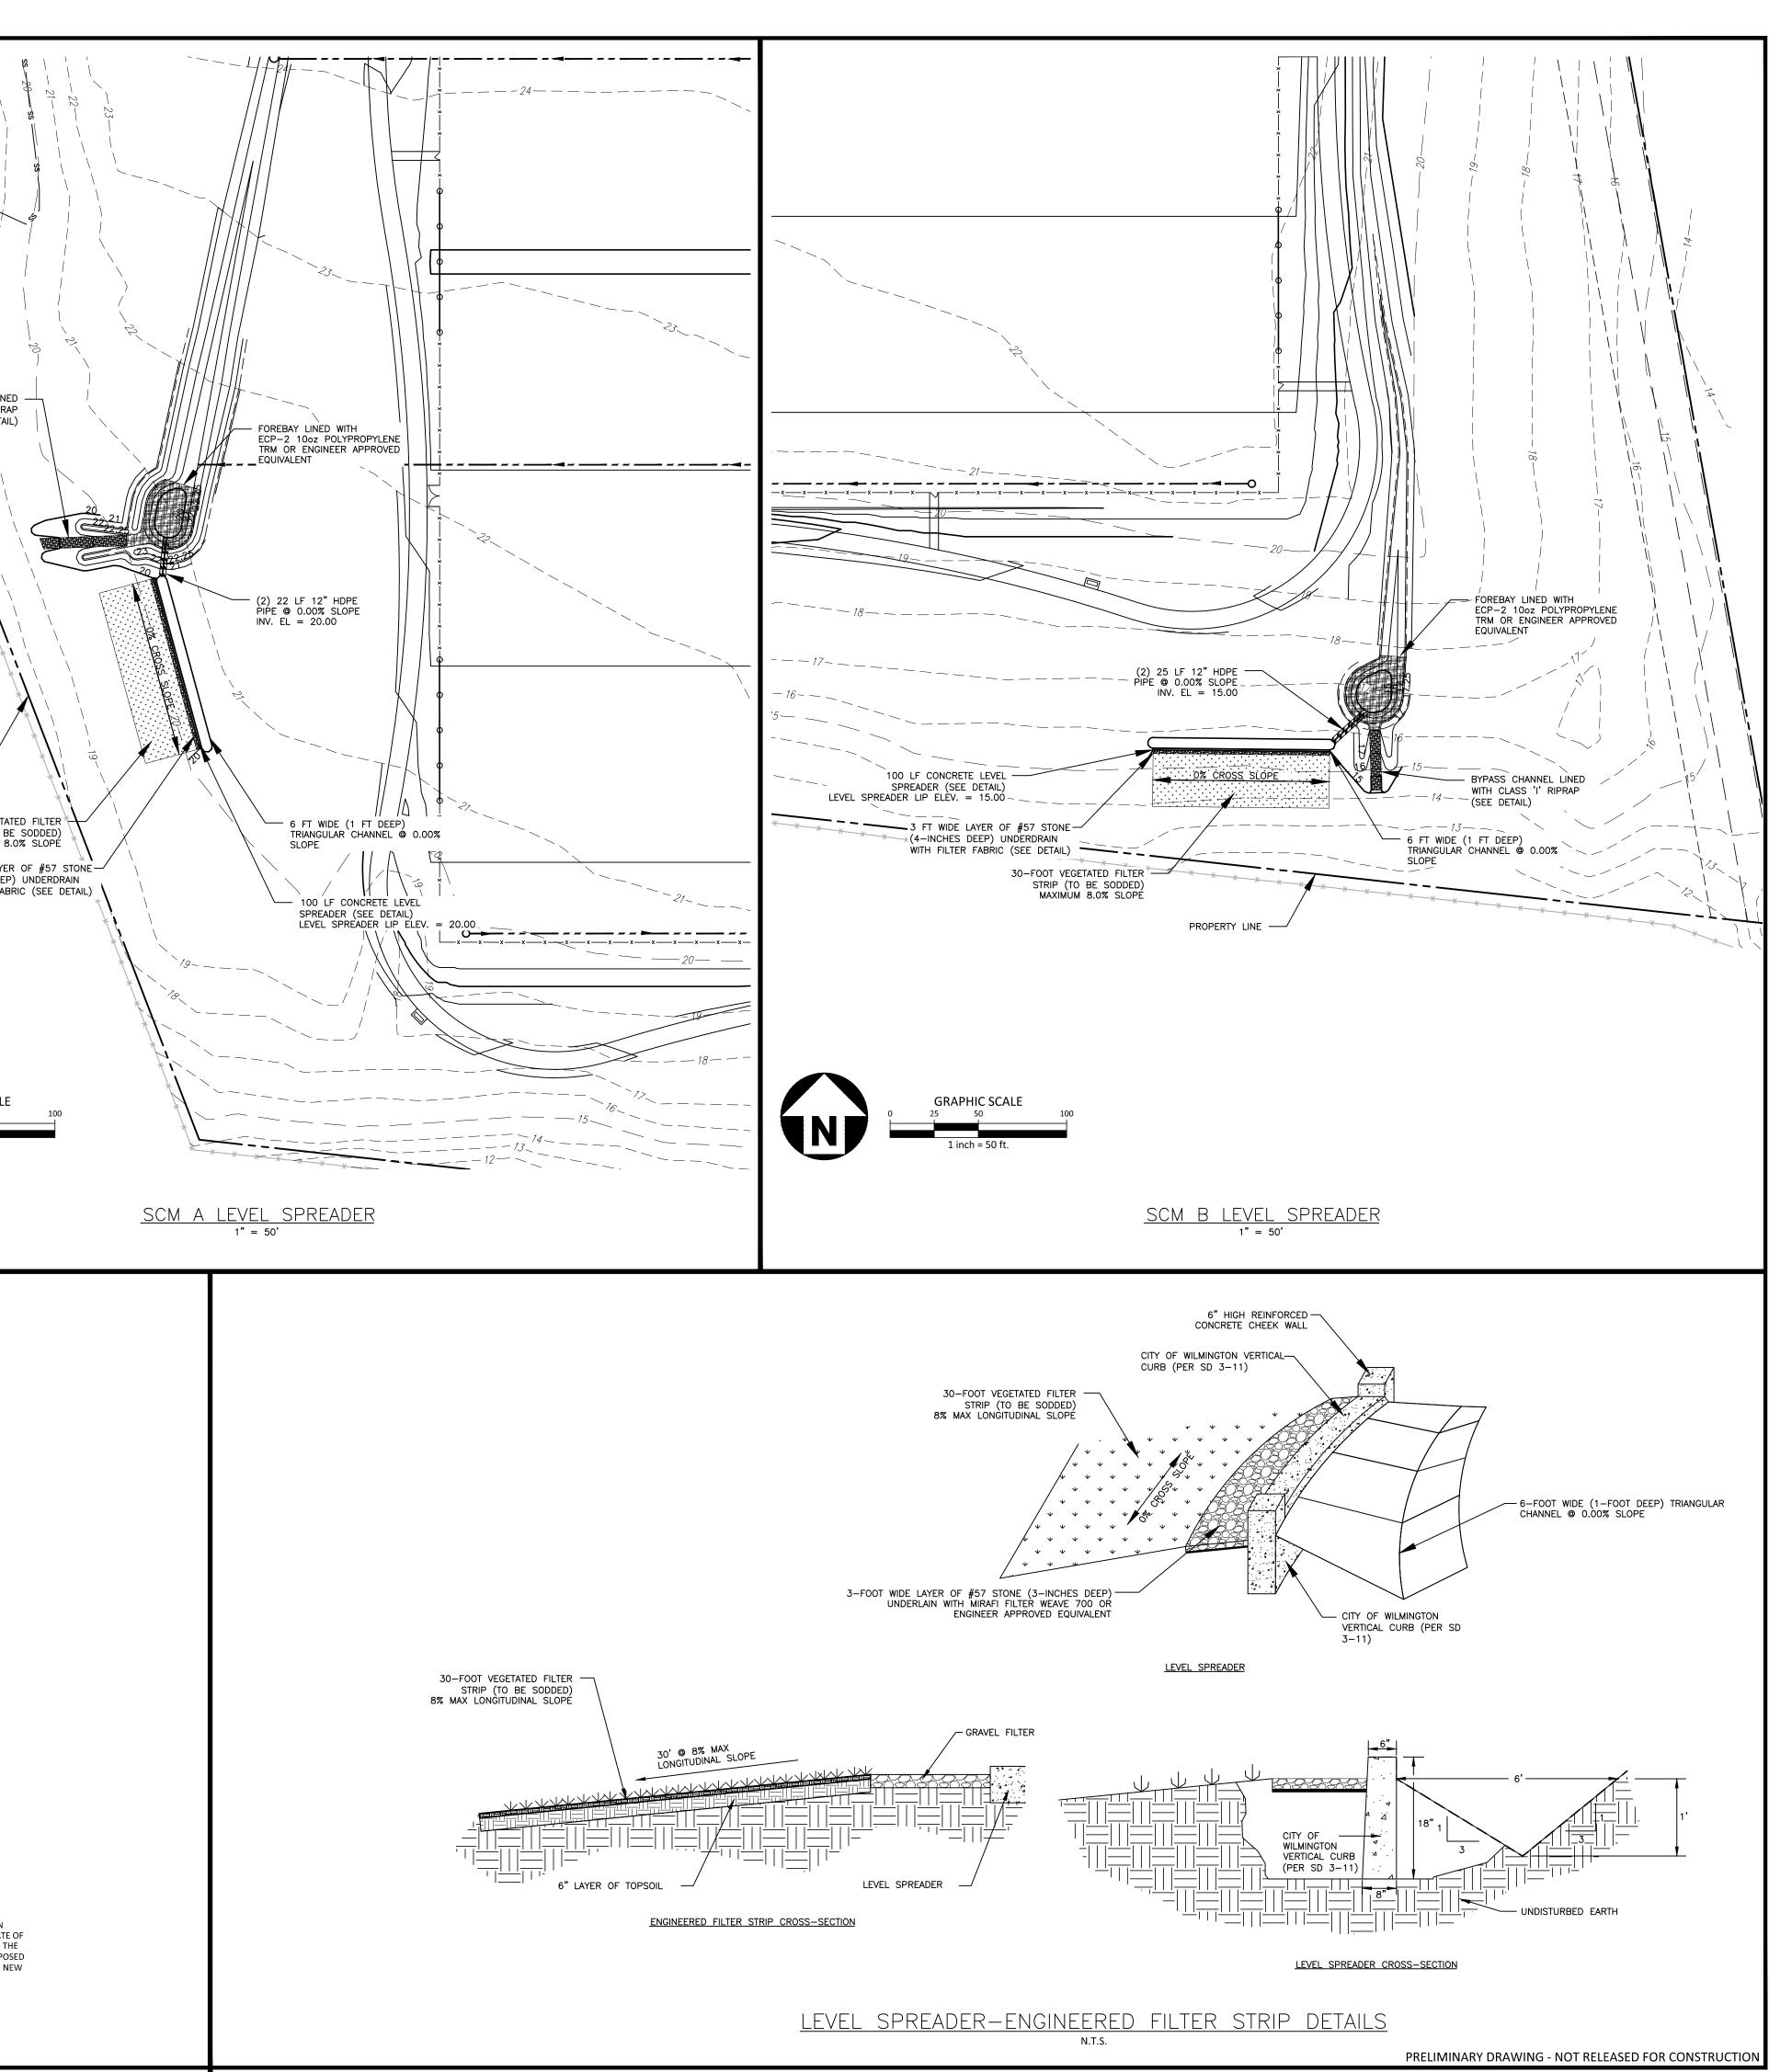



SITE LEGEND	
-0-	SIGNAGE
7	YARD LIGHTS
*	LIGHT POLE
<b>D</b>	POWER POLE
$\rightarrow$	TRAFFIC DIRECT
ACC	ACCESSIBLE PA
VAN	VAN ACCESSIBL
	PROPERTY LINE
	EASEMENT LINE
LD	LIMITS OF DIST
	CENTERLINE
— X — X — X —	EXISTING CHAIN
— X — X —	PROPOSED FEN
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	PROPOSED GRA
	PROPOSED CON
	PROPOSED HEA PAVEMENT
	PROPOSED GRA (ALTERNATE X)
$( \bigcirc )$	METHANE VENT

	SIGNAGE
	YARD LIGHTS
	LIGHT POLE
	POWER POLE
	TRAFFIC DIRECTIONAL ARROW
	ACCESSIBLE PARKING STALL
	VAN ACCESSIBLE PARKING STALL
_	PROPERTY LINE
_	EASEMENT LINE
_	LIMITS OF DISTRUBANCE
	CENTERLINE
	EXISTING CHAINLINK FENCE
_	PROPOSED FENCE
•	ACCESSIBLE ROUTE
	PROPOSED GRAVEL DRIVE
- 49 -	PROPOSED CONCRETE SIDEWALK
	PROPOSED HEAVY-DUTY CONCRETE PAVEMENT
	PROPOSED GRAVEL MULTI–USE PATH (ALTERNATE X)
	METHANE VENT AND 20' CLEAR ZONE

NIC = NOT IN CONTRACT

## NOTES

1. SEE SHEET L2.00 FOR LANDSCAPE NOTES, PLANT SCHEDULE, AND LANDSCAPE DETAILS.

# PLANT LEGEND

ORNAMENTAL TREE	COMMON NAME			
•	Chaste Tree			
<u>SHRUBS</u>	COMMON NAME			
$\bigcirc$	Butterfly Bush			
	Andorra Juniper			
SHAW HERE	Pixie Loropetalum			
$\bigcirc$	Dwarf Variegated Pittosporum			
ORNAMENTAL GRASSES	COMMON NAME			
	Katrinus Deluxe Mat Rush			
+	Shenandoah Switch Grass			
GROUND COVERS	COMMON NAME			
	Bermuda 419			
	Brown Eyed Susan			
9 6 6 9 6 9 9 6 9 9 6 9	Autumn Joy Sedum			
2000 2000 2000 2000 2000 2000 2000 200	Delaware Chalet River Rock			



GRAPHIC SCALE

1 inch = 100

PRELIMINARY DRAWING - NOT RELEASED FOR CONSTRUCTION



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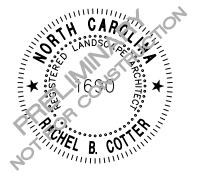
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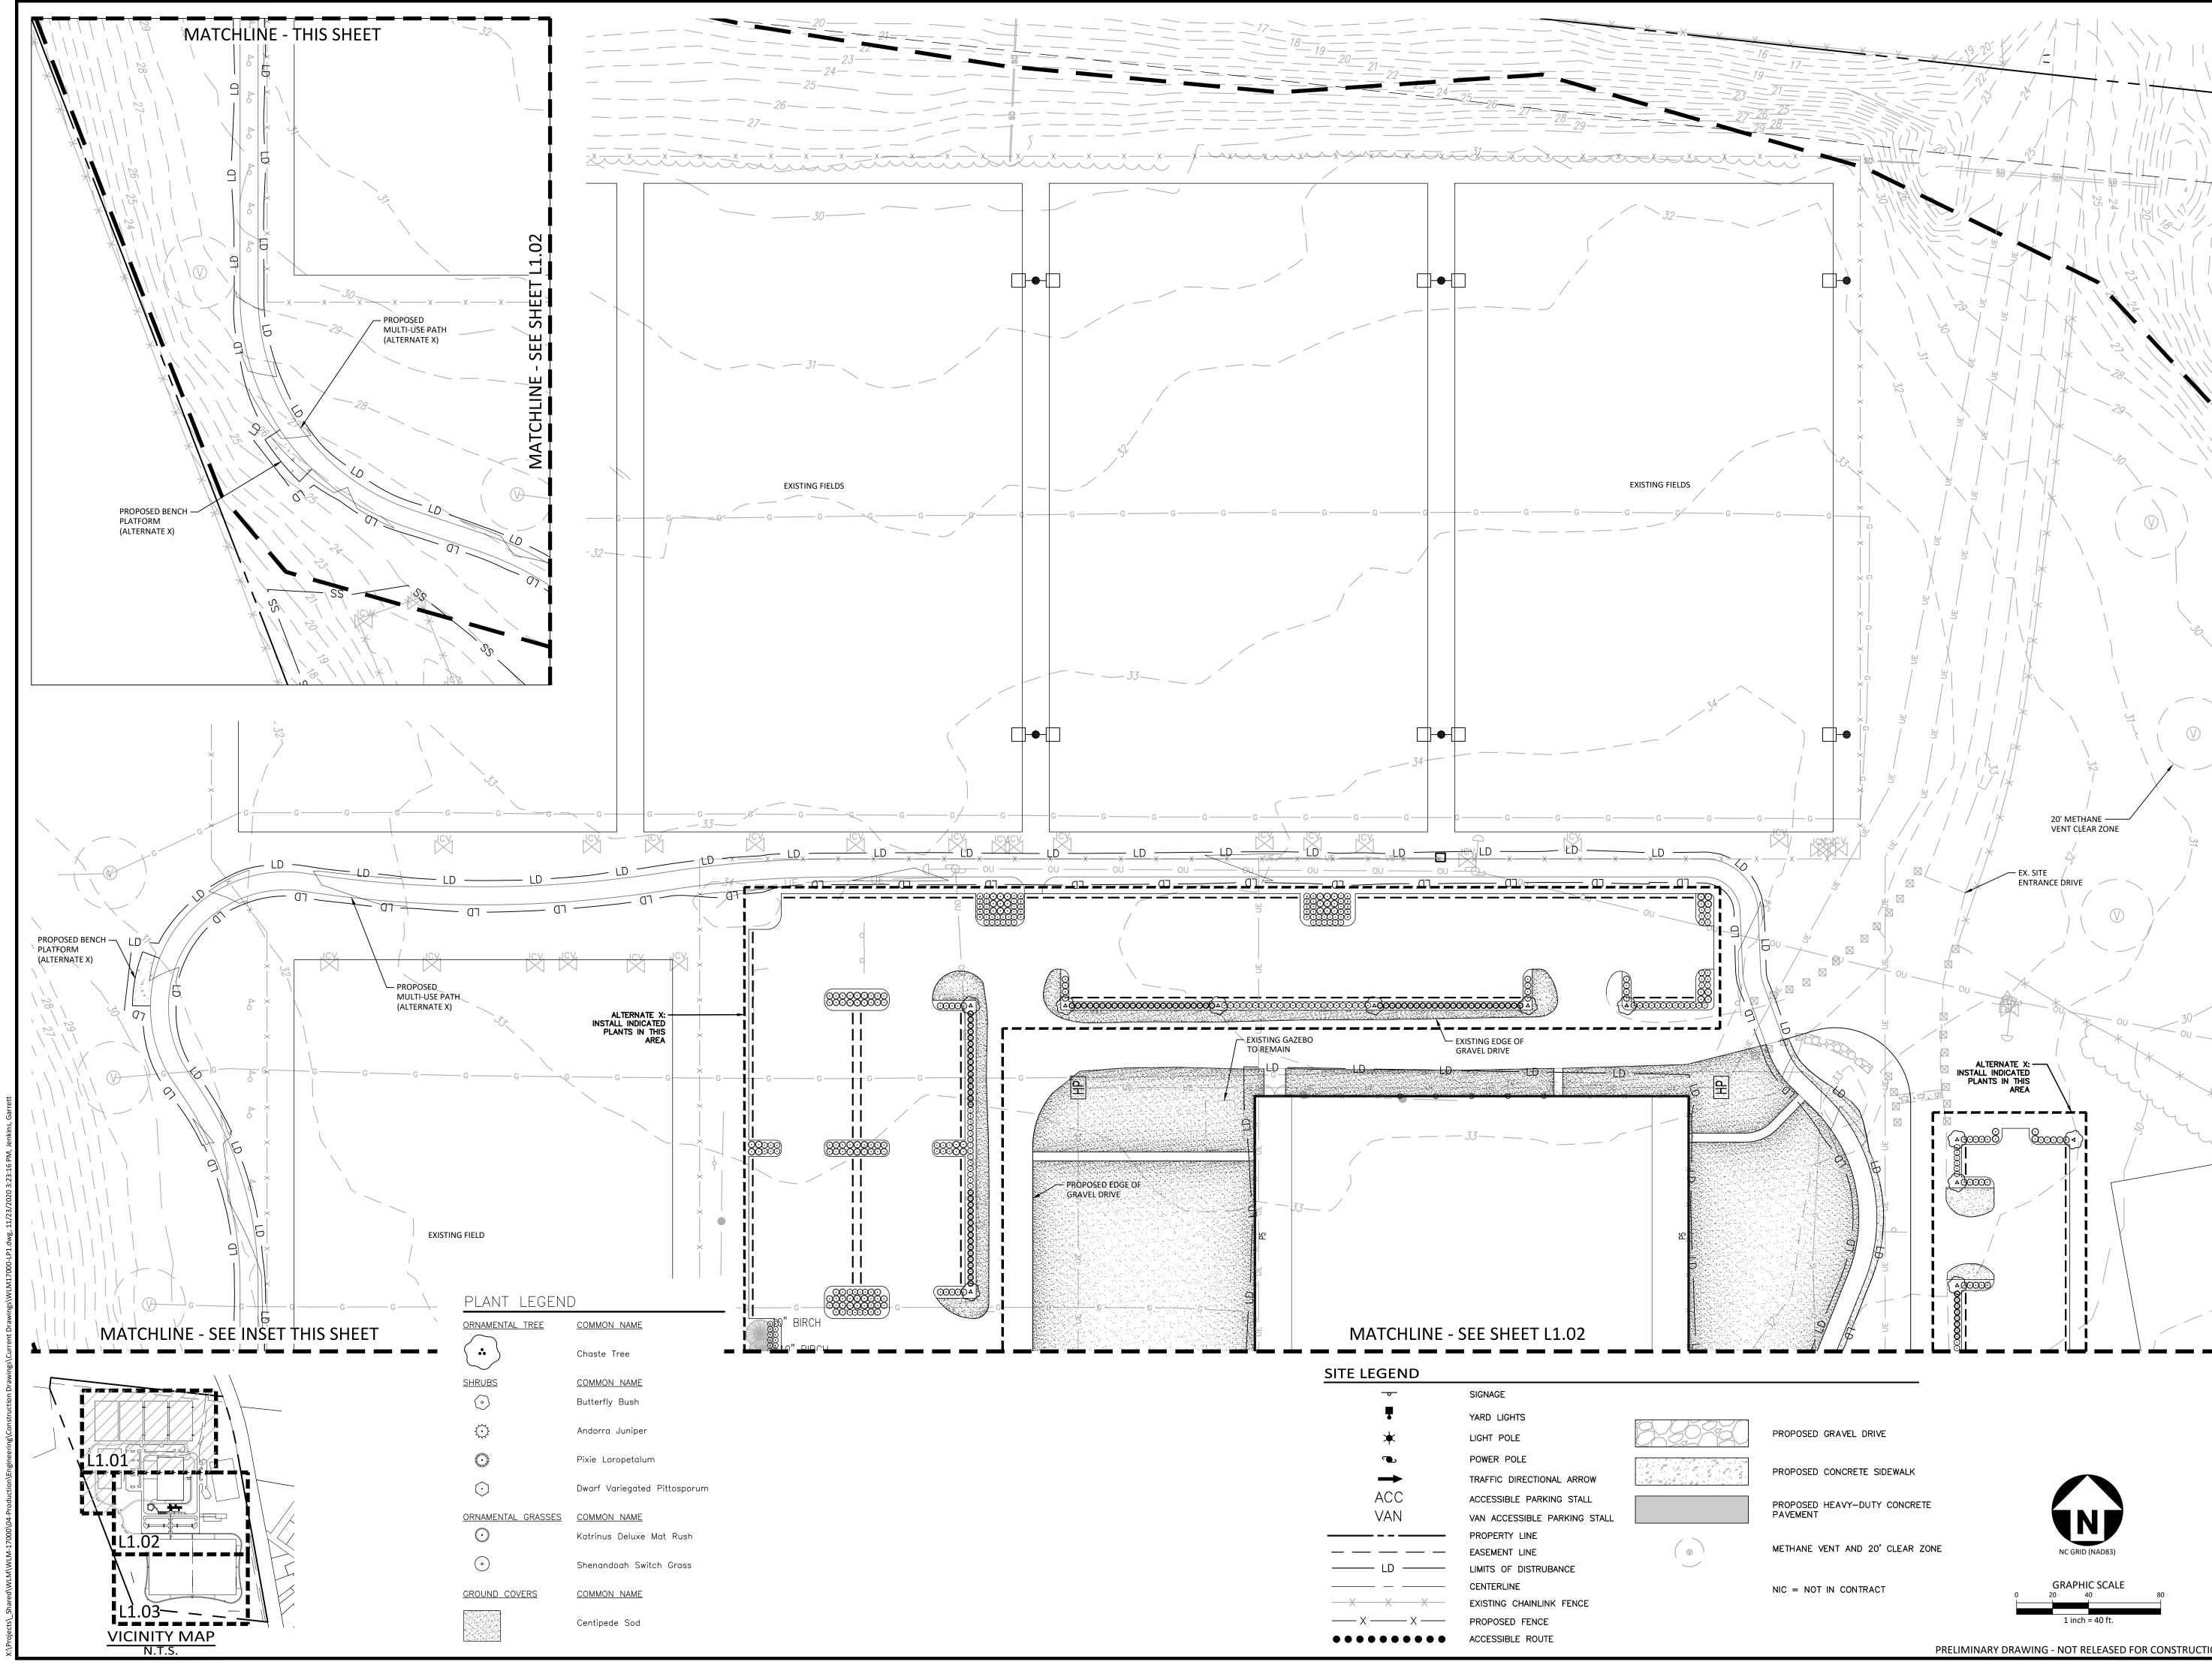


#### REVISIONS

NO. DATE

PROJECT NO.	WLM-17000
FILENAME	WLM17000-LS1
CHECKED BY	-
DRAWN BY	GLJ
SCALE	SEE DRAWINGS
DATE	11.11.20
SHEET	







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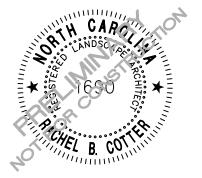
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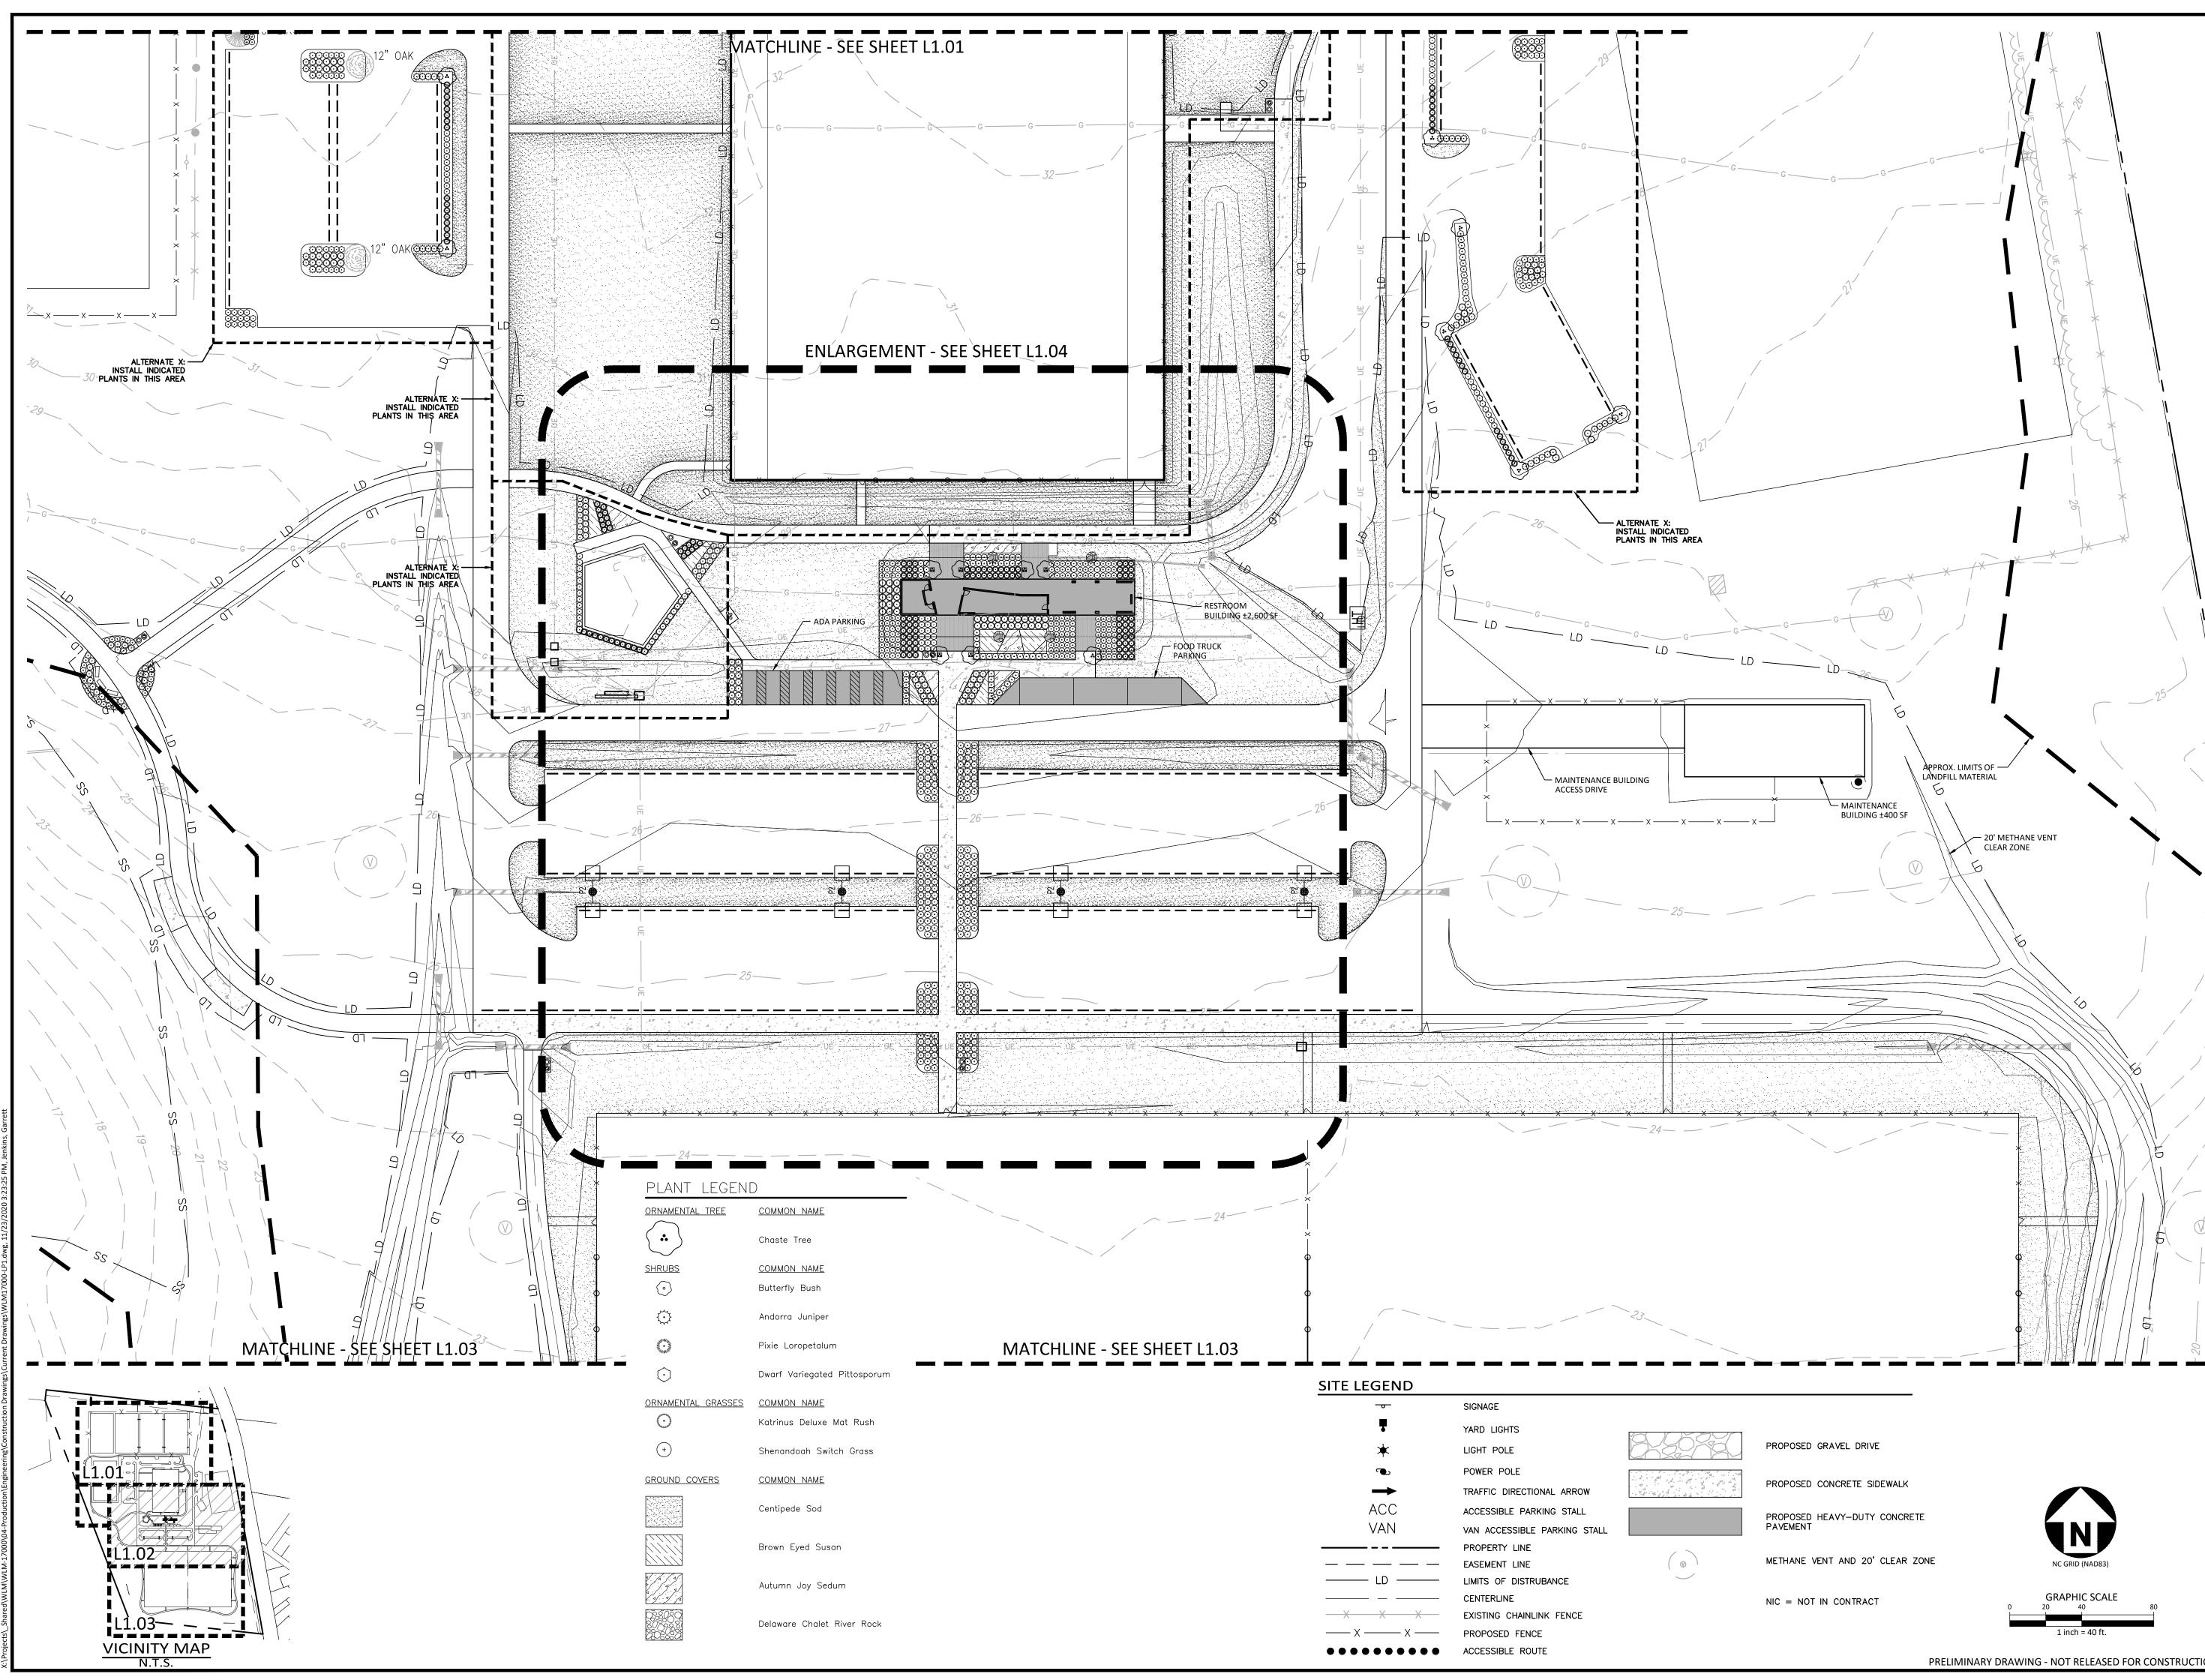
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#### PLAN INFORMATION

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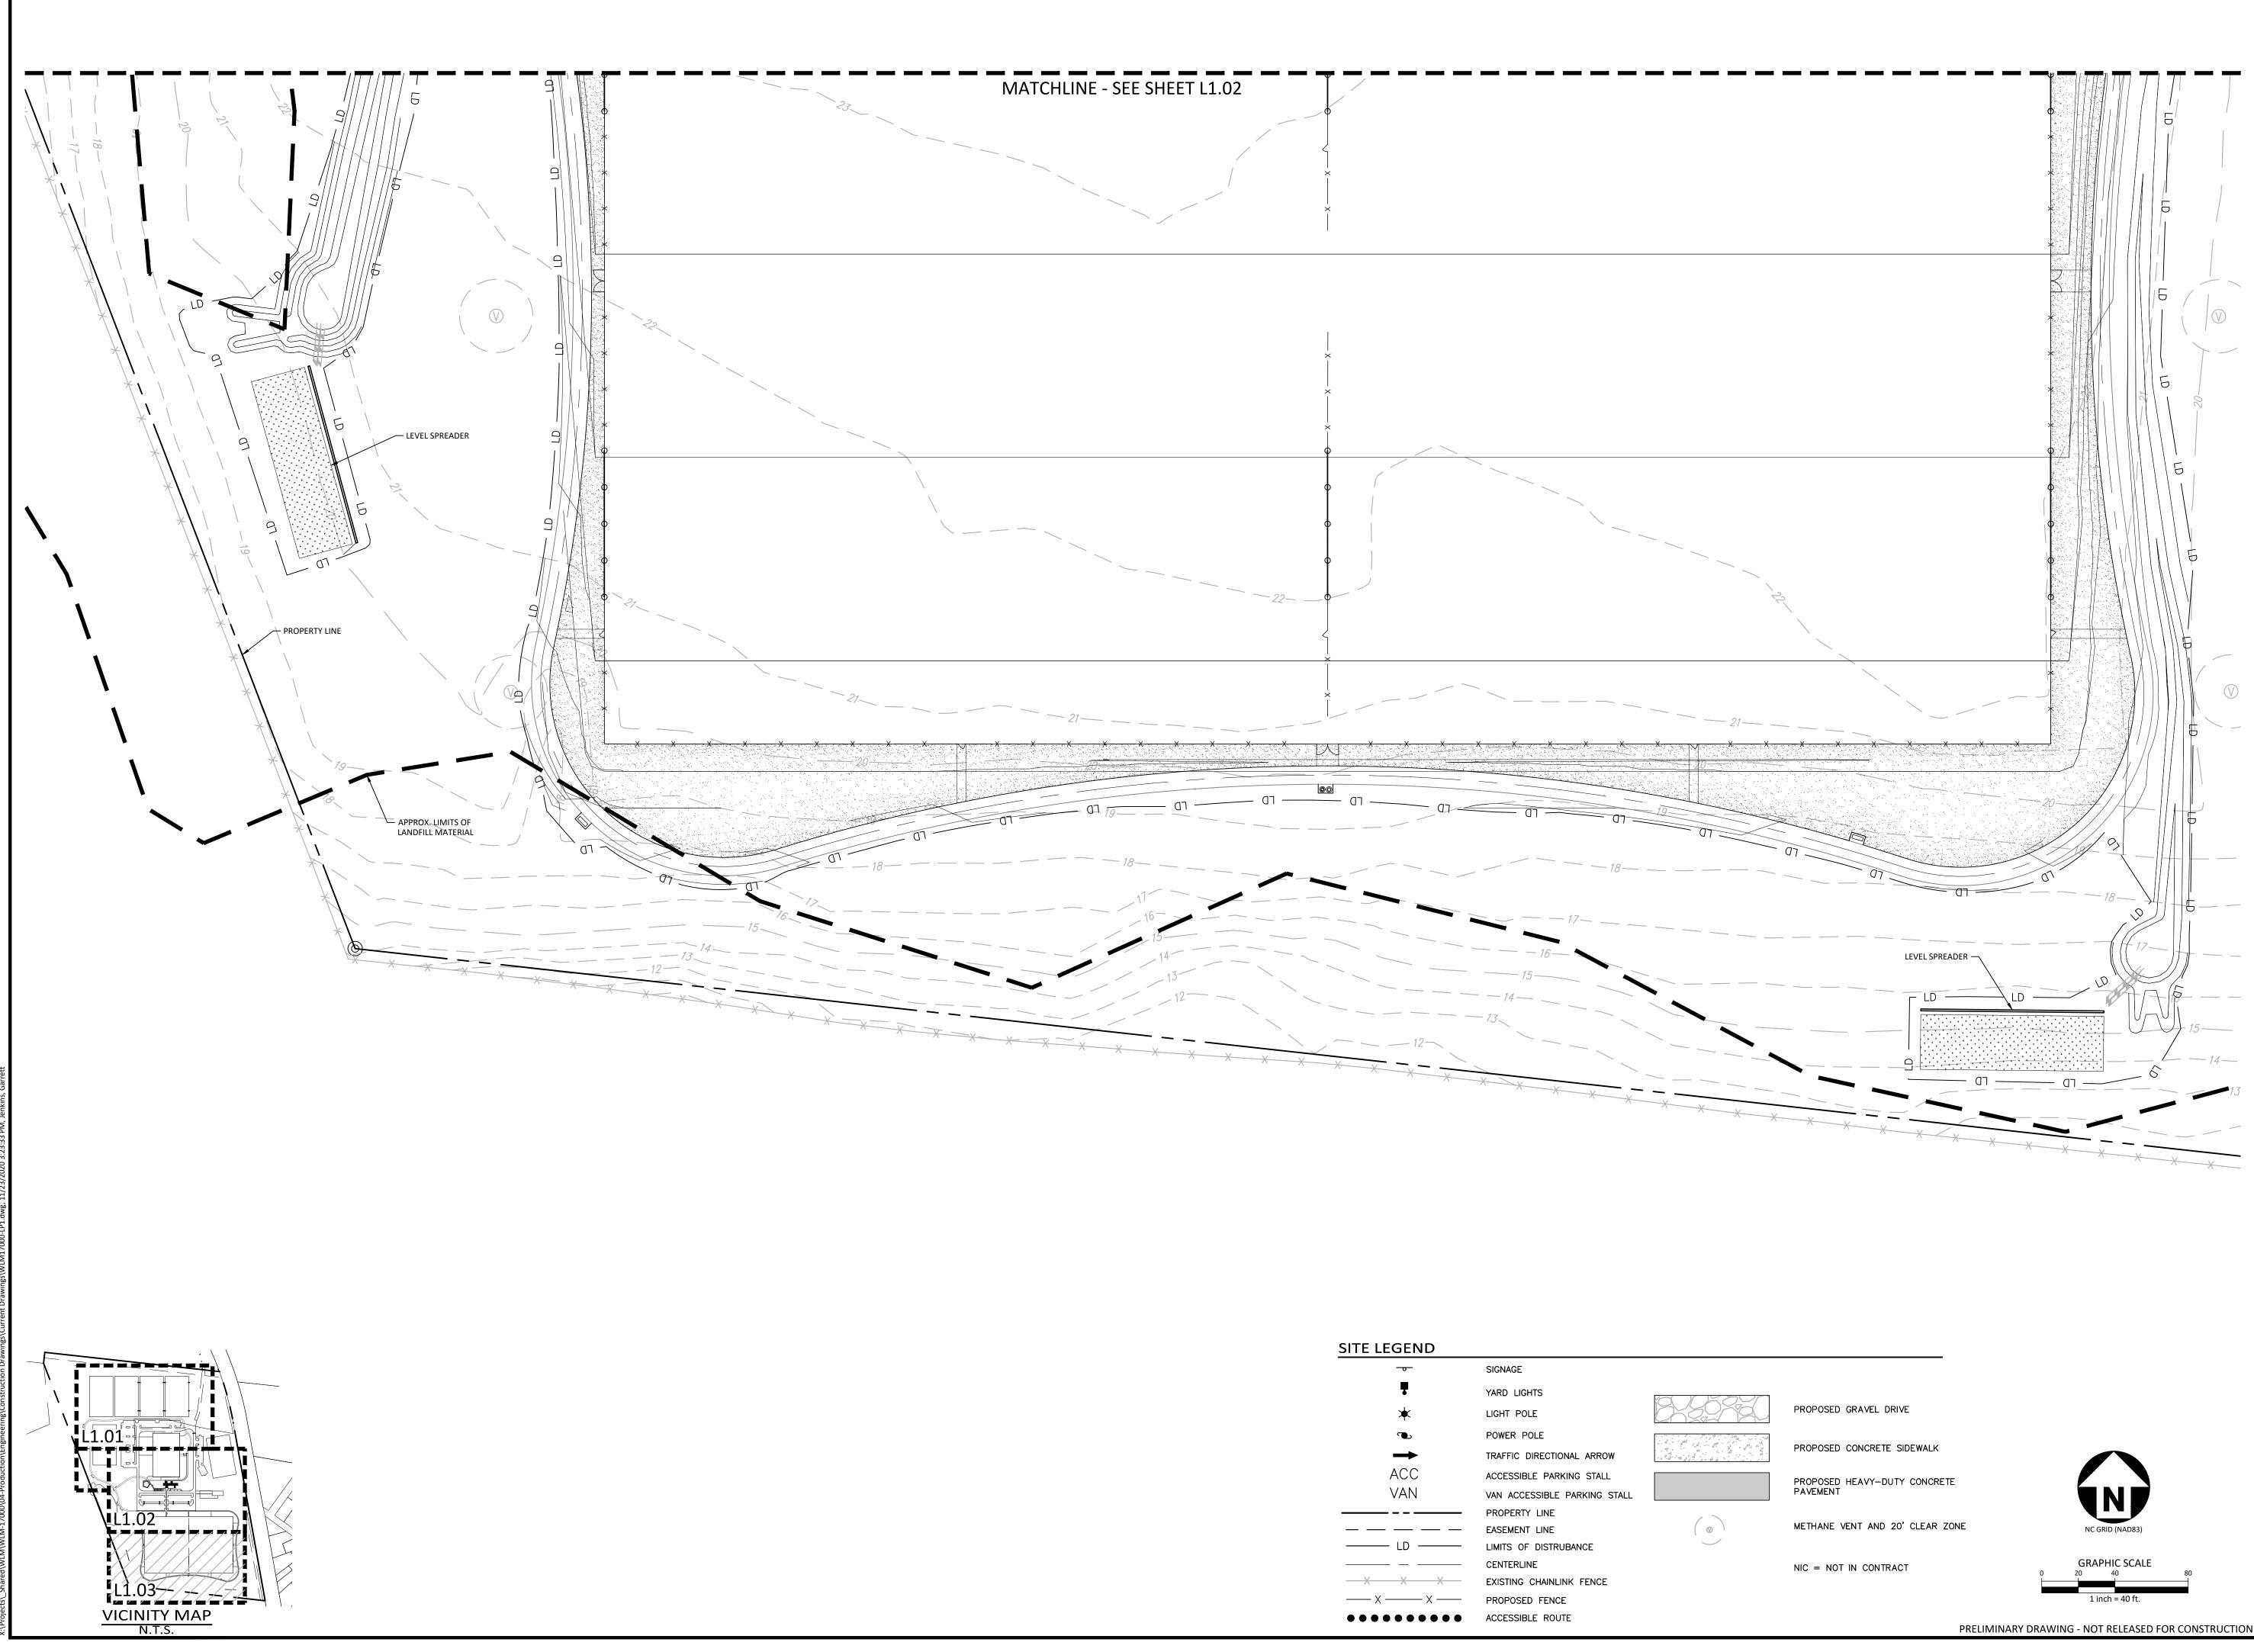
#### PLAN INFORMATION

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DATE	11.11.20
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DRAWN BY	GLJ
CHECKED BY	-
FILENAME	WLM17000-LS1
PROJECT NO.	WLM-17000

AREA 'B' LANDSCAPE PLAN

	PROPOSED	GRAVEL DE	RIVE
9	PROPOSED	CONCRETE	SIDEW

PRELIMINARY DRAWING - NOT RELEASED FOR CONSTRUCTION



SITE LEGEND	
<del></del>	SIGNAGE
7	YARD LIGHTS
*	LIGHT POLE
L	POWER POLE
$\rightarrow$	TRAFFIC DIRECTIO
ACC	ACCESSIBLE PARK
VAN	VAN ACCESSIBLE
	PROPERTY LINE
	EASEMENT LINE
LD	LIMITS OF DISTRU
	CENTERLINE
— X X X	EXISTING CHAINLIN
— X — X —	PROPOSED FENCE



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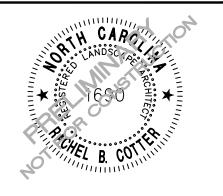
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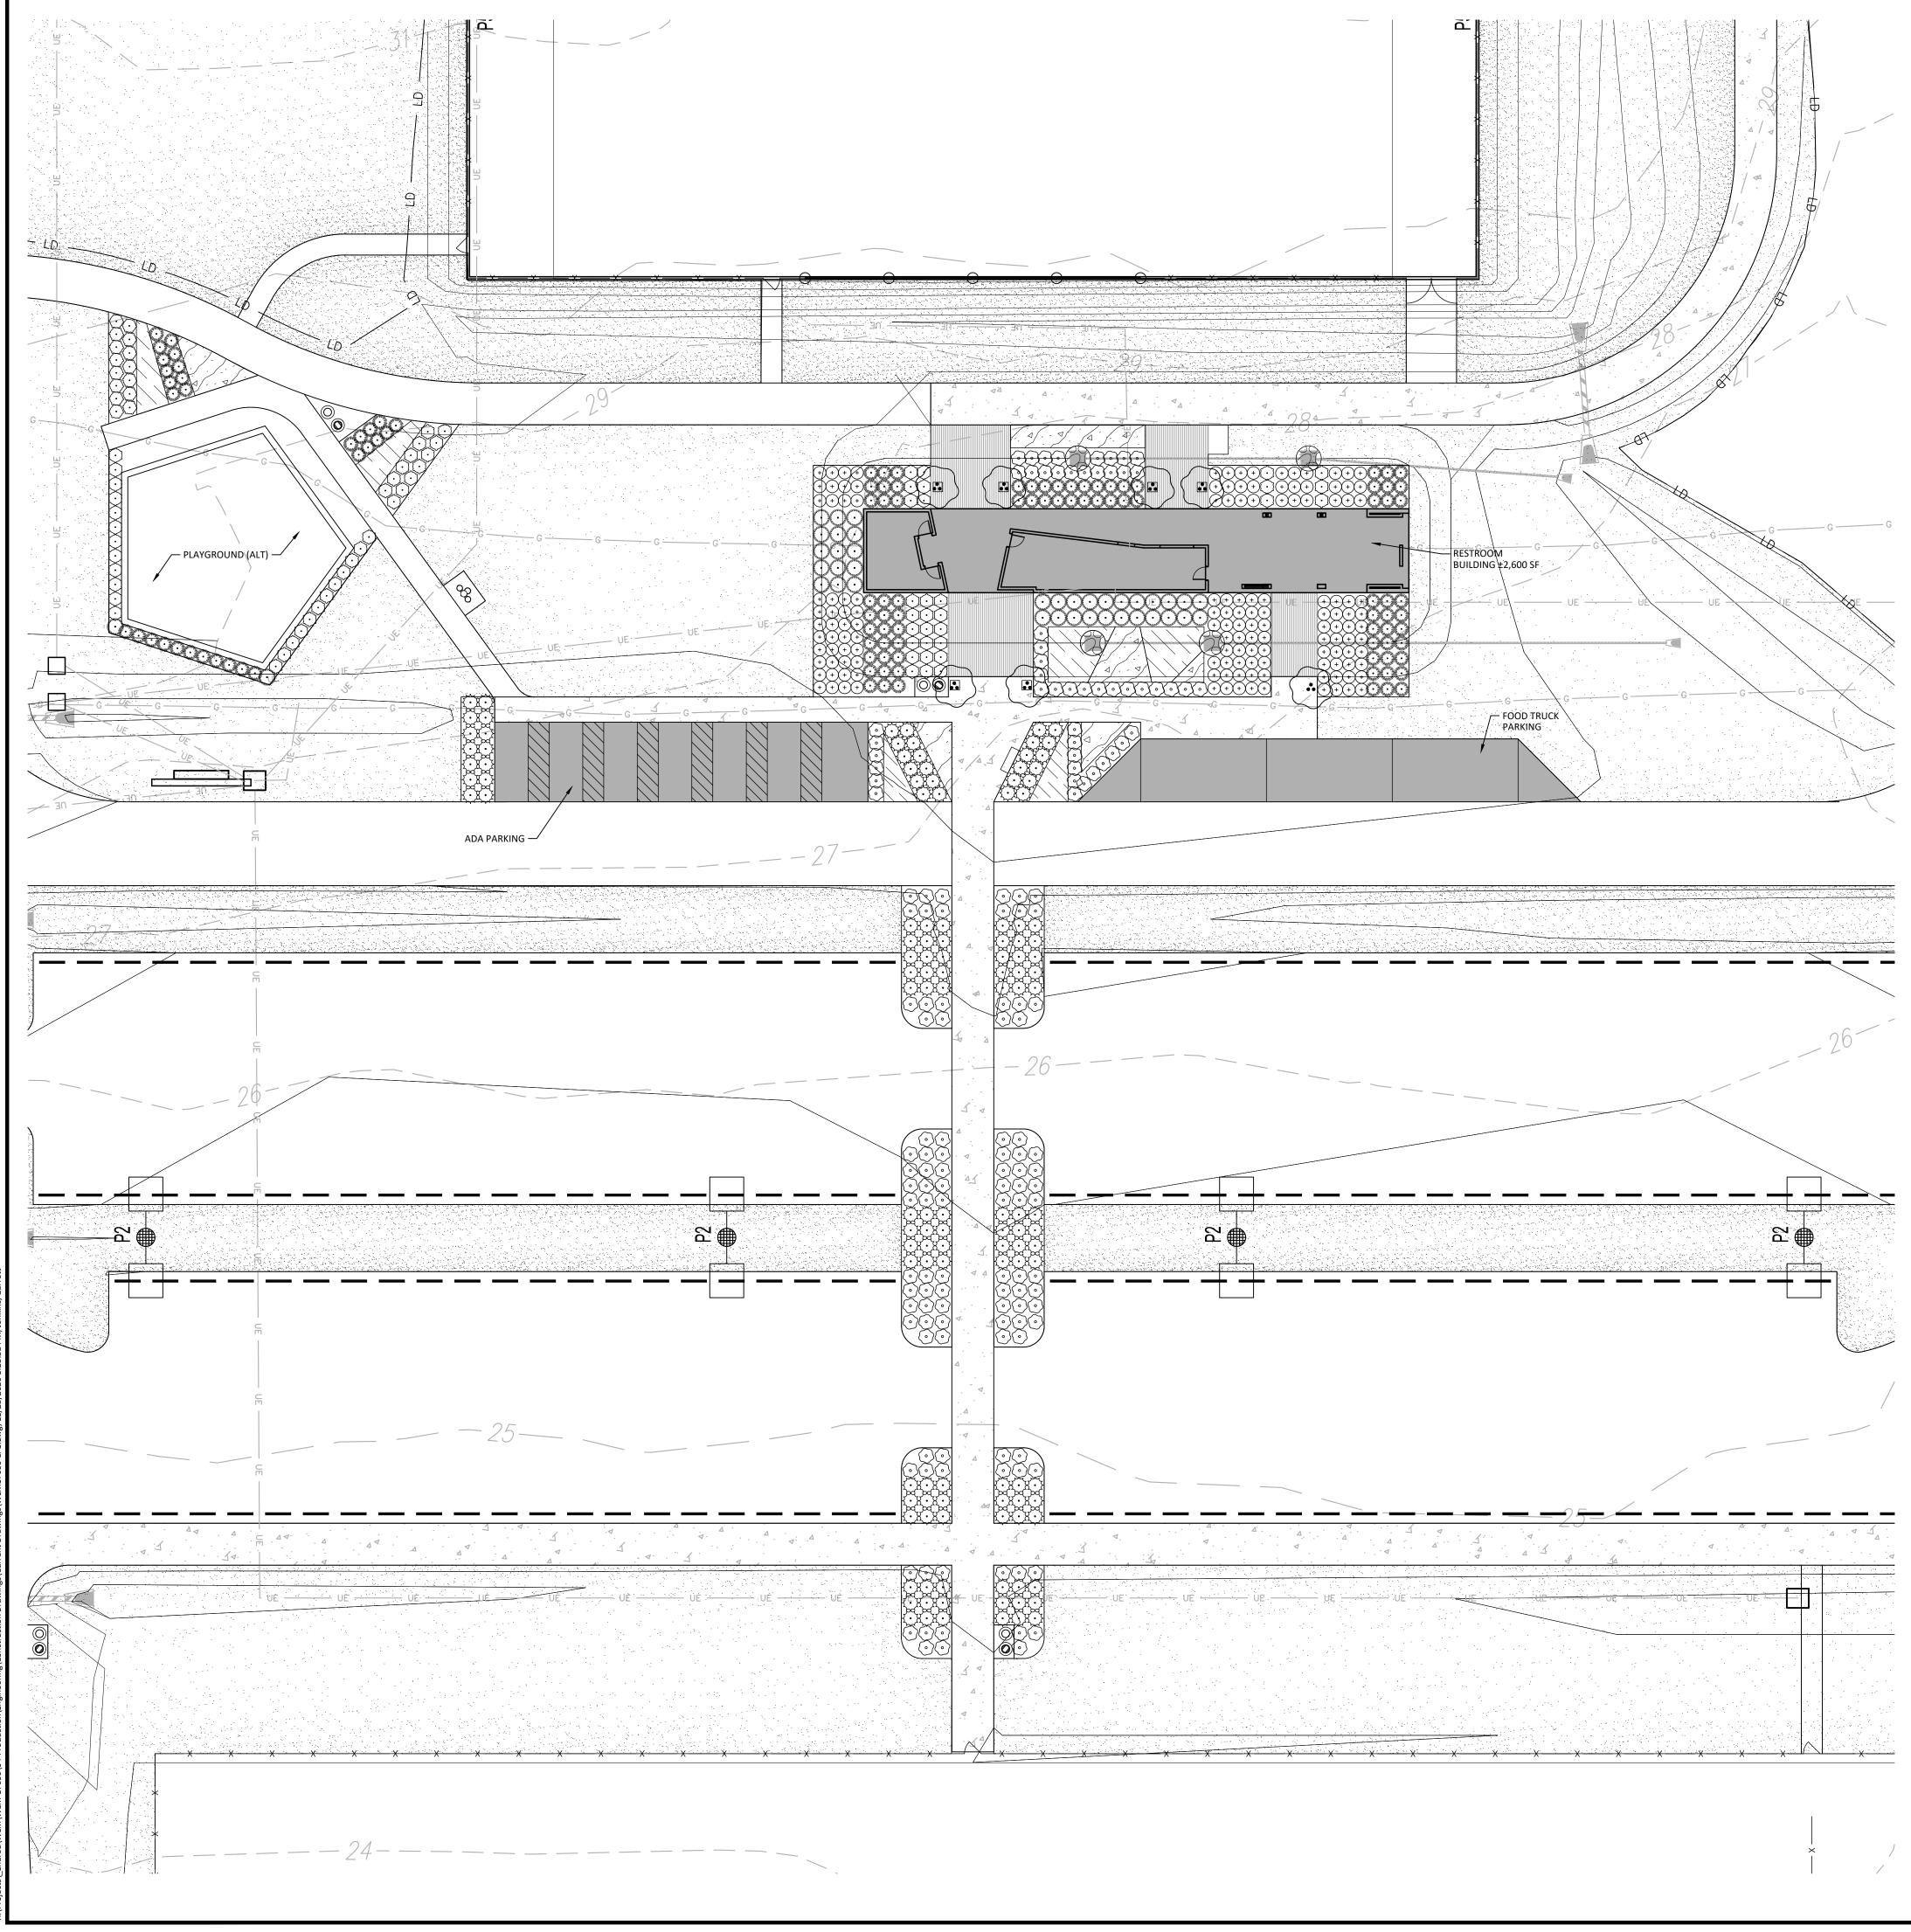
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## PLAN INFORMATION


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DATE	11.11.20
SCALE	SEE DRAWINGS
DRAWN BY	GLJ
CHECKED BY	-
FILENAME	WLM17000-LS1
PROJECT NO.	WLM-17000

AREA 'B' LANDSCAPE PLAN 3

	PROPOSED	GRAVEL [	DRIVE
đ	PROPOSED	CONCRET	F SIDEV



#### SITE LEGEND

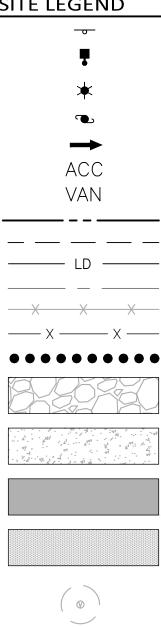

SIGNAGE
YARD LIGHTS
LIGHT POLE
POWER POLE
TRAFFIC DIRECTIONAL ARROW
ACCESSIBLE PARKING STALL
VAN ACCESSIBLE PARKING STALL
PROPERTY LINE
EASEMENT LINE
LIMITS OF DISTRUBANCE
CENTERLINE
EXISTING CHAINLINK FENCE
PROPOSED FENCE
ACCESSIBLE ROUTE
PROPOSED GRAVEL DRIVE
PROPOSED CONCRETE SIDEWALK
PROPOSED HEAVY-DUTY CONCRETE PAVEMENT

PROPOSED GRAVEL MULTI–USE PATH (ALTERNATE X)

METHANE VENT AND 20' CLEAR ZONE

NIC = NOT IN CONTRACT

#### NOTES

1. SEE SHEET L2.00 FOR LANDSCAPE NOTES, PLANT SCHEDULE, AND LANDSCAPE DETAILS.

## PLANT LEGEND

ORNAMENTAL TREE	COMMON NAME
	Chaste Tree
SHRUBS	COMMON NAME
$\bigcirc$	Butterfly Bush
↓	Andorra Juniper
NUM NAME OF THE OF THE NAME OF	Pixie Loropetalum
$\bigcirc$	Dwarf Variegated Pittosporum
ORNAMENTAL GRASSES	COMMON NAME
	Katrinus Deluxe Mat Rush
+	Shenandoah Switch Grass
GROUND COVERS	COMMON NAME
	Centipede Sod
	Brown Eyed Susan
9 / 1 / 9 / 9 / 9 / 9 9 / 9 / 1 9 / 9 / 1	Autumn Joy Sedum
	Delaware Chalet River Rock



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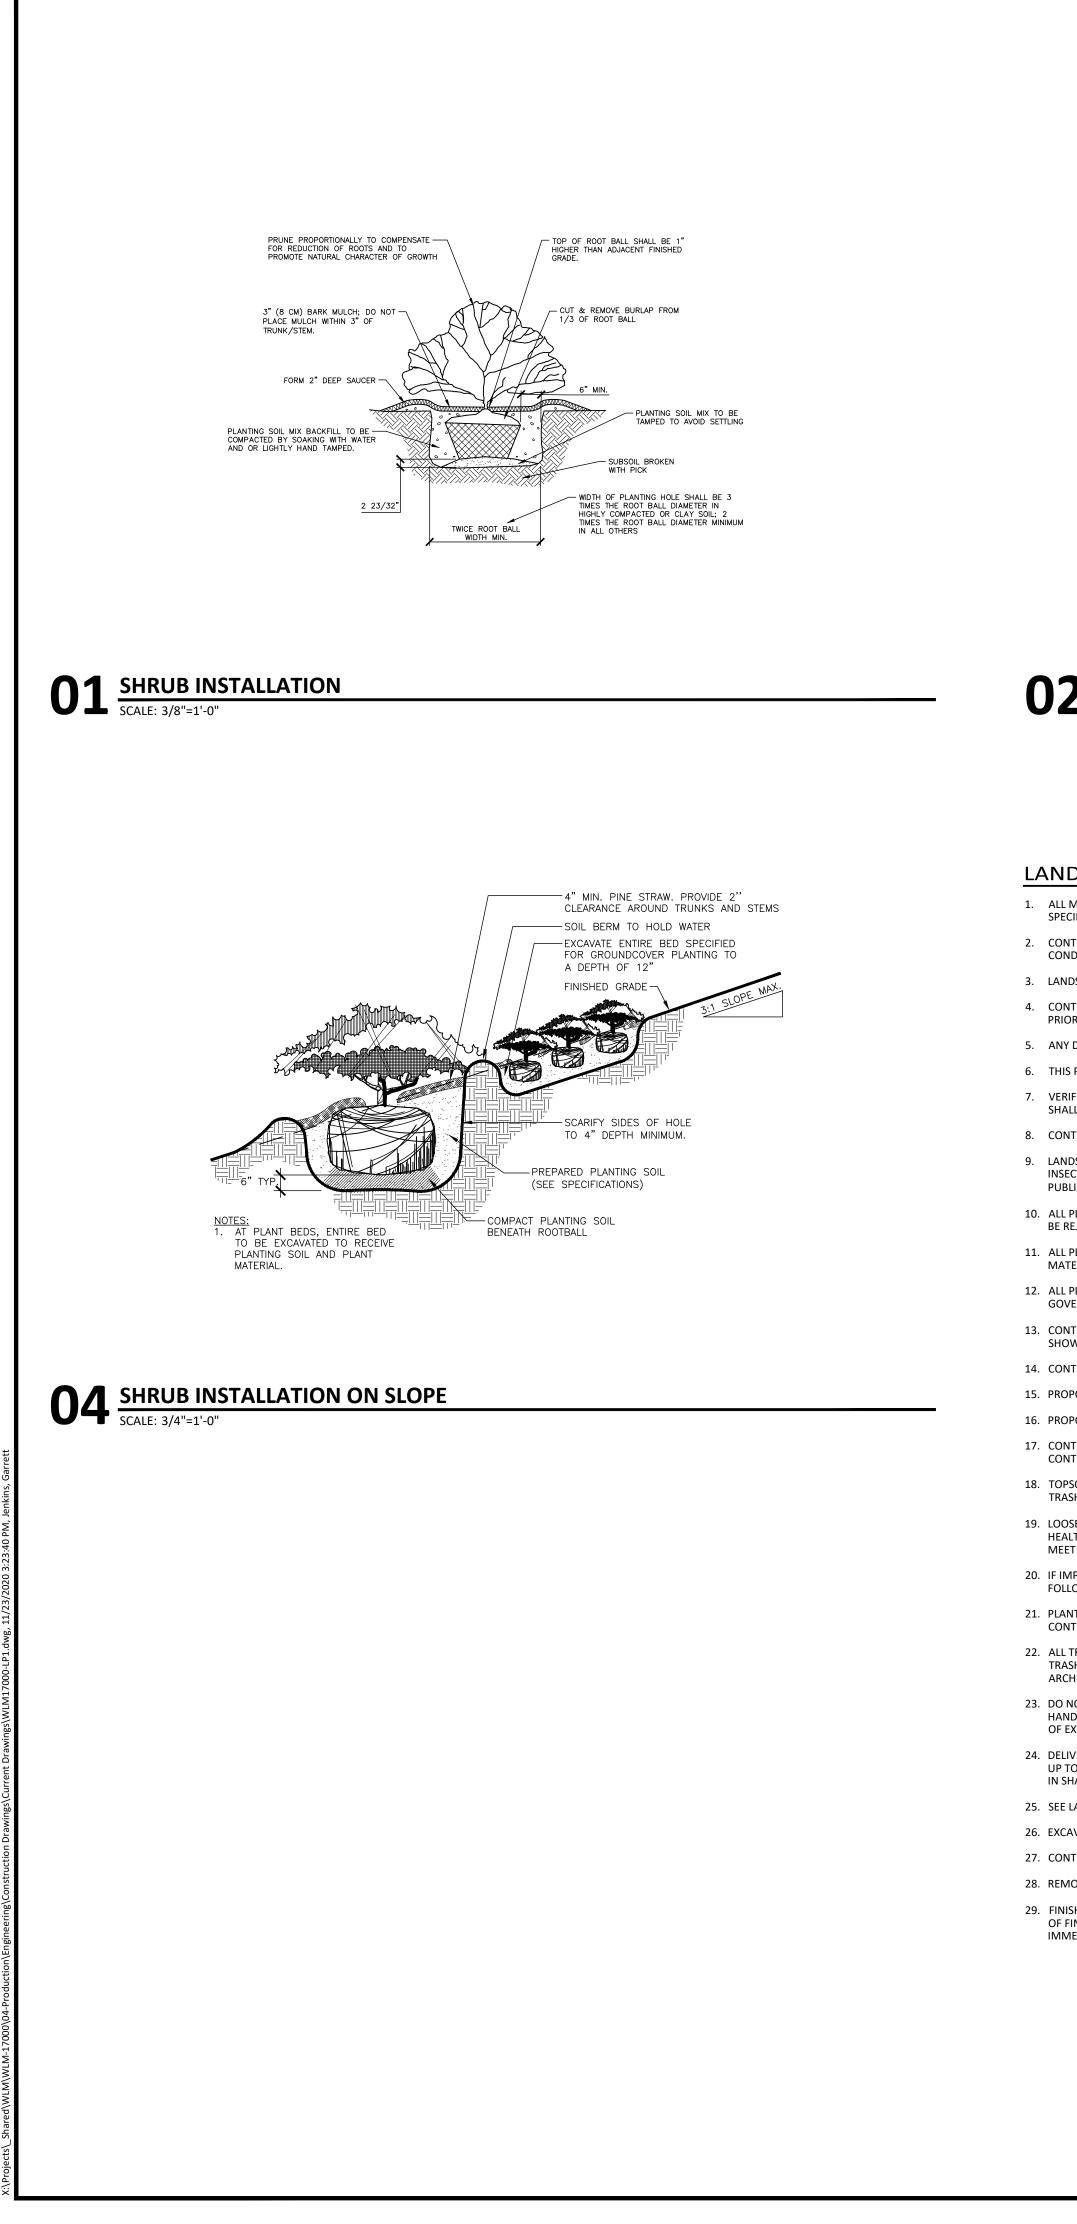



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SCALE	SEE DRAWINGS
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SHEET	







# 02 GROUNDCOVER INSTALLATION SCALE: 3/8"=1'-0"

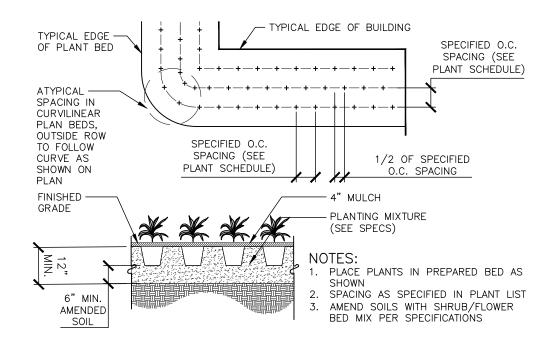

OVERALL PLANT SCHEDULE

<u>CODE</u> <u>QTY</u>

VACA 25

ORNAMENTAL TREE

..

" MIN

MULCH

FINISHED

#### LANDSCAPE NOTES

1. ALL MATERIALS AND METHODS OF CONSTRUCTION SHALL BE IN ACCORDANCE WITH NEW HANOVER COUNTY AND THE STATE OF NORTH CAROLINA STANDARDS AND SPECIFICATIONS.

2. CONTRACTOR IS RESPONSIBLE FOR THE SITE INSPECTION BEFORE LANDSCAPE CONSTRUCTION AND INSTALLATION IN ORDER TO BECOME FAMILIAR WITH THE EXISTING CONDITIONS.

3. LANDSCAPE CONTRACTOR IS RESPONSIBLE FOR LOCATING ALL UNDERGROUND UTILITIES BEFORE BEGINNING DEMOLITION OR INSTALLATION.

4. CONTRACTOR SHALL NOTIFY LANDSCAPE ARCHITECT OF ANY DISCREPANCIES BETWEEN THE NOTES, SPECIFICATIONS, DRAWINGS OR SITE CONDITIONS FOR RESOLUTION PRIOR TO INSTALLATION.

5. ANY DAMAGE TO UTILITIES SHALL BE REPAIRED AT THE CONTRACTOR'S EXPENSE

6. THIS PLAN IS FOR PLANTING PURPOSES ONLY. FOR INFORMATION REGARDING BUILDINGS, GRADING, WALLS, ETC., REFER TO ARCHITECTURE, SITE AND GRADING PLANS. 7. VERIFICATION OF TOTAL PLANT QUANTITIES AS SHOWN IN THE PLANT SCHEDULE SHALL BE THE RESPONSIBILITY OF THE LANDSCAPE CONTRACTOR. ANY DISCREPANCIES SHALL BE BROUGHT TO THE ATTENTION OF THE LANDSCAPE ARCHITECT.

8. CONTRACTOR TO ENSURE PROPER STABILIZATION AND SEEDING OF THE SITE IN ACCORDANCE WITH APPLICABLE REGULATIONS.

#### 9. LANDSCAPE MATERIAL SHALL BE WELL FORMED, VIGOROUS, GROWING SPECIMENS WITH GROWTH TYPICAL OF VARIETIES SPECIFIED AND SHALL BE FREE FROM DAMAGE, INSECTS AND DISEASES. MATERIAL SHALL EQUAL OR SURPASS #1 QUALITY AS DEFINED IN THE CURRENT ISSUE OF "AMERICAN STANDARD FOR NURSERY STOCK" AS PUBLISHED BY THE AMERICAN NURSERY & LANDSCAPE ASSOCIATION.

10. ALL PLANT MATERIAL IS TO BE CAREFULLY HANDLED BY THE ROOT BALL, NOT THE TRUNK, BRANCHES AND/OR FOLIAGE OF THE PLANT. MISHANDLED PLANT MATERIAL MAY BE REJECTED BY THE LANDSCAPE ARCHITECT.

11. ALL PLANT MATERIAL IS TO BE WELL ROOTED, NOT ROOT BOUND, SUCH THAT THE ROOT BALL REMAINS INTACT THROUGHOUT THE PLANTING PROCESS. DEFICIENT PLANT MATERIAL MAY BE REJECTED BY THE LANDSCAPE ARCHITECT OR OWNER.

12. ALL PLANTS TO BE A MINIMUM OF WHAT IS SPECIFIED IN THE PLANT SCHEDULE. ANY CHANGES OR SUBSTITUTIONS SHALL BE APPROVED BY THE LANDSCAPE ARCHITECT AND GOVERNING JURISDICTION PRIOR TO ANY HOLE BEING DUG.

13. CONTRACTOR TO COORDINATE WITH OWNER'S REPRESENTATIVE AND LANDSCAPE ARCHITECT TO ESTABLISH THE EXTENTS OF MULCH/SEED/SOD IF NOT SPECIFICALLY SHOWN ON PLANS.

14. CONTRACTOR SHALL PROVIDE POSITIVE DRAINAGE IN ALL PLANTING AREAS.

15. PROPOSED TREES TO BE PLANTED A MINIMUM 10 FEET FROM ANY LIGHT POLE AS MEASURED FROM TRUNK OF THE TREE TO THE POLE.

16. PROPOSED TREES TO BE PLANTED A MINIMUM 5 FEET FROM ANY FIRE HYDRANT AS MEASURED FROM TRUNK OF THE TREE TO THE HYDRANT. 17. CONTRACTOR SHALL COMPLETE SOIL TEST IN ALL PLANTING AREAS TO DETERMINE SOIL AMENDMENT REQUIREMENTS UNLESS WAIVED BY OWNER'S REPRESENTATIVE.

CONTRACTOR SHALL ADJUST PH AND FERTILITY BASED UPON THE SOIL TEST RESULTS.

18. TOPSOIL SHALL BE FREE OF MATERIAL LARGER THAN 1.0 INCH IN DIAMETER OR LENGTH AND SHALL NOT CONTAIN SLAG, CINDERS, STONES, LUMPS OF SOIL, STICKS, ROOTS, TRASH, OR OTHER EXTRANEOUS MATERIAL.

19. LOOSEN SUBGRADE / SURFACE SOIL TO A MINIMUM DEPTH OF 6 INCHES. APPLY SOIL AMENDMENTS AND FERTILIZERS AS REQUIRED BY THE SOIL TEST RESULTS TO ACHIEVE A HEALTHY GROWING MEDIA AND MIX THOROUGHLY INTO TOP 4 INCHES OF SOIL. SPREAD PLANTING SOIL MIX TO A DEPTH OF 6 INCHES BUT NOT LESS THAN REQUIRED TO MEET FINISH GRADES AFTER NATURAL SETTLEMENT. DO NOT SPREAD IF PLANTING SOIL OR SUBGRADE IS FROZEN, MUDDY, OR EXCESSIVELY WET.

20. IF IMPORTED TOPSOIL IS REQUIRED, THE SUBGRADE SHALL BE SCARIFIED OR TILLED TO A DEPTH OF AT LEAST 6 INCHES PRIOR TO INSTALLATION OF IMPORTED TOPSOIL. FOLLOWING INSTALLATION OF IMPORTED TOPSOIL, THE TOPSOIL SHALL BE TILLED TO INTEGRATE THE SOIL PROFILES. 21. PLANT MATERIALS ARE TO BE GUARANTEED FOR A PERIOD OF 12 MONTHS. PLANT MATERIALS WHICH REMAIN UNHEALTHY WILL BE REPLACED BY THE LANDSCAPE

CONTRACTOR BEFORE THE EXPIRATION OF THE GUARANTEE PERIOD OR IMMEDIATELY IF SO DIRECTED BY THE OWNER'S REPRESENTATIVE OR LANDSCAPE ARCHITECT.

22. ALL TREE PLANTINGS SHALL BE MULCHED TO A DEPTH OF 3 INCHES, AND WITH A MINIMUM 3 FOOT RADIUS FROM BASE OF TREE OR TO DRIPLINE. MULCH SHALL BE FREE OF TRASH AND MAINTAINED WEED FREE. MULCH SHALL NOT COVER THE ROOT FLARE. CONFIRM MULCH SPECIFICATIONS WITH OWNER'S REPRESENTATIVE OR LANDSCAPE ARCHITECT.

23. DO NOT PRUNE TREES AND SHRUBS BEFORE DELIVERY. PROTECT BARK, BRANCHES, AND ROOT SYSTEMS FROM SUN SCALD, DRYING, SWEATING, WHIPPING, AND OTHER HANDLING AND TYING DAMAGE. DO NOT BEND OR BIND-TIE TREES OR SHRUBS IN SUCH A MANNER AS TO DESTROY THEIR NATURAL SHAPE. PROVIDE PROTECTIVE COVERING OF EXTERIOR PLANTS DURING DELIVERY. DO NOT DROP EXTERIOR PLANTS DURING DELIVERY AND HANDLING.

24. DELIVER EXTERIOR PLANTS AFTER PREPARATIONS FOR PLANTING HAVE BEEN COMPLETED AND INSTALL IMMEDIATELY. IMMEDIATELY AFTER UNLOADING, STAND THE TREES UP TO REDUCE THE RISK OF SUN SCALD. PROPERLY STAGED TREES ARE STANDING, UNTIED AND SPACED. UNLESS IMMEDIATELY INSTALLED, SET EXTERIOR PLANTS AND TREES IN SHADE, PROTECT FROM WEATHER AND MECHANICAL DAMAGE, AND KEEP ROOTS MOIST.

25. SEE LANDSCAPE DETAILS FOR TREE STAKING REQUIREMENTS.

26. EXCAVATE EDGES OF ALL PLANTING BEDS TO 2 INCH DEPTH TO FORM A NEAT AND CRISP DEFINITION. 27. CONTRACTOR SHALL REMOVE DEBRIS AND FINE GRADE ALL PLANTING AREAS PRIOR TO INSTALLATION.


28. REMOVE GUY WIRES AND STAKES AT END OF WARRANTY PERIOD OR ESTABLISHMENT.

29. FINISH GRADING: GRADE PLANTING AREAS TO A SMOOTH, UNIFORM SURFACE PLANE WITH LOOSE, UNIFORMLY FINE TEXTURE. GRADE TO WITHIN PLUS OR MINUS 1/2 INCH OF FINISH ELEVATION. ROLL AND RAKE, REMOVE RIDGES, AND FILL DEPRESSIONS TO MEET FINISH GRADES. LIMIT FINISHED GRADING TO AREAS THAT CAN BE PLANTED IN THE IMMEDIATE FUTURE.

#### <u>SHRUBS</u> <u>CODE</u> <u>QTY</u> $\bigcirc$ BDBB 200 <u></u> JHAN 300 • LCRP 237 $\bigcirc$ PTDV 279 ORNAMENTAL GRASSES CODE QTY MANNA ANNA LLKD 118 (+)PVSG 189 <u>GROUND COVERS</u> <u>CODE</u><u>QTY</u> EROP 226,042 sf RTBS 685 SEAJ 658 SMDR 113 sf

BASE BID PLANT SCHEDULE

ORNAMENTAL TREE	<u>CODE</u>	QTY	<u>COMMON / BOTANICAL NAME</u>	<u>CAL</u>	HEIGHT
	VACA	7	Chaste Tree / Vitex agnus-castus 'Shoal Creek'	Multi	6' min
<u>SHRUBS</u>	<u>CODE</u>	QTY	COMMON / BOTANICAL NAME	<u>HEIGHT</u>	<u>SPACING</u>
$\bigcirc$	BDBB	154	Butterfly Bush / Buddleja davidii	18" min	
₹•• ₹	JHAN	128	Andorra Juniper / Juniperus horizontalis 'Andorra'	12" min	
Super States	LCRP	80	Pixie Loropetalum / Loropetalum chinense rubrum 'Pixie'	18" min	
$\bigcirc$	PTDV	30	Dwarf Variegated Pittosporum / Pittosporum tobira 'Dwarf Variegata'	18" min	
ORNAMENTAL GRASSES	<u>CODE</u>	<u>QTY</u>	<u>COMMON / BOTANICAL NAME</u>	<u>HEIGHT</u>	<u>SPACING</u>
And the second	LLKD	37	Katrinus Deluxe Mat Rush / Lomandra longifolia 'Katrinus Deluxe'	24" min	
(+)	PVSG	144	Shenandoah Switch Grass / Panicum virgatum 'Shenandoah'	18" min	
GROUND COVERS	<u>CODE</u>	QTY	COMMON / BOTANICAL NAME	<u>SPACING</u>	
	EROP	126,777 sf	Centipede Sod / Eremochloa ophiuroides		
	RTBS	466	Brown Eyed Susan / Rudbeckia triloba	12" o.c.	
9 6 6 9 6 6 9 6 9 8 9 8 9 8 9	SEAJ	527	Autumn Joy Sedum / Sedum x 'Autumn Joy'	12" o.c.	
	SMDR	113 sf	Delaware Chalet River Rock / Stone Mulch		

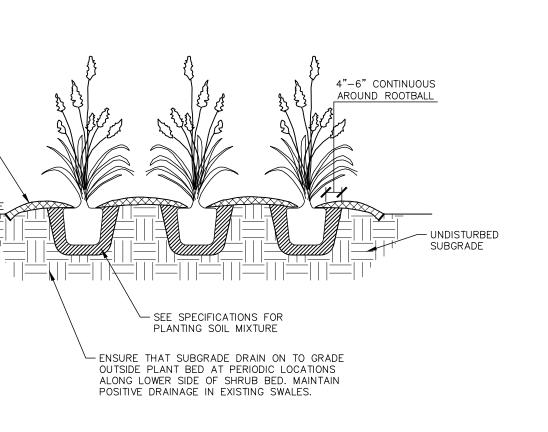

<u>COMMON / BOTANICAL NAME</u>	<u>CAL</u>	<u>HEIGHT</u>
Chaste Tree / Vitex agnus—castus 'Shoal Creek' Planters	Multi	6' min
COMMON / BOTANICAL NAME	<u>HEIGHT</u>	<u>SPACING</u>
Butterfly Bush / Buddleja davidii	18" min	
Andorra Juniper / Juniperus horizontalis 'Andorra'	12" min	
Pixie Loropetalum / Loropetalum chinense rubrum 'Pixie'	18" min	
Dwarf Variegated Pittosporum / Pittosporum tobira 'Dwarf Variegata'	18" min	
<u>COMMON / BOTANICAL NAME</u>	<u>HEIGHT</u>	<u>SPACING</u>
Katrinus Deluxe Mat Rush / Lomandra longifolia 'Katrinus Deluxe'	24" min	
Shenandoah Switch Grass / Panicum virgatum 'Shenandoah'	18" min	
<u>COMMON / BOTANICAL NAME</u>	<u>CONT</u>	<u>HEIGHT</u>
Centipede Sod / Eremochloa ophiuroides	Sod	
Brown Eyed Susan / Rudbeckia triloba	4" pot	
Autumn Joy Sedum / Sedum x 'Autumn Joy'	4" pot	
Delaware Chalet River Rock / Stone Mulch	Stone	

**MCADAMS** 

The John R. McAdams Company, Inc. 2905 Meridian Parkway Durham, NC 27713

phone 919. 361. 5000 fax 919. 361. 2269 license number: C-0293, C-187

www.mcadamsco.com

#### CLIENT

CITY OF WILMINGTON 305 CHESTNUT STREET, 5TH FLOOR WILMINGTON, NC 28402 PHONE: 910. 341. 7830







#### REVISIONS

NO. DATE

#### PLAN INFORMATION

LANDSCAPE DETAILS,	
SHEET	
DATE	11.11.20
SCALE	SEE DRAWINGS
DRAWN BY	GLJ
CHECKED BY	-
FILENAME	WLM17000-LS1
PROJECT NO.	WLM-17000

**SCHEDULE + NOTES** 

PRELIMINARY DRAWING - NOT RELEASED FOR CONSTRUCTION