

## **NEW HANOVER COUNTY**

### PLANNING & LAND USE

230 Government Center Drive, Suite 110, Wilmington, NC 28403 P: (910) 798-7165 | F: (910) 798-7053 | NHCgov.com

Wayne Clark, Director

# PRELIMINARY/SITE PLAN APPROVAL

To: Phil Tripp – Tripp Engineering, P.C. (ptripp@trippengineering.com)

Della Baird - Tripp Engineering, P.C. (office@trippengineering.com)

From: Gideon Smith

Current Planner

Date: September 11, 2020

Subject: Site Plan Approval – Davis Community Phase 1

The site plan and landscape plan for Phase 1 of the Davis Community Expansion have been approved. The approved commercial site plan consists of a 7,290 square foot centralized service building and two 4,980 square foot duplexes with associated parking and landscaping for Phase 1 of the Davis Community on 17.34 acres of land located at 1011 Porters Neck Road. Enclosed is the approved site plan and landscape plan. Please note that a separate tree removal permit has been issued (TR-20-000032) for this phase.

Please note that this approval supersedes the approval issued on September 3, 2020 due to the revisions of the limits of disturbance.

This approval is valid for two years unless a building permit or zoning compliance approval authorizing the approved development is obtained.

Please note the project may be subject to additional regulations of the County's development ordinances, including, but not limited to, those referenced in the TRC comments dated July 10, 2020, and as revised. In addition, this approval does not relieve the applicant from any law, regulation, or requirement of any other government or regulatory agency.


If you have any questions or concerns, please do not hesitate to contact me at (910) 798-7571 or <a href="mailto:gismith@nhcgov.com">gismith@nhcgov.com</a>.

Sincerely,

Gideon Smith
Current Planner

cc: TRC (Fire Services, Engineering, CFPUA, NCDOT)

Enclosure

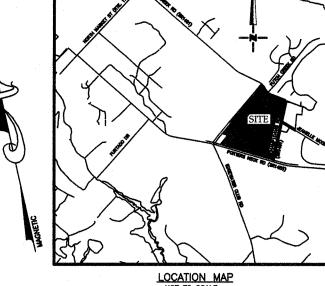



**BOWMAN** MURRAY HEMINGWAY

ARCHITECT 514 Market Street Wilmington, NC 28401 Tel — (910) 762—2621 Fax — (910) 762—8506

R03700-001-005-000 R03700-002-001-000 AREA NOT IN A FEMA 100-YEAR FLOOD ZONE Z20-07

CORNELIA NIXON DAVIS INC

1007 & 1011 PORTERS NECK ROAD

ZONING DISTRICT R-20 RESIDENTIAL TRACT AREA 2,492,352 SF (57.22 AC) DISTURBED AREA

FRONT: 30 REAR: 25 SIDE (STREET): 22.5' SIDE (INTERIOR): 15' BUILDING USE WAREHOUSE/RESIDENTIAL

PROPOSED BUILDING AREAS (GROSS) 17,250 SF BUILDING LOT COVERAGE (17,250/755,220) NUMBER OF PROPOSED BUILDINGS MAXIMUM BUILDING HEIGHT NUMBER OF STORIES

SITE DATA TABLE

PROJECT ADDRESS

R-20 CASE NUMBER

SETBACKS REQUIRED

PIN NUMBERS

PROPOSED IMPERVIOUS AREAS: PROPOSED CENTRALIZED SERVICE BUILDING PROPOSED DUPLEX BUILDINGS 44,988 S PROPOSED ASPHALT PROPOSED CONCRETE PROPOSED FUTURE 3,628 SI 2,884 SI

68,750 SF PROPOSED IMPERVIOUS TOTAL 686,870 SF EXISTING IMPERVIOUS 755,620 SF EXISTING + PROPOSED IMPERVIOUS

PROPOSED PARKING REQUIRED: (DWELLING, SINGLE FAMILY) 2 SPACES PER DWELLING UNIT 4 DWELLING UNITS 2 SPACES \* 4 UNIT 8 SPACES REQUIRED

PROPOSED PARKING REQUIRED: (WAREHOUSE)
1.5/EACH 2 EMPLOYEES ON SHIFT
1/MANAGERIAL POSITION 1/EACH VEHICLE USED DIRECTLY IN CONDUCT OF BUSINESS PARKING REQUIRED: (WAREHOUSE) 15 SPACES REQUIRED (10 EMPLOYEES, 1 MANAGER, 4 WORK VEHICLES)

PROPOSED PARKING PROVIDED:

PUBLIC WATER AND SEWER BY CFPUA

EXISTING WATER FLOW: EXISTING SEWER FLOW: O GPD PROPOSED WATER FLOW: (240 GPD/1&2 BEDROOM UNITS (4 UNITS) 500 GPD/WASHING MACHINE (3 WASHING MACHINES) 1,500 GPD 100/LOADING BAY (2 LOADING BAYS) TOTAL (x 110%):

PROPOSED SEWER FLOW: (240 GPD/1&2 BEDROOM UNITS (4 UNITS) 500 GPD/WASHING MACHINE (3 WASHING MACHINES) 1,500 GPD 100/LOADING BAY (2 LOADING BAYS)

Certificate of Approval - New Hanover County Planning & Land Use 09/11/2020

PLANTATION NAP BOOK 34, PAGE 130

1) TOPOGRAPHY AND TREE SURVEY COMPLETED BY DANFORD AND 2) PERMITTING OF BUSINESS IDENTIFICATION SIGNAGE IS A SEPARATE 3) CONTRACTOR SHALL FIELD VERIFY SIZE, MATERIAL, INVERTS AND LÓCATION OF ALL EXISTING UTILITIES PRIOR TO INSTALLATION OF PROPOSED CONNECTIONS.

4) EXISTING EASEMENTS AS SHOWN. 5) CONTRACTOR SHALL MAINTAIN ALL-WEATHER ACCESS FOR EMERGENCY VEHICLES AT ALL TIMES DURING CONSTRUCTION.

## 1) SITE TO USE ON-SITE DUMPSTER.

1) ALL PAVEMENT MARKINGS IN PUBLIC RIGHTS-OF-WAY ARE TO BE THERMOPLASTIC AND MEET NCDOT STANDARDS. 3) TRAFFIC CONTROL DEVICES (INCLUDING SIGNS AND PAVEMENT MARKINGS) IN AREAS OPEN TO PUBLIC TRAFFIC ARE TO MEET MUTCD (MANUAL ON UNIFORM TRAFFIC CONTROL DEVICES) STANDARDS. 6) ANY BROKEN OR MISSING SIDEWALK PANELS, DRIVEWAY PANELS AND CURBING WILL BE REPLACED. 8) ALL TRAFFIC CONTROL SIGNS AND MARKINGS OFF THE

RÍGHT-OF-WAY ARE TO BE MAINTAINED BY THE PROPERTY OWNER IN ACCORDANCE WITH MUTCD STANDARDS. 10) NO STREETS PROPOSED. 11) NO OFF SITE PARKING PROPOSED. 15) ALL PARKING STALL MARKINGS AND LANE ARROWS WITHIN THE

PARKING AREAS SHALL BE WHITE. 16) STOP SIGNS AND STREET SIGNS TO REMAIN IN PLACE DURING 17) TACTILE WARNING MATS WILL BE INSTALLED ON ALL WHEELCHAIR

# <u>LANDSCAPING</u> LANDSCAPING TO BE PROVIDED BY OTHERS.

1) WATER AND SEWER SERVICE SHALL MEET CAPE FEAR PUBLIC UTILITY AUTHORITY (CFPUA) DETAILS AND SPECIFICATIONS. 2) PROJECT SHALL COMPLY WITH THE CFPUA CROSS CONNECTION CONTROL REQUIREMENTS. WATER METER(S) CANNOT BE RELEASED UNTIL ALL REQUIREMENTS ARE MET AND THE STATE HAS GIVEN THEIR 3) IF THE CONTRACTOR DESIRES CFPUA WATER FOR CONSTRUCTION, HE SHALL APPLY IN ADVANCE FOR THIS SERVICE AND MUST PROVIDE A REDUCED PRESSURE ZONE (RPZ) BACKFLOW PREVENTION DEVICE ON THE DEVELOPERS SIDE OF THE WATER METER BOX. 4) ANY IRRIGATION SYSTEM SUPPLIED BY CFPUA WATER SHALL COMPLY WITH THE CFPUA'S CONNECTION CONTROL REGULATION. CALL 332-6419 FOR INFORMATION. 5) ANY BACKFLOW PREVENTION DEVICES REQUIRED BY CFPUA WILL NEED TO BE ON THE LIST OF APPROVED DEVICES FOR USCFCCCHR OR ASSE.

6) PUBLIC WATER AND SEWER EXIST WITHIN WRIGHTSVILLE AVE. R/W. NO RECORDS OF INDIVIDUAL EASEMENTS EXIST. 7) CONTACT THE NORTH CAROLINA ONE CALL CENTER AT 1-800-632-4949 PRIOR TO DOING ANY DIGGING, CLEARING OR

8) ANY IRRIGATION SYSTEM SHALL BE EQUIPPED WITH A RAIN AND FREEZER SENSOR. 9) CONTRACTOR TO FIELD VERIFY EXISTING WATER AND SEWER SERVICE LÓCATIONS, SIZES AND MATERIALS PRIOR TO CONSTRUCTION. ENGINEER TO BE NOTIFIED OF ANY CONFLICTS.

## FIRE SERVICES 1) ALL NEW BUILDINGS SHALL COMPLY WITH SECTION 510 OF THE NC FIRE CODE, EMERGENCY RESPONDER RADIO COVERAGE SURVEY SHALL


BE CONDUCTED. IT IS RECOMMENDED THAT A PRE-CONSTRUCTION SURVEY BE COMPLETED. (PRE CONSTRUCTION SURVEYS ARE NOT MANDATORY.)

) NO SURFACE WATERS, REGULATORY FLOOD ZONES, PROTECTED VEGETATED SETBACKS, OR PROTECTED RIPARIAN BUFFERS EXIST ON SITE. 2) EVERY SCM IMPACTED BY SEDIMENTATION AND EROSION CONTROL DURING THE CONSTRUCTION PHASE SHALL BE CLEANED OUT AND CONVERTED TO ITS APPROVED DESIGN STATE.

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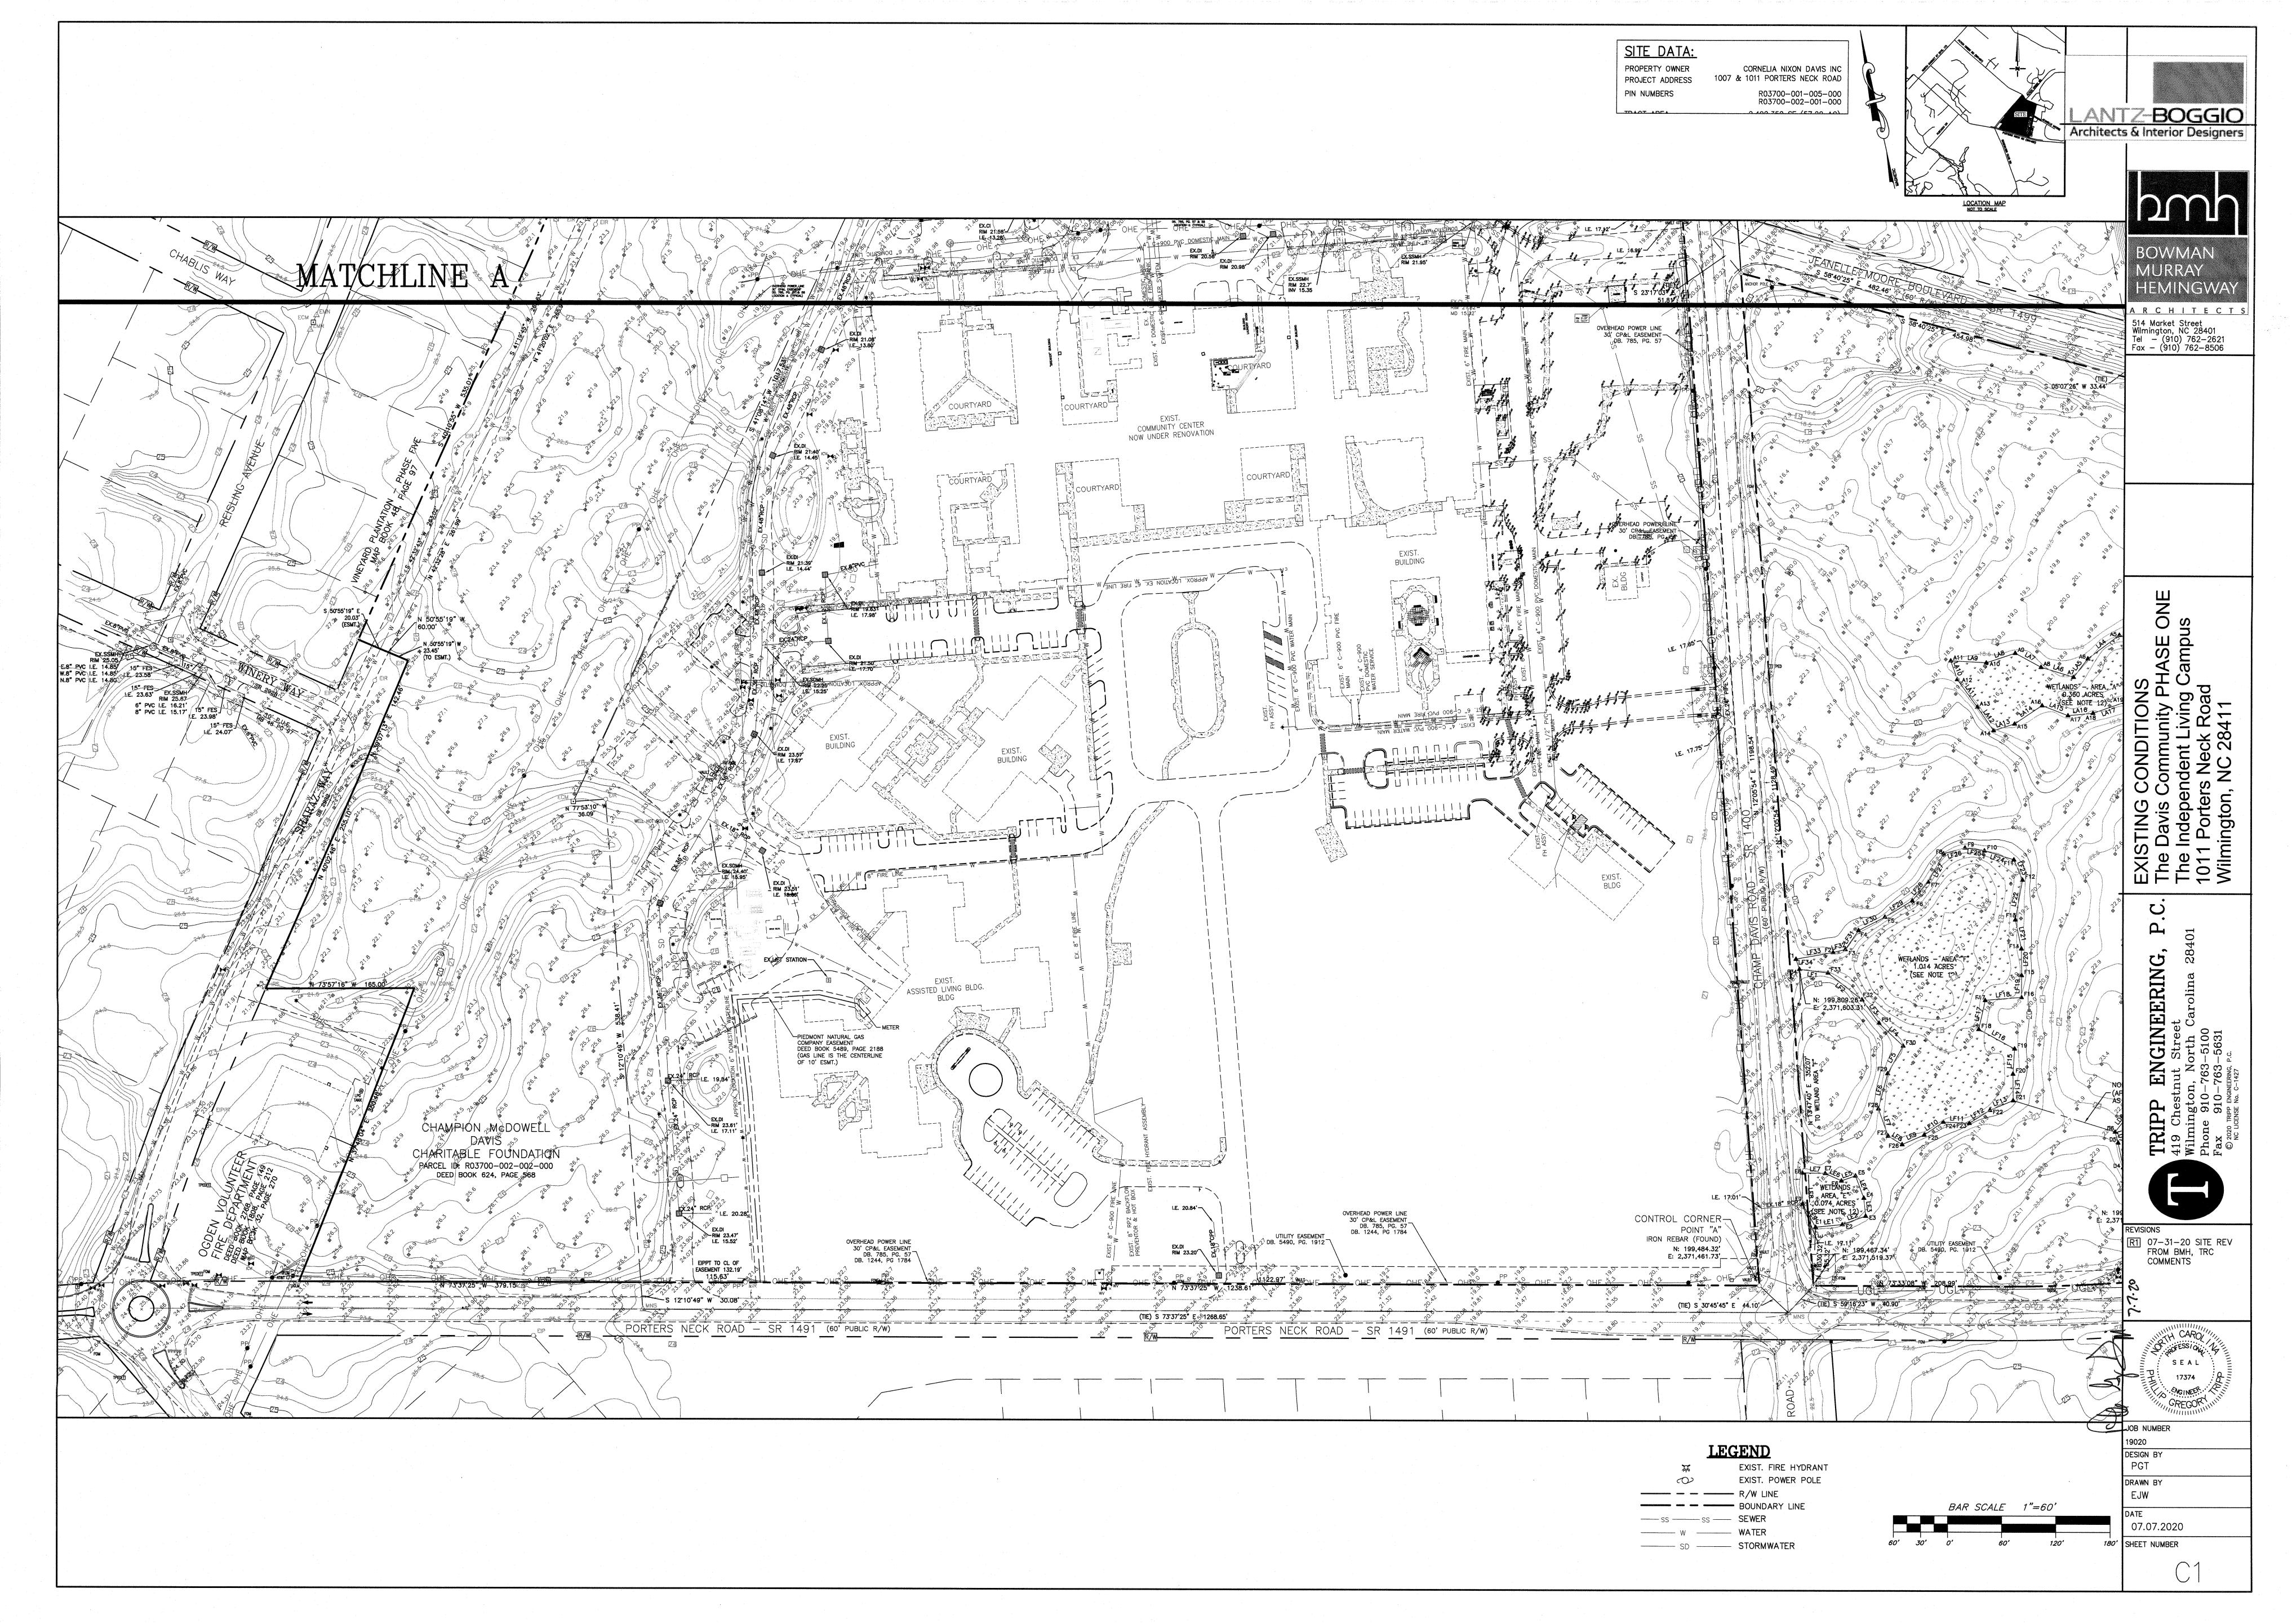
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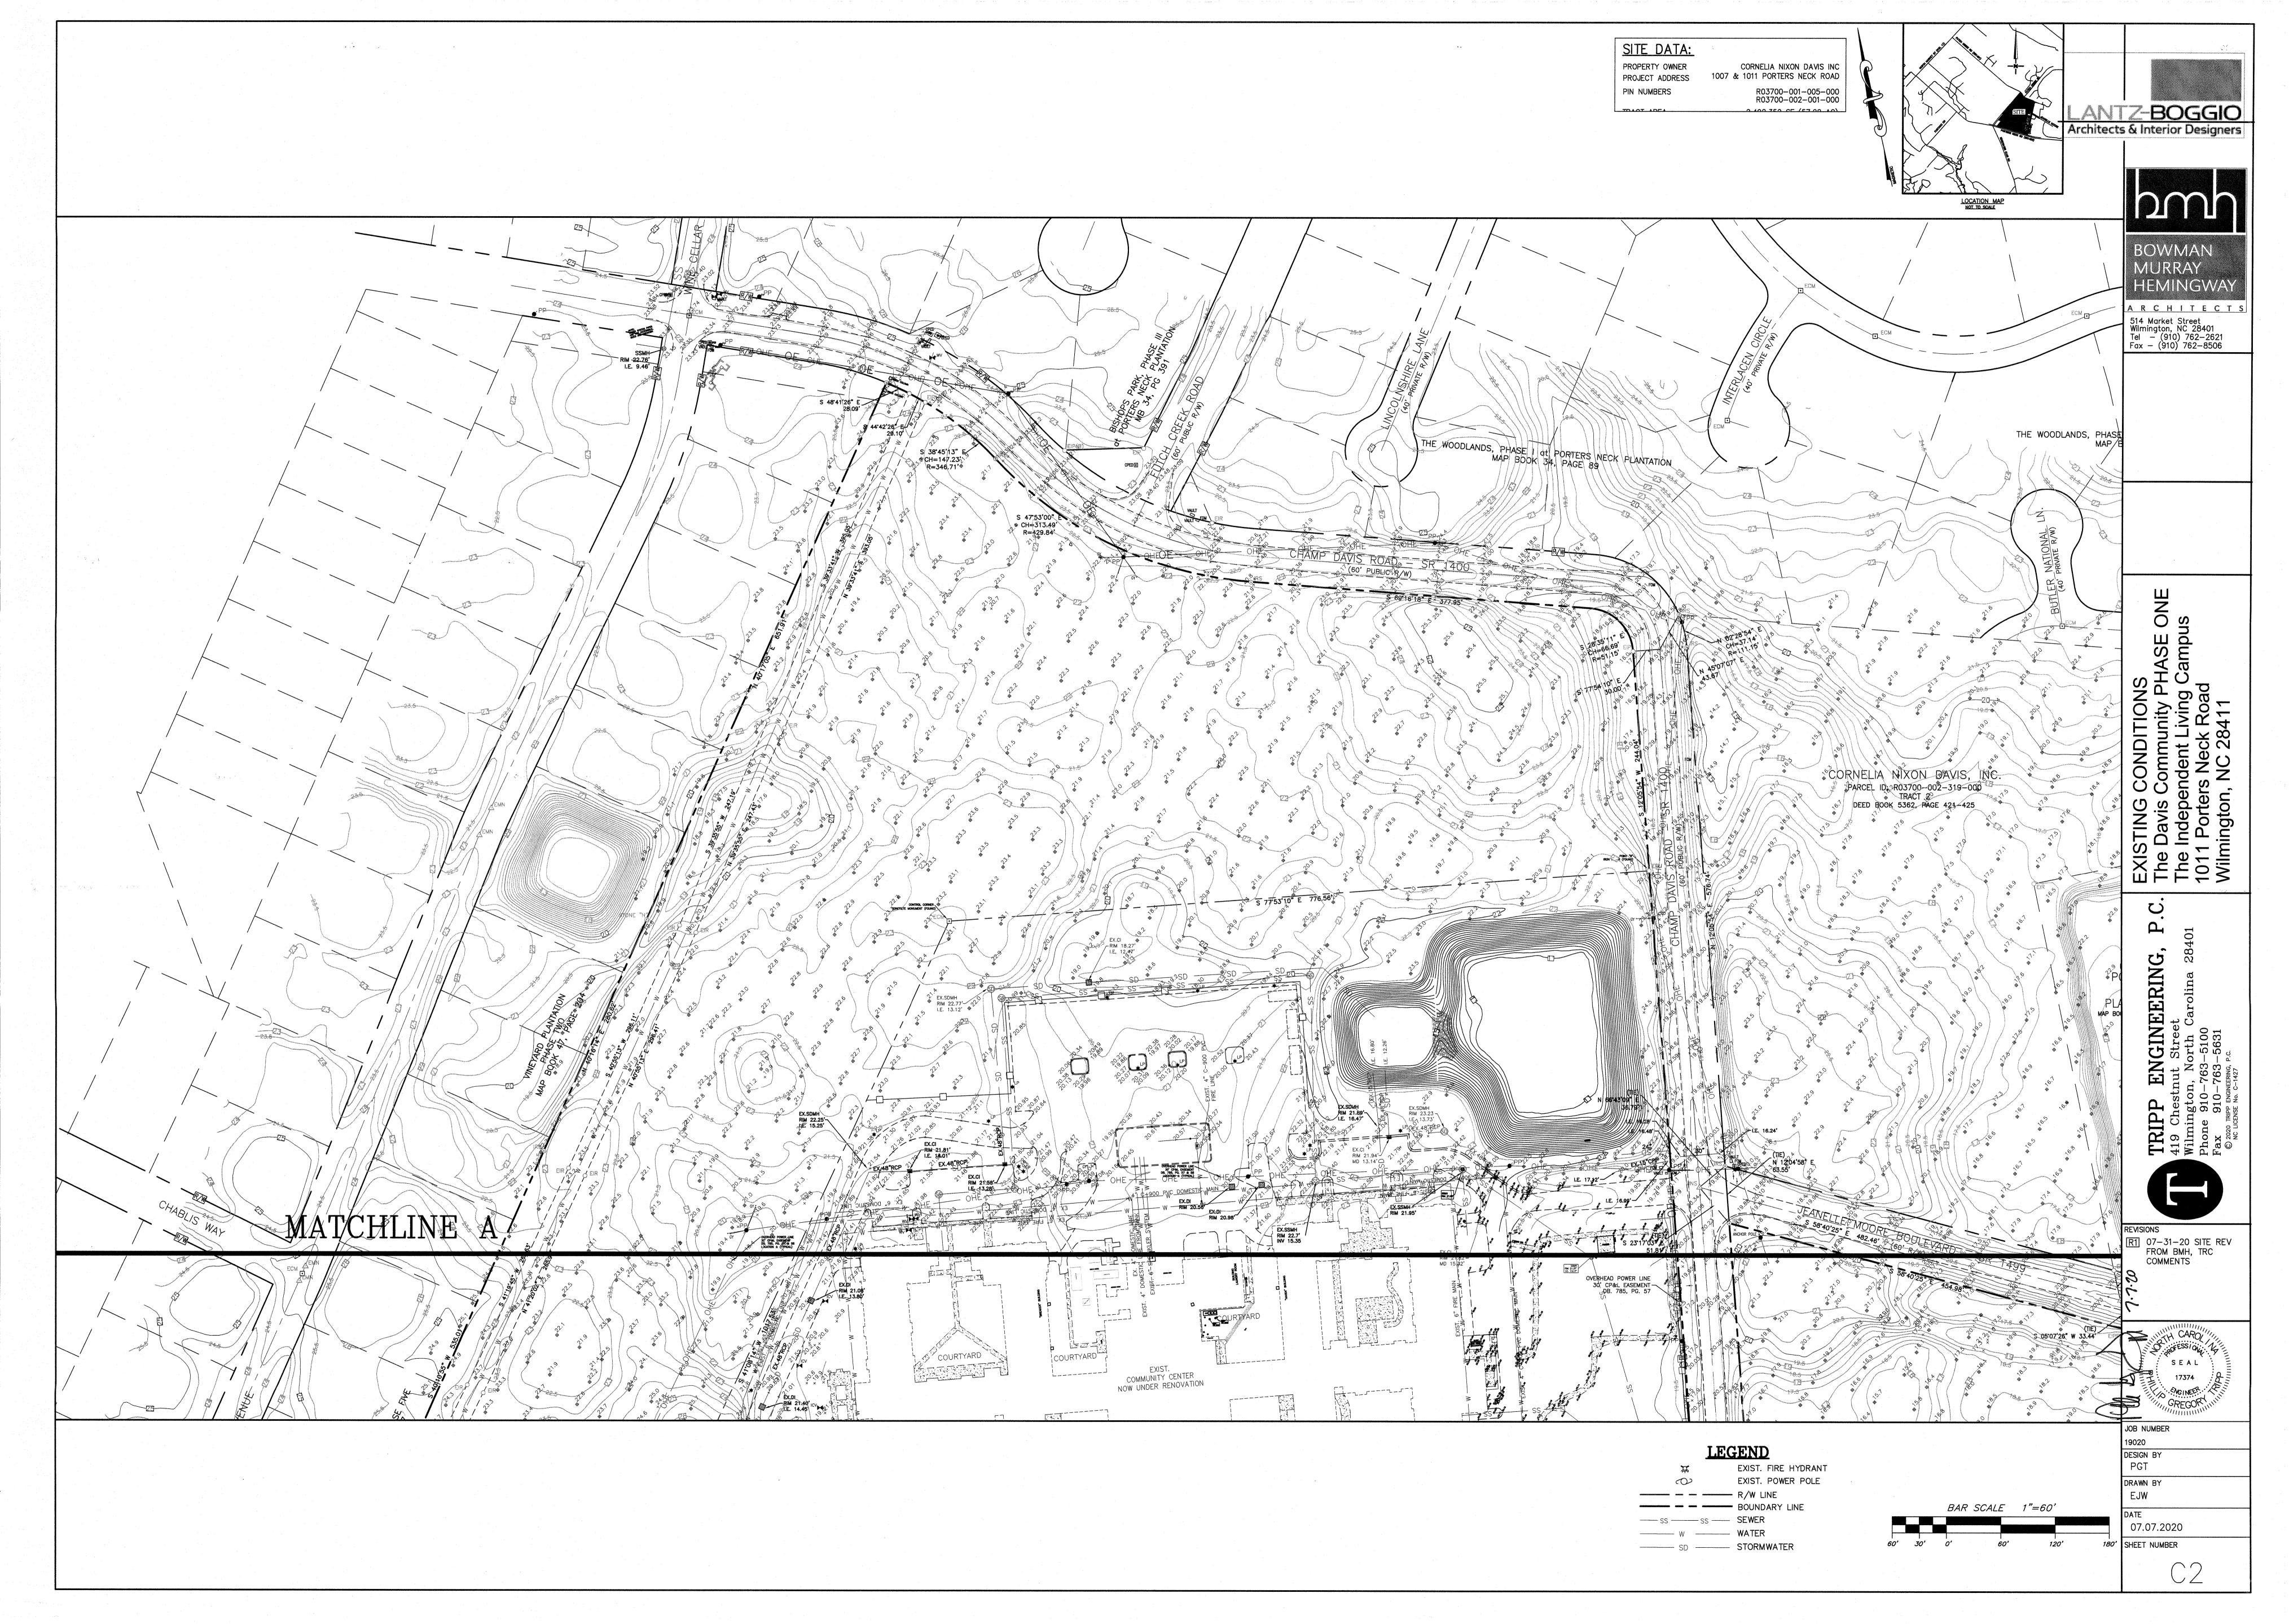
PORTERS NECK ROAD - SR 1491 (60' PUBLIC R/W)





R1 07-31-20 SITE REV FROM BMH, TRC COMMENTS 72 08-26-20 TRC, SW COMMENTS R3 09-10-20 REMOVE POND CLEARING AREA

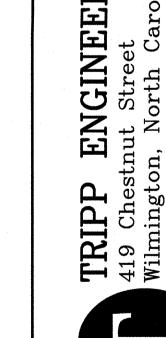
EJW 07.07.2020






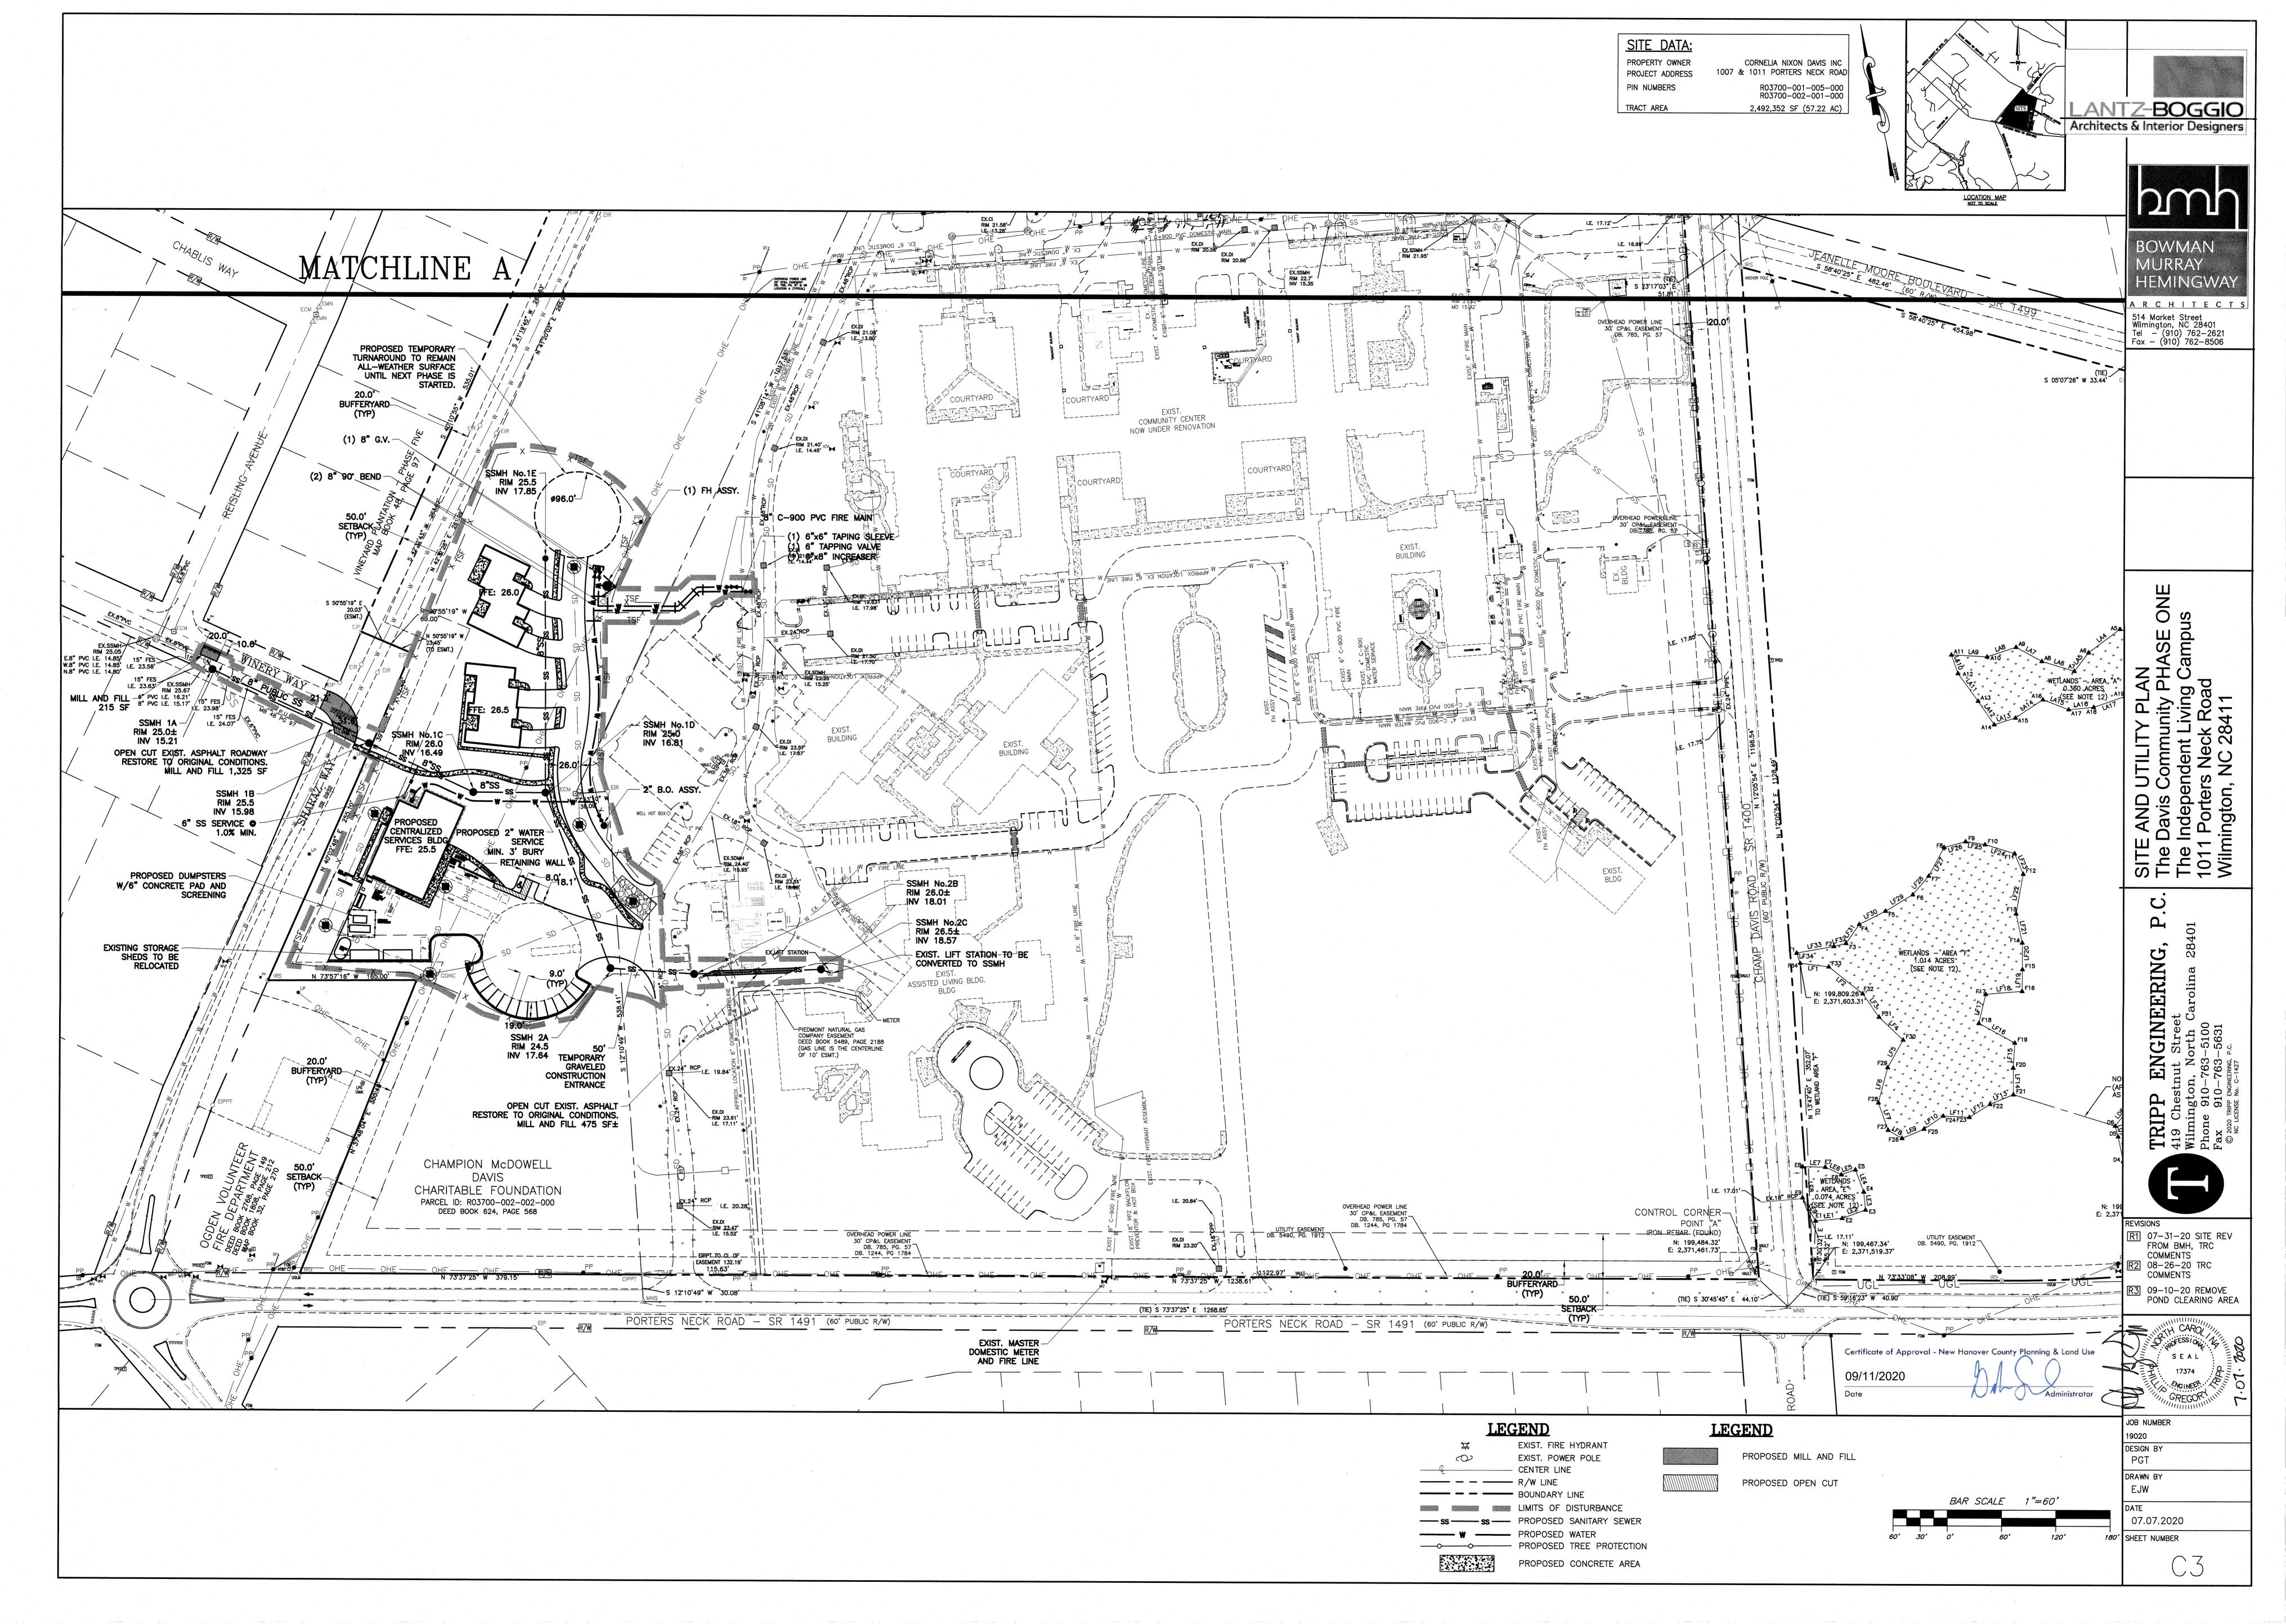

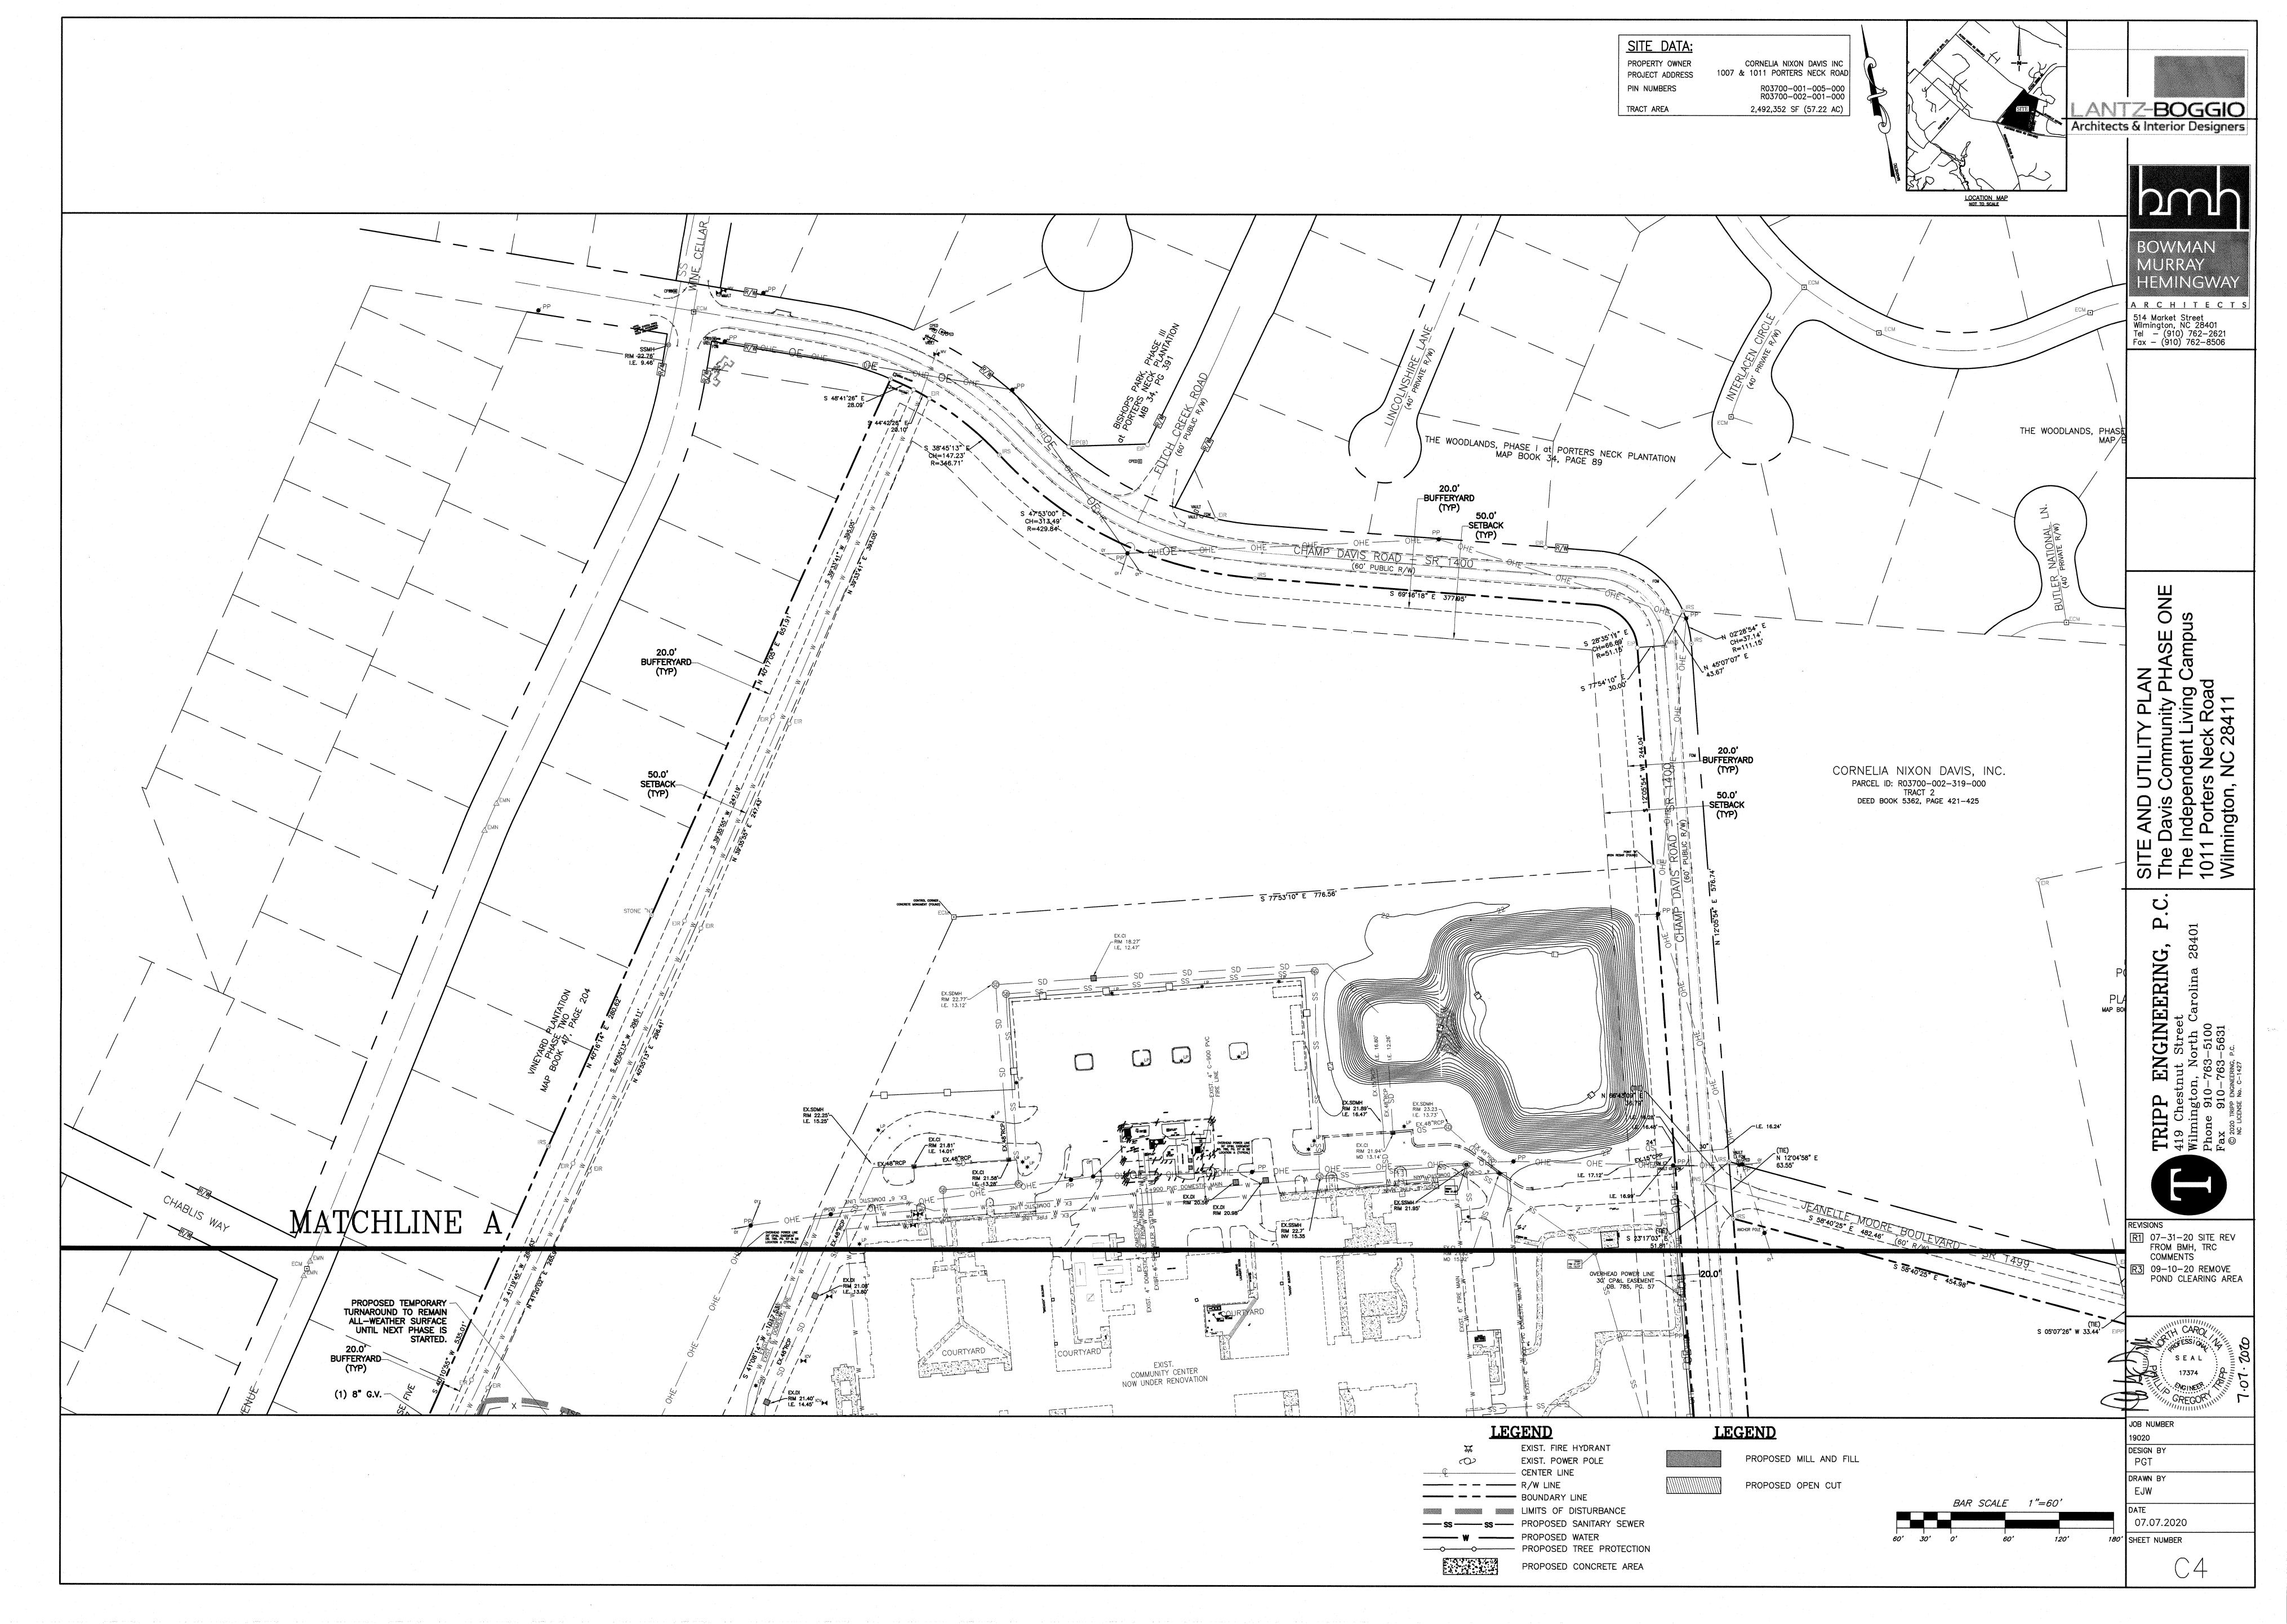

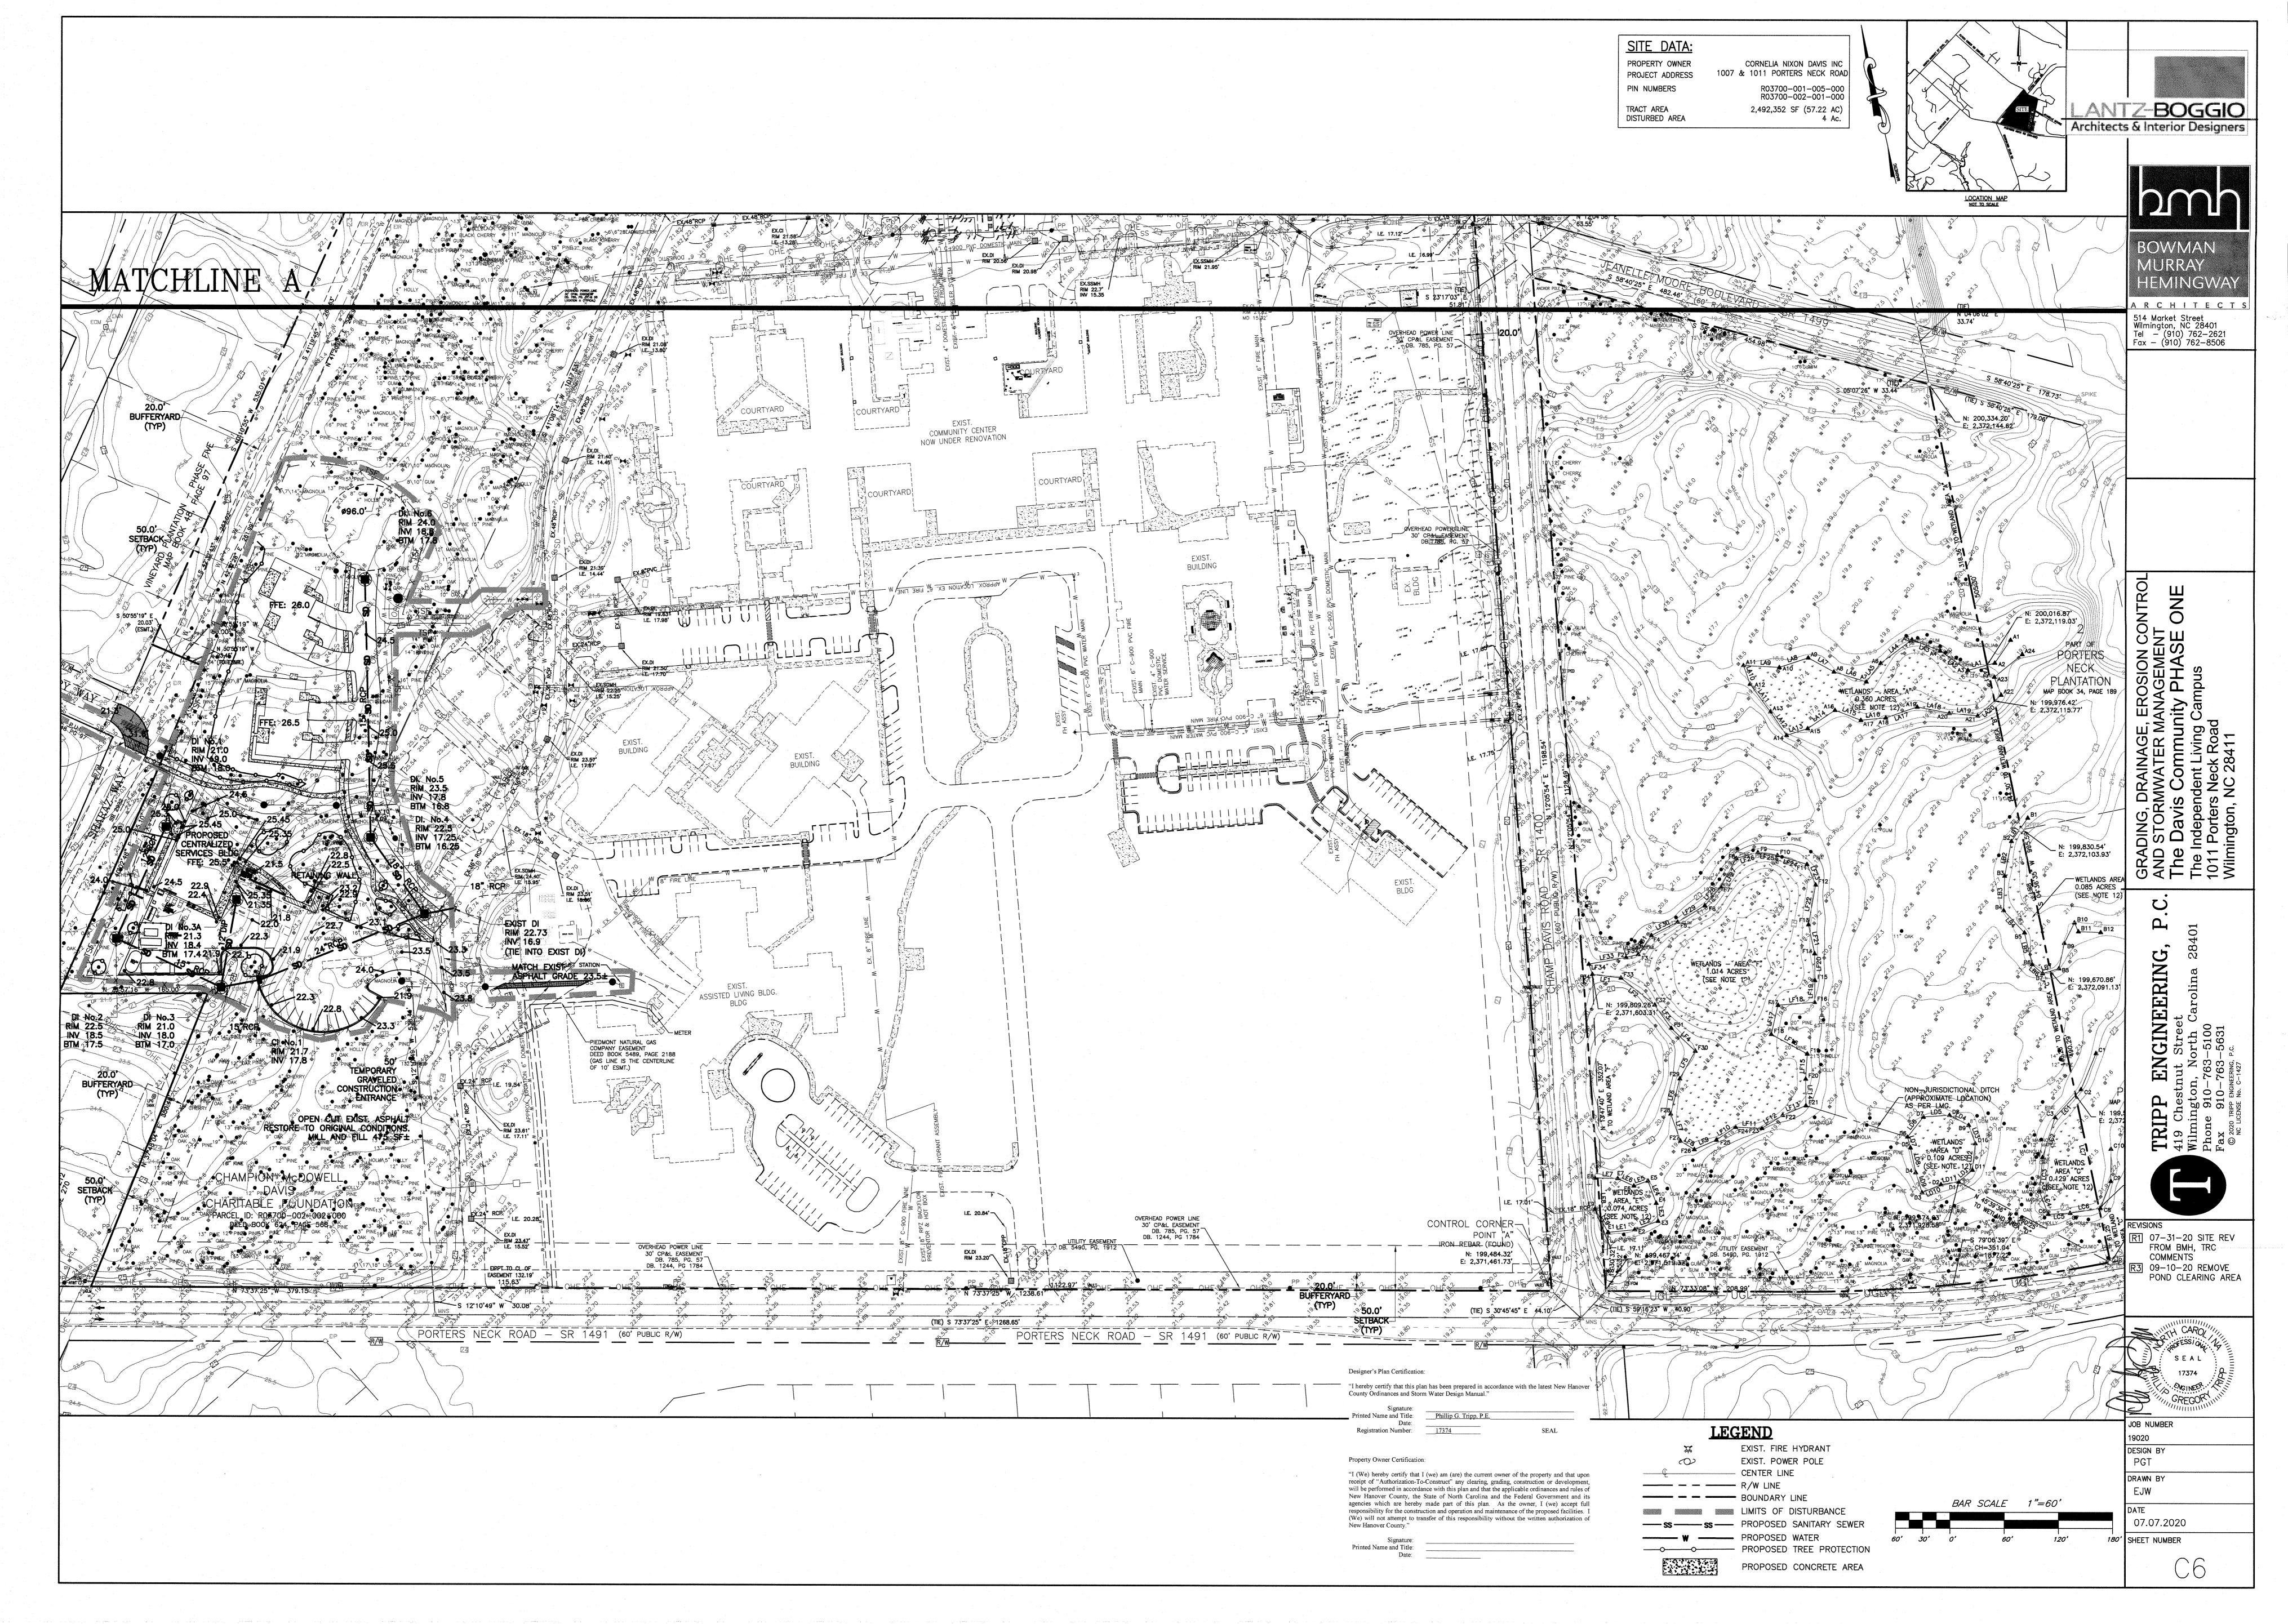

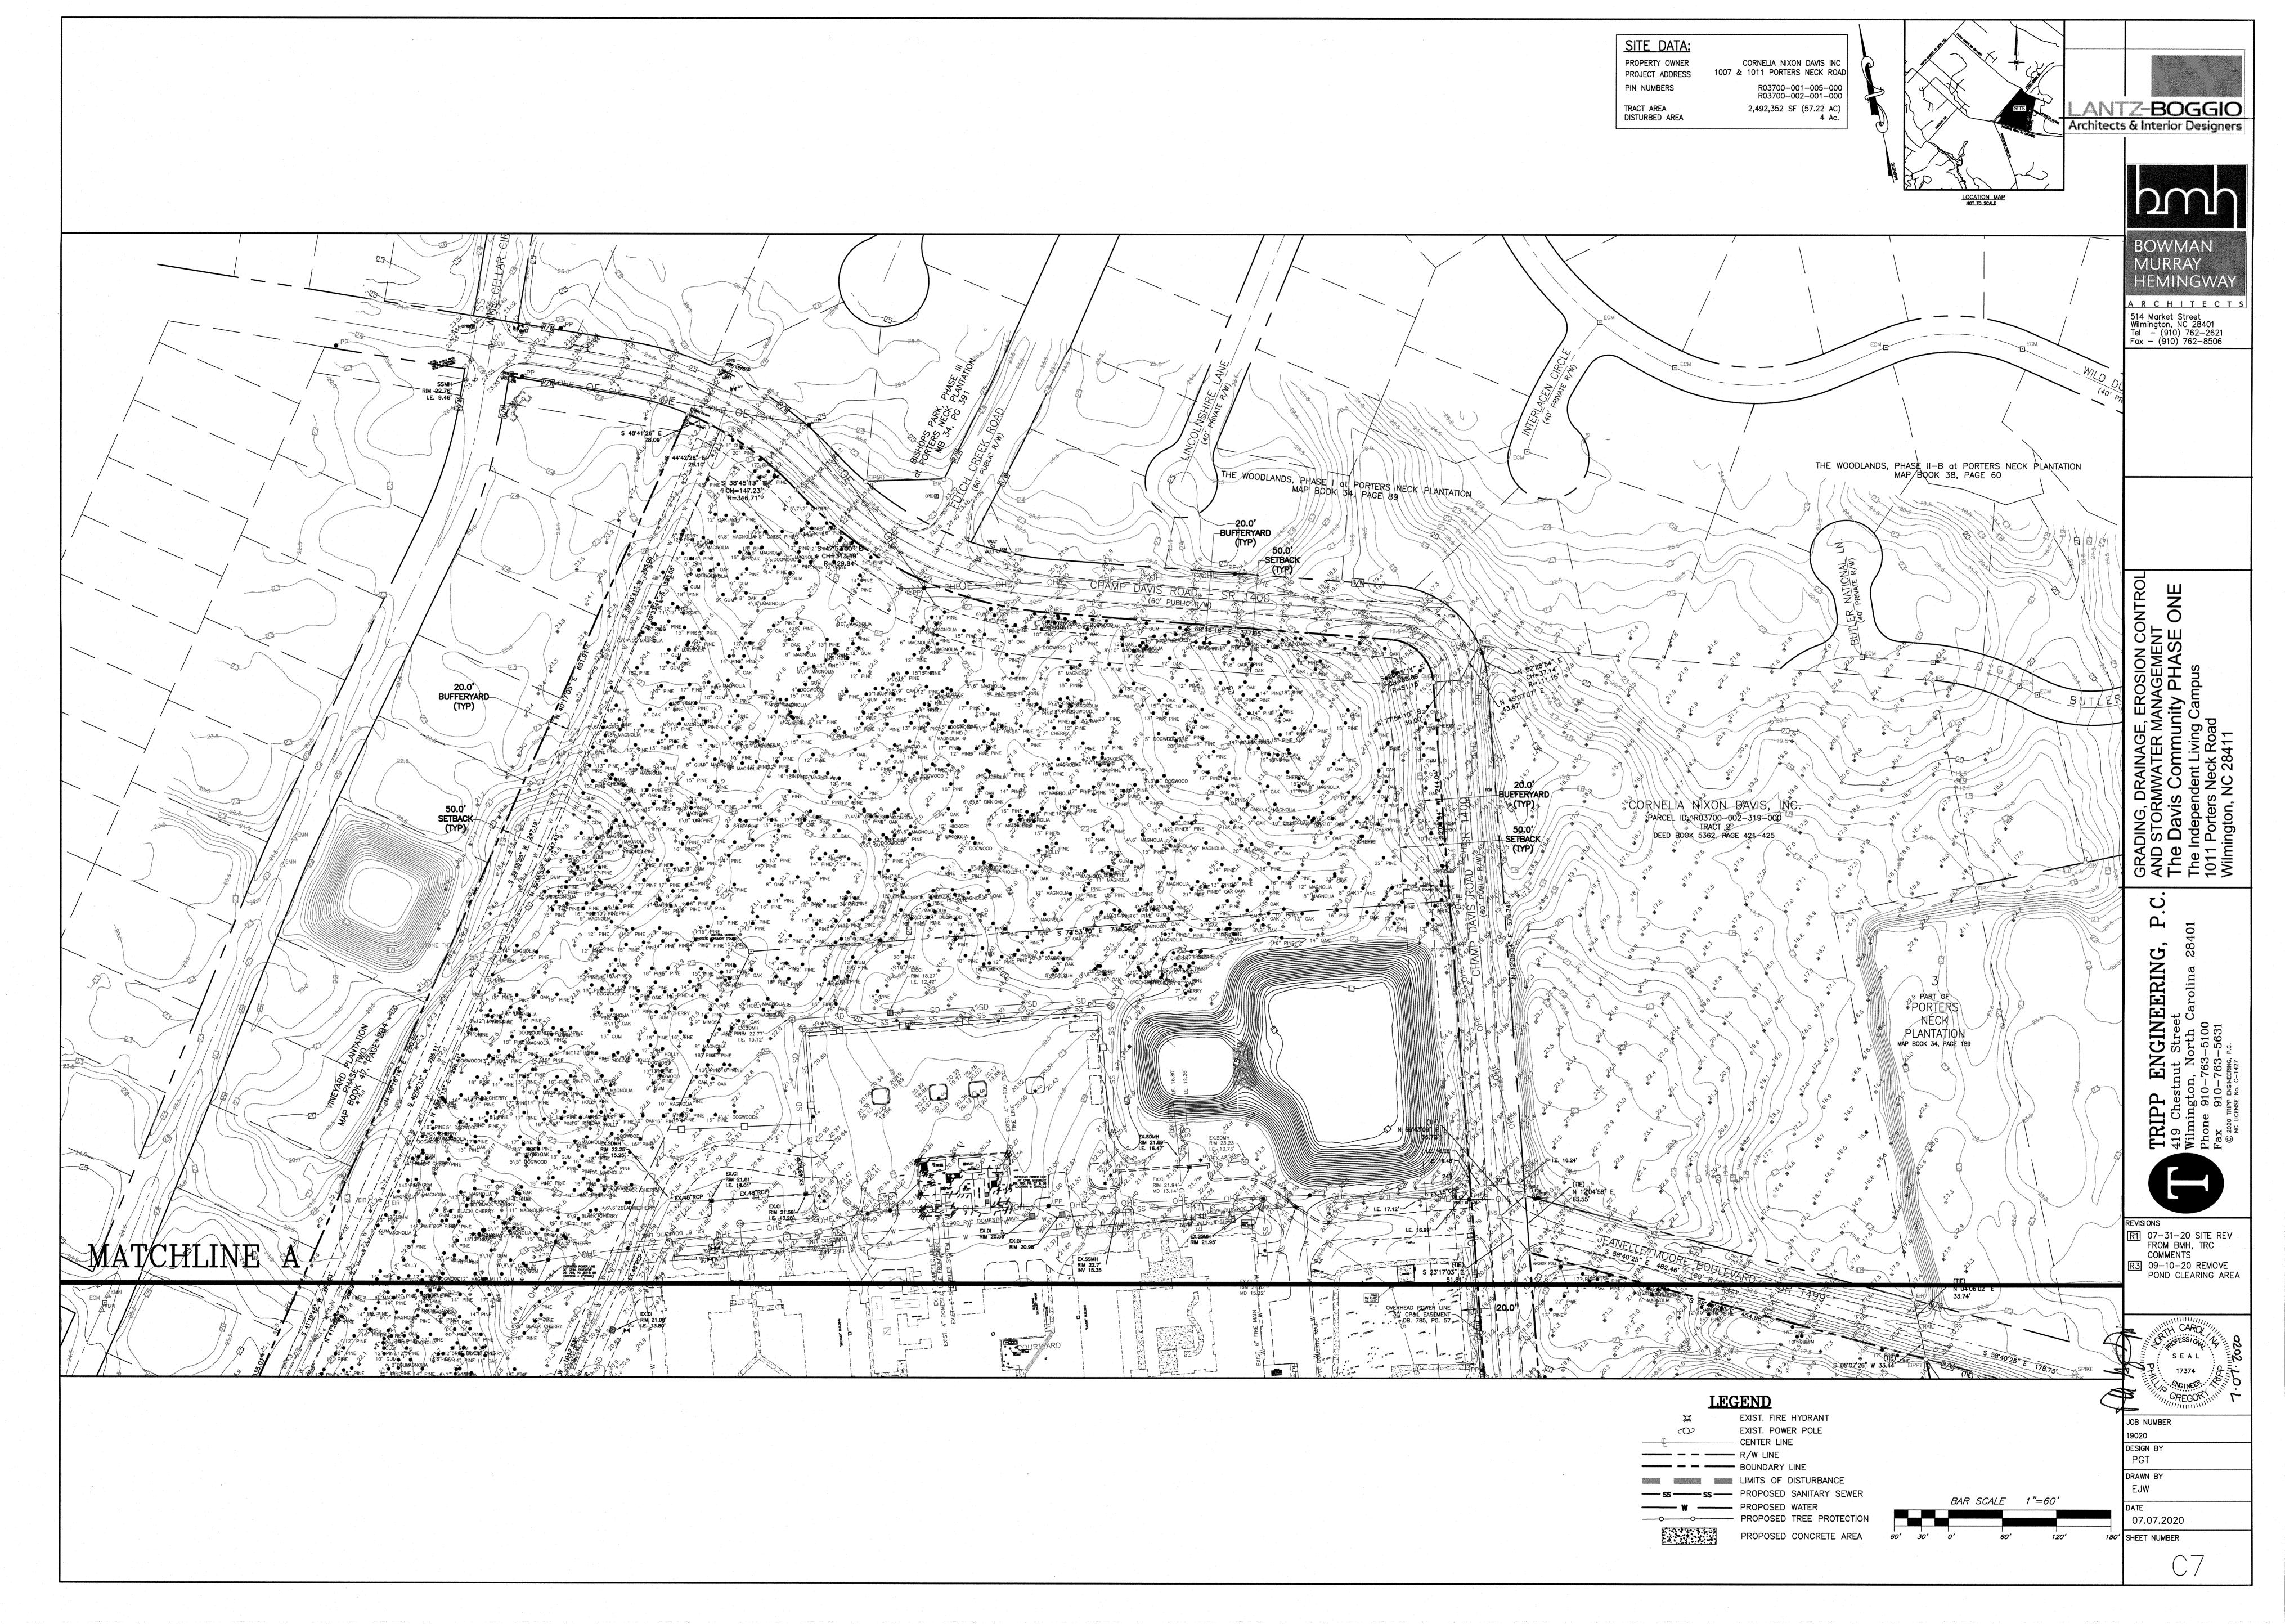

HEMINGWA` RCHITECT

Tel - (910) 762-2621 Fax - (910) 762-8506

committee of the commit

SEAL

OB NUMBER 19020 DESIGN BY PGT

DRAWN BY

EJW

SHEET NUMBER

THE CONTRACTOR SHALL VISIT THE SITE AND BECOME FAMILIARIZED WITH EXISTING

CLEARING: CONTRACTOR SHALL REMOVE ALL TREES AND VEGETATION WITHIN LIMITS

GRUBBING AND STRIPPING: CONTRACTOR SHALL RAKE AND REMOVE ROOTS, STUMPS,

VEGETATION, DEBRIS, EXISTING STRUCTURES ABOVE AND BELOW GRADE, ORGANIC

MATERIAL OR ANY OTHER UNSUITABLE MATERIAL WITHIN LIMITS OF CONSTRUCTION.

MUCKING: CONTRACTOR SHALL COORDINATE WITH OWNER AND THEIR GEOTECHNICAL

DISPOSAL: CLEARED, GRUBBED, STRIPPED OR OTHER WASTE MATERIAL SHALL BE

EARTHWORK CONDITION. THE CONTRACTOR SHALL BE RESPONSIBLE FOR CUT AND FILL QUANTITIES AND COMPLETE INSTALLATION TO SPECIFIED GRADES.

THE CONTRACTOR SHALL FURNISH SUITABLE BORROW MATERIAL FROM AN OFF-SITE

THE CONTRACTOR IS RESPONSIBLE FOR THE LOCATION AND PROTECTION OF ALL EXISTING UTILITIES DURING CONSTRUCTION. BEFORE COMMENCING ANY EXCAVATIONS

IN OR ALONG ROADWAYS OR RIGHT-OF-WAYS, PUBLIC AREAS OR IN PRIVATE

THE CONTRACTOR SHALL BE RESPONSIBLE TO COORDINATE DISCONNECTION/

RECONNECTION AND/OR THE RELOCATION OF ALL EXISTING UTILITIES WITH

EASEMENTS, THE CONTRACTOR SHALL NOTIFY ALL APPROPRIATE PERSONNEL OF

THE CONTRACTOR SHALL NOTE THAT THE GRADING PLAN MAY NOT REPRESENT A BALANCED

THEIR INTENT TO EXCAVATE, IN WRITING, NOT LESS THAN 10 DAYS PRIOR TO EXCAVATING.

EXISTING SURVEYING PERFORMED BY DANFORD AND ASSOCIATES AND SUPPLIED BY THE OWNER.

THE CONTRACTOR SHALL FIELD VERIFY ALL DIMENSIONS AT THE SITE. FURTHERMORE

5. ALL SERVICE CONNECTIONS SHALL BE INSTALLED TO MEET ALL LOCAL AND STATE CODES.

METERS, TAPS, MATERIALS, WORKMANSHIP AND ALL FEES SHALL BE THE RESPONSIBILITY

ALL PAVEMENT, BASE AND SUBGRADE SHALL CONFORM TO NCDOT STANDARDS INCLUDING WORKMANSHIP, MATERIALS AND EQUIPMENT. APPROPRIATE BARRICADES, SIGNS, LIGHTS

OR OTHER TRAFFIC CONTROL DEVICES SHALL BE PROVIDED IN ACCORDANCE WITH NCDOT

ANY DISCREPANCIES TO THE ENGINEER PRIOR TO INSTALLATION. ALL AREAS SHALL BE

18. CONCRETE STORM DRAINAGE PIPE SHALL BE CLASS III WITH RUBBER GASKETED JOINTS

19. USE WHITE LANE MARKING PAINT FOR ALL PAVEMENT MARKINGS. PAINT SHALL BE A

NON BLEEDING. REFLECTIVE MATERIAL MAY BE ADDED AT OWNER'S OPTION FOR

DUCTILE IRON SHALL BE CLASS 50.
CONCRETE FOR WALKS, CURBS AND DRIVES SHALL HAVE A MINIMUM COMPRESSIVE

22. FIELD TESTING SHALL BE DONE BY AN INDEPENDENT TESTING LABORATORY PAID FOR

BY THE OWNER. FURTHER TESTING REQUIRED DUE TO A FAILED TEST WILL BE

\_\_\_\_\_ FOR ADDITIONAL REQUIREMENTS.

NO CUT SLOPE OR FILL SLOPE SHALL EXCEED A RISE OR FALL OF ONE FOOT FOR

INSTALL PRIMARY EROSION CONTROL MEASURES BEFORE BEGINNING CONSTRUCTION INCLUDING

INSTALL ALL SECONDARY EROSION CONTROL MEASURES AS SOON AS POSSIBLE AFTER BEGINNING

SILT FENCE AND INLET PROTECTION ARE TO BE CLEANED WHEN 0.5 FEET OF SEDIMENT HAVE

ACCUMULATED IN FRONT OF THE DEVICE OR WHEN THEY LEAK OR FAIL. SEDIMENT TRAPS ARE

IF APPLICABLE, CONSTRUCT PROPOSED RETENTION POND TO ACT AS A SEDIMENT BASIN

. A 4" LAYER OF TOPSOIL SHALL BE APPLIED TO ALL NEW AREAS TO BE GRASSED. MAINTAIN ALL EROSION CONTROL MEASURES UNTIL PROJECT IS COMPLETE.

MORE STRINGENT MEASURES MAY BE REQUIRED TO HALT EROSION IF THOSE ON THIS

ALL EROSION AND SEDIMENT CONTROL PRACTICES WILL BE CHECKED FOR STABILITY AND OPERATION FOLLOWING EVERY RUNOFF-PRODUCING RAINFALL, BUT IN NO CASE, LESS THAN

ONCE EVERY WEEK AND WITHIN 24 HOURS OF EVERY HALF INCH RAINFALL.

ONTO THE CONSTRUCTION ENTRANCE OR ROADWAYS.

DNCE A WEEK AND AFTER EVERY RAIN EVENT.

ACTIVITY ASSOCIATED WITH A SWALE.

DURING CONSTRUCTION. REMOVE ACCUMULATION OF SILT AS REQUIRED TO ALLOW PROPER FUNCTIONING. RESTORE POND TO DESIGN LEVELS AT THE COMPLETION OF CONSTRUCTION. IF APPLICABLE, INSTALL DROP INLETS WITH INLET PROTECTION TO ACT AS SILT TRAPS

DURING CONSTRUCTION. REMOVE ACCUMULATED SILT AS NEEDED TO PREVENT SILT FROM

REMOVE ALL TEMPORARY EROSION CONTROL MEASURES UPON COMPLETION OF CONSTRUCTION. ALL PERMANENT MEASURES SHALL BE WELL ESTABLISHED PRIOR TO PROJECT COMPLETION.

ALL POINTS OF EGRESS WILL HAVE CONSTRUCTION ENTRANCES THAT WILL BE PERIODICALLY

SEDIMENT WILL BE REMOVED FROM HARDWARE CLOTH AND GRAVEL INLET PROTECTION, BLOCK

AND GRAVEL INLET, ROCK DOUGHNUT INLET PROTECTION AND ROCK PIPE INLET PROTECTION WHEN THE DESIGNED STORAGE CAPACITY HAS BEEN HALF FILLED WITH SEDIMENT. ROCK WIL

4. DIVERSION DITCHES WILL BE CLEANED OUT IMMEDIATELY TO REMOVE SEDIMENT OR OBSTRUCTIONS

FROM THE FLOW AREA. THE DIVERSION RIDGES WILL ALSO BE REPAIRED. SWALES MUST BE

TEMPORARILY STABILIZED WITHIN 21 CALENDAR DAYS OF CEASE OF ANY PHASE OF

5. SEDIMENT WILL BE REMOVED FROM BEHIND THE SEDIMENT FENCE WHEN IT BECOMES HALF FILLED

STRENGTH FABRIC AND WIRE BACKING ARE USED. IF ROCK FILTERS ARE

THE SEDIMENT FENCE WILL BE REPAIRED AS NECESSARY TO MAINTAIN A BARRIER. STAKES MUST

FABRIC. WITHOUT WIRE BACKING. STAKE SPACING WILL BE 8 FEET MAX. WHEN STANDARD

OR REPLACED IF IT BECOMES HALF FULL OF SEDIMENT, NO LONGER DRAINS AS DESIGNED

BE STEEL. STAKE SPACING WILL BE 6 FEET MAX. WITH THE USE OF EXTRA STRENGTH

DESIGNED AT LOW POINTS IN THE IN THE SEDIMENT FENCE THE ROCK WILL BE REPAIRE

SEDIMENT WILL BE REMOVED FROM SEDIMENT TRAPS WHEN THE DESIGNED STORAGE CAPACITY HAS

BEEN HALF FILLED WITH SEDIMENT. THE ROCK WILL BE CLEANED OR REPLACED WHEN

THE SEDIMENT POOL NO LONGER DRAINS OR WHEN THE ROCK IS DISLODGED. BAFFLES WILL BE REPAIRED OR REPLACED IF THEY COLLAPSE. TEAR, DECOMPOSE OR BECOME INEFFECTIVE. THEY WILL BE REPLACED PROMPTLY. SEDIMENT WILL BE REMOVED WHEN

DEPOSITS REACH HALF THE HEIGHT OF THE 1ST BAFFLE. FLOATING SKIMMERS WILL BE

SEDIMENT WILL BE REMOVED FROM THE SEDIMENT BASIN WHEN THE DESIGN STORAGE CAPACITY HAS

POOL NO LONGER DRAINS OR IF THE ROCK IS DISLODGED. BAFFLES WILL BE REPAIRED OR

REPLACED IF THEY TEAR, DECOMPOSE OR BECOME INEFFECTIVE. THEY WILL BE REPLACED

PROMPTLY. SEDIMENT WILL BE REMOVED FROM BAFFLES WHEN DEPOSITS REACH HALF

3. ALL SEEDED AREAS WILL BE FERTILIZED, RESEEDED AS NECESSARY, AND MULCHED ACCORDING

TO SPECIFICATIONS IN THE VEGETATIVE PLAN TO MAINTAIN A VIGOROUS, DENSE

9. FLOCCULATES WILL BE USED TO ADDRESS TURBIDITY ISSUES. THE PUMPS, TANKS, HOSES AND

INJECTION SYSTEMS WILL BE CHECKED FOR PROBLEMS OR TURBID DISCHARGES DAILY.

OTHER AREAS WILL BE STABILIZED WITHIN 15 WORKING DAYS.

STORM DRAINS AND STREAMS UNLESS NO REASONABLE ALTERNATIVES AVAILABLE.

<u>BUILDING WASTE HANDLING</u> 1. NO PAINT OR LIQUID WASTES IN STREAMS OR STORM DRAINS.

2. SAME RAIN GAUGE AND INSPECTIONS AFTER 0.5" RAIN EVENT.

. INSPECTIONS ARE ONLY REQUIRED DURING "NORMAL BUSINESS HOURS".

5. RECORDS MUST BE KEPT FOR 3 YEARS AND AVAILABLE UPON REQUEST.

6. ELECTRONICALLY AVAILABLE RECORDS MAY BE SUBSTITUTED UNDER CERTAIN CONDITIONS.

. SAME WEEKLY INSPECTION REQUIREMENTS.

2. USE ONLY DWQ-APPROVED FLOCCULENTS.

STORMWATER PERMIT NCG010000.

EXEMPTION IS APPROVED.

THE HEIGHT OF THE 1ST BAFFLE. FLOATING SKIMMERS WILL BE INSPECTED WEEKLY AND WILL BE KEPT CLEAN.

VEGETATIVE COVER. ALL SLOPES WILL BE STABILIZED WITHIN 21 CALENDAR DAYS. ALL

2. DEDICATED AREAS FOR DEMOLITION, CONSTRUCTION AND OTHER WASTES MUST BE LOCATED 50' FROM

3. EARTHEN-MATERIALS STOCKPILES MUST BE LOCATED 50' FROM STORM DRAINS AND STREAMS UNLESS

4. CONCRETE MATERIALS MUST BE CONTROLLED TO AVOID CONTACT WITH SURFACE WATERS, WETLANDS OR

INSPECTION REPORTS MUST BE AVAILABLE ON-SITE DURING BUSINESS HOURS UNLESS A SITE-SPECIFIC

<u>SEDIMENT BASINS</u>
1. OUTLET STRUCTURES MUST WITHDRAW FROM BASIN SURFACE UNLESS DRAINAGE AREA IS LESS THAN 1

NPDES—SPECIFIC PLAN SHEETS NOTES

1. THIS PAGE IS SUBMITTED TO COMPLY WITH NPDES GENERAL STORMWATER PERMIT NCG010000.

2. THIS PAGE CAN BE APPROVED BY THE COUNTY PURSUANT TO NPDES GENERAL STORMWATER PERMIT

3. THIS PAGE OF THE APPROVED PLANS IS ENFORCEABLE EXCLUSIVELY PURSUANT TO NPDES GENERAL

4. THE COUNTY IS NOT AUTHORIZED TO ENFORCE THIS PAGE OF THE PLANS AND IT IS NOT A PART OF THE APPROVED PLANS FOR THE PURPOSES OF ENFORCEMENT ACTION UNDER THE COUNTY CODE.

BEEN HALF FILLED WITH SEDIMENT. ROCK WILL BE CLEANED OR REPLACED WHEN THE SEDIMENT

BE CLEANED OR REPLACED WHEN THE SEDIMENT POOL NO LONGER DRAINS AS DESIGNED

EBRIS WILL BE REMOVED FROM THE ROCK AND HARDWARE CLOTH TO ALLOW PROPER

DRAINAGE. SILT SACKS WILL BE EMPTIED ONCE A WEEK AND AFTER EVERY RAIN EVENT SEDIMENT WILL BE REMOVED FROM AROUND BEAVER DAMS, DANDY SACKS AND SOCKS

TOP-DRESSED WITH AN ADDITIONAL 2 INCHES OF #4 STONE TO MAINTAIN PROPER DEPTH. THEY WILL BE MAINTAINED IN A CONDITION TO PREVENT MUD OR SEDIMENT FROM LEAVING THE SITE. IMMEDIATELY REMOVE OBJECTIONABLE MATERIAL SPILLED, WASHED OR TRACKED

INSTALL STORM DRAIN PIPING AND INLETS WITH INLET PROTECTION, TO COLLECT RUNOFF AND DIVERT TO

BUT NOT LIMITED TO GRAVELED CONSTRUCTION ENTRANCE, SILT FENCE, CHECK DAMS, ET

CHLORINATED RUBBER ALKYD, FS TT-P-115, TYPE III, FACTORY MIXED, QUICK DRYING,

AND INSTALLED IN ACCORDANCE WITH MANUFACTURER'S REQUIREMENTS.

ALL AREAS SHALL BE GRADED FOR POSITIVE DRAINAGE. THE CONTRACTOR SHALL REPORT

. THE CONTRACTOR SHALL PROVIDE ANY AND ALL LAYOUT REQUIRED TO CONSTRUCT

. ALL PVC UTILITY MAINS SHALL BE INSTALLED WITH A MINIMUM OF 36" COVER

OF THE CONTRACTOR AND SHALL COMPLY WITH ALL REQUIREMENTS.

THE CONTRACTOR SHALL REPORT ALL DISCREPANCIES OR QUESTIONS TO THE ENGINEER

REMOVED FROM SITE AND DISPOSED OF IN A PROPERLY PERMITTED FACILITY.

CONDITIONS BOTH ON AND IMMEDIATELY ADJACENT TO THE SITE

OF CONSTRUCTION UNLESS OTHERWISE DESIGNATED TO REMAIN.

REPRESENTATIVE TO COORDINATE REMOVAL OF ANY SOFT AREAS.

PROPERLY PERMITTED FACILITY AS REQUIRED.

HIS WORK UNLESS OTHERWISE DIRECTED BY OWNER.

TO MAINTAIN SAFETY AND TWO WAY TRAFFIC

PAID FOR BY THE CONTRACTOR.

23. SEE GEOTECHNICAL REPORT NO.

CONSTRUCTION SEQUENCE

SLOPED TO DRAIN AWAY FROM BUILDINGS AT ALL TIMES.

STRENGTH OF 3000 PSI @ 28 DAYS - AIR ENTRAINED.

EVERY RUN OF 3 FEET (1 VERTICAL TO 3 HORIZONTAL).

CLEANED OUT AS STATED OR WHEN HALF FULL

ENTERING STORM DRAIN PIPING.

MAINTENANCE PLAN

INCLUDING SIDE SLOPES DURING AND AFTER CONSTRUCTION.

SEDIMENT BASIN. (DETENTION POND TO ACT AS SEDIMENT BASIN)

ALL EROSION CONTROL MEASURES TO BE INSPECTED AFTER EACH RAIN.

APPROPRIATE PERSÓNNEL.

PRIOR TO INSTALLATION.

AT FINAL GRADE.

FILL AND COMPACTION SHOULD COMPLY WITH GEOTECHNICAL REPORT.

514 Market Street Wilmington, NC 28401

07.07.2020

GROUND STABILIZATION AND MATERIALS HANDLING PRACTICES FOR COMPLIANCE WITH mplementing the details and specifications on this plan sheet will result in the construction Provide drip pans under any stored equipment. activity being considered compliant with the Ground Stabilization and Materials Handling sections of the NCG01 Construction General Permit (Sections E and F. respectively). The

delegated authority having jurisdiction. All details and specifications shown on this sheet

may not apply depending on site conditions and the delegated authority having jurisdiction.

permittee shall comply with the Erosion and Sediment Control plan approved by the

STABILIZATION TIMEFRAMES (Effective Aug. 3, 2011)							
	SITE AREA DESCRIPTION	STABILIZATION	TIMEFRAME EXCEPTIONS				
27.5	Perimeter dikes, swales, ditches, slopes	7 days	None				
	High Quality Water (HQW) Zones	7 days	None				
	Slopes steeper than 3:1	7 days	If slopes are 10' or less in length and ar not steeper than 2:1, 14 days are allowe				
	Slopes 3:1 or flatter	14 days	7 days for slopes greater than 50' in len				
	All other areas with slopes flatter than 4:1	14 days	None, except for perimeters and HQW 2				

\*-For Falls Lake watershed, in disturbed areas where grading activities are incomplete, provide temporary groundcover no later than seven (7) days for slopes steeper than 3:1; ten (10) days for slopes equal to or flatter than 3:1; fourteen (14) days for areas with no slope.

GROUND STABILIZATION SPECIFICATION Stabilize the ground sufficiently so that rain will not dislodge the soil. Use one of the

Temporary Stabilization Temporary grass seed covered with straw or
 Permanent grass seed covered with straw or other mulches and tackifiers Geotextile fabrics such as permanent soil Hydroseeding Rolled erosion control products with or without reinforcement matting

Plastic sheeting

 Appropriately applied straw or other mulch
 Shrubs or other permanent plantings covered Uniform and evenly distributed ground cove sufficient to restrain erosion Structural methods such as concrete, asphalt or retaining walls

POLYACRYLAMIDES (PAMS) AND FLOCCULANT

or surrounded by secondary containment structures.

construction, selecting from the NC DWR List of Approved PAMS/Flocculants. Apply flocculants at or before the inlets to Erosion and Sediment Control Measures. Apply flocculants at the concentrations specified in the NC DWR List of Approved PAMS/Flocculants and in accordance with the manufacturer's instructions. Provide ponding area for containment of treated Stormwater before discharging

Store flocculants in leak-proof containers that are kept under storm-resistant cover

SELF-INSPECTION, RECORDKEEPING AND REPORTING

Self-inspections are required during normal business hours in accordance with the table

below. When adverse weather or site conditions would cause the safety of the inspection

personnel to be in jeopardy, the inspection may be delayed until the next business day on

which it is safe to perform the inspection. In addition, when a storm event of greater than

1.0 inch occurs outside of normal business hours, the self-inspection shall be performed

Daily rainfall amounts.

approved by the Division.

days and within | 3. Name of the person performing the inspection

Date of actions taken.

days and within 3. Name of the person performing the inspection.

Date of actions taken.

has left the site limits,

At least once If the stream or wetland has increased visible

NOTE: The rain inspection resets the required 7 calendar day inspection requirement.

per 7 calendar record of the following shall be made:

rain event > 1.0 | 2. Date of actions taken, and

24 hours of a 4. Indication of whether the measures were operating

6. Corrective actions taken, and

2. Date and time of the inspection,

24 hours of a 4. Evidence of indicators of stormwater pollution such as

days and within 1. Actions taken to clean up or stabilize the sediment that

per 7 calendar | sedimentation or a stream has visible increased turbidit

(2)(a) of this permit of this permit.

days and within from the construction activity, then a record of the

rain event > 1.0 | 1. Evidence and actions taken to reduce sediment

per 7 calendar | 2. Date and time of the inspection.

Identification of the measures inspected

5. Description of maintenance needs for the measure

. Identification of the discharge outfalls inspected,

oil sheen, floating or suspended solids or discoloration.

If visible sedimentation is found outside site limits, then a

3. An explanation as to the actions taken to control future

2. Records of the required reports to the appropriate

Division Regional Office per Part III, Section C, Item

6. Actions taken to correct/prevent sedimentation, and

5. Indication of visible sediment leaving the site.

Inspection records must include [40 CFR 122.41]:

If no daily rain gauge observations are made durin

weekend or holiday periods, and no individual-day rainfall

measurement for those un-attended days (and this will

determine if a site inspection is needed). Days on which no

rainfall occurred shall be recorded as "zero." The

permittee may use another rain-monitoring device

information is available, record the cumulative rai

upon the commencement of the next business day. Any time when inspections were

NORTH CAROLINA 🔊 Environmental Quality

delayed shall be noted in the Inspection Record.

At least once

inch in 24

At least once

per 7 calendar

rain event > 1.0

24 hours of a

offsite (where | 24 hours of a | following shall be made:

linch in 24

inch in 24

rain event > 1.0 | properly.

(1) Rain

gauge

maintained ir

good working

(2) E&SC

discharge

accessible)

(SDOs)

Identify leaks and repair as soon as feasible, or remove leaking equipment from the

Collect all spent fluids, store in separate containers and properly dispose as

Remove leaking vehicles and construction equipment from service until the problem has been corrected. Bring used fuels, lubricants, coolants, hydraulic fluids and other petroleum products to a recycling or disposal center that handles these materials.

hazardous waste (recycle when possible).

ITTER, BUILDING MATERIAL AND LAND CLEARING WASTE Never bury or burn waste. Place litter and debris in approved waste containers. Provide a sufficient number of waste containers on site to manage the quantity of waste produced. Locate waste containers at least 50 feet away from storm drain inlets and surface

waters unless no other alternatives are reasonably available. Locate waste containers on areas that do not receive substantial amounts of runoff from upland areas and does not drain directly to a storm drain, stream or wetland. 5. Cover waste containers at the end of each workday and before storm events. Repair or replace damaged waste containers.

6. Anchor all lightweight items in waste containers during times of high winds. 7. Empty waste containers as needed to prevent overflow. 8. Dispose waste off-site at an approved disposal facility.

on a gravel pad and surround with sand bags.

foot traffic areas.

SECTION B: RECORDKEEPING

(b) A phase of grading has been

(c) Ground cover is located and

installed in accordance with the

(d) The maintenance and repair

requirements for all E&SC Measures

(e) Corrective actions have been

approved E&SC Plan.

have been performed.

taken to E&SC Measures.

2. Additional Documentation

requirement not practical:

upon request. [40 CFR 122.41]

with properly operating unit.

five feet from the toe of stockpile.

Provide stable stone access point when feasible

NCG01 GROUND STABILIZATION AND MATERIALS HANDLING

EARTHEN STOCKPILE MANAGEMENT

PAINT AND OTHER LIQUID WASTE Do not dump paint and other liquid waste into storm drains, streams or wetlands. Locate paint washouts at least 50 feet away from storm drain inlets and surface waters unless no other alternatives are reasonably available.

Contain liquid wastes in a controlled area Containment must be labeled, sized and placed appropriately for the needs of site. Prevent the discharge of soaps, solvents, detergents and other liquid wastes from

offset is not attainable, provide relocation of portable toilet behind silt fence or place

Provide staking or anchoring of portable toilets during periods of high winds or in high

Utilize a licensed sanitary waste hauler to remove leaking portable toilets and replace

Show stockpile locations on plans. Locate earthen-material stockpile areas at leas

and surface waters unless it can be shown no other alternatives are reasonably

50 feet away from storm drain inlets, sediment basins, perimeter sediment controls

Protect stockpile with silt fence installed along toe of slope with a minimum offset of

Stabilize stockpile within the timeframes provided on this sheet and in accordance

SELF-INSPECTION, RECORDKEEPING AND REPORTING

The approved E&SC plan as well as any approved deviation shall be kept on the site. The

The following items pertaining to the E&SC plan shall be documented in the manner

(a) Each E&SC Measure has been installed Initial and date each E&SC Measure on a copy

and does not significantly deviate from the of the approved E&SC Plan or complete, date

locations, dimensions and relative and sign an inspection report that lists each

installation.

In addition to the E&SC Plan documents above, the following items shall be kept on the site

and available for agency inspectors at all times during normal business hours, unless the

Division provides a site-specific exemption based on unique site conditions that make this

(b) Records of inspections made during the previous 30 days. The permittee shall record

the required observations on the Inspection Record Form provided by the Division or a

electronically-available records in lieu of the required paper copies will be allowed if

All data used to complete the Notice of Intent and older inspection records shall be

maintained for a period of three years after project completion and made available

(a) This general permit as well as the certificate of coverage, after it is received.

similar inspection form that includes all the required elements. Use of

shown to provide equal access and utility as the hard-copy records.

approved E&SC plan must be kept up-to-date throughout the coverage under this permit.

**Documentation Requirements** 

Plan. This documentation is required upon

the initial installation of the E&SC Measures or

if the E&SC Measures are modified after initial

Initial and date a copy of the approved E&SC

Plan or complete, date and sign an inspection

Initial and date a copy of the approved E&SC

Plan or complete, date and sign an inspection

report to indicate compliance with approved

Complete, date and sign an inspection report

Initial and date a copy of the approved E&SC

Plan or complete, date and sign an inspection

report to indicate the completion of the

report to indicate completion of the

onstruction phase.

erosion on disturbed soils for temporary or permanent control needs

with the approved plan and any additional requirements. Soil stabilization is defined

as vegetative, physical or chemical coverage techniques that will restrain accelerated

Monitor portable toilets for leaking and properly dispose of any leaked material.

Install portable toilets on level ground, at least 50 feet away from storm drains, streams or wetlands unless there is no alternative reasonably available. If 50 foot

Remove leavings from the washout when at approximately 75% capacity to limit overflow events. Replace the tarp, sand bags or other temporary structural components when no longer functional. When utilizing alternative or proprietary products, follow manufacturer's instructions. 10. At the completion of the concrete work, remove remaining leavings and dispose of in an approved disposal facility. Fill pit, if applicable, and stabilize any disturbance caused by removal of washout.

limits. Post signage on the washout itself to identify this location.

HERBICIDES, PESTICIDES AND RODENTICIDES

2. THE CONCRETE WASHOUT STRUCTURES MAINTAINED WHEN THE LIQUID AND/OR SO 75% OF THE STRUCTURES CAPACITY

3.CONCRETE WASHOUT STRUCTURE NEEDS TO S CLEARY MARKED WITH SIGNAGE NOTING DEVICE.

be pumped out and removed from project.

Do not discharge concrete or cement slurry from the site.

and state solid waste regulations and at an approved facility.

types of temporary concrete washouts provided on this detail.

. Dispose of, or recycle settled, hardened concrete residue in accordance with local

Manage washout from mortar mixers in accordance with the above item and in

alternate method or product is to be used, contact your approval authority for

addition place the mixer and associated materials on impervious barrier and within

Install temporary concrete washouts per local requirements, where applicable. If an

review and approval. If local standard details are not available, use one of the two

Do not use concrete washouts for dewatering or storing defective curb or sidewalk

sections. Stormwater accumulated within the washout may not be pumped into or

Locate washouts at least 50 feet from storm drain inlets and surface waters unless it

can be shown that no other alternatives are reasonably available. At a minimum,

Locate washouts in an easily accessible area, on level ground and install a stone

entrance pad in front of the washout. Additional controls may be required by the

Install at least one sign directing concrete trucks to the washout within the project

install protection of storm drain inlet(s) closest to the washout which could receive

discharged to the storm drain system or receiving surface waters. Liquid waste must

BELOW GRADE WASHOUT STRUCTURE

lot perimeter silt fence.

approving authority.

SECTION C: REPORTING

(b) Oil spills if:

. Occurrences that must be reported

They are 25 gallons or more,

(Ref. 40 CFR 302.4) or G.S. 143-215.85.

(b) Anticipated bypasses and unanticipated bypasses.

. Reporting Timeframes and Other Requirements

Permittees shall report the following occurrences:

a) Visible sediment deposition in a stream or wetland.

Store and apply herbicides, pesticides and rodenticides in accordance with label Store herbicides, pesticides and rodenticides in their original containers with the label, which lists directions for use, ingredients and first aid steps in case of accidental poisoning Do not store herbicides, pesticides and rodenticides in areas where flooding is

CONCRETE NOTING DEVICE (18"X24" MIN.)

ABOVE GRADE WASHOUT STRUCTURE

3.CONGRETE WASHOUT STRUCTURE NEED TO BE CLEARY MARKED WITH SIGNAGE NOTING DEVICE.

possible or where they may spill or leak into wells, stormwater drains, ground water or surface water. If a spill occurs, clean area immediately. 4. Do not stockpile these materials onsite.

SELF-INSPECTION, RECORDKEEPING AND REPORTING

They are less than 25 gallons but cannot be cleaned up within 24 hours,

Releases of hazardous substances in excess of reportable quantities under Section 311 of

the Clean Water Act (Ref: 40 CFR 110.3 and 40 CFR 117.3) or Section 102 of CERCLA

Noncompliance with the conditions of this permit that may endanger health or the

After a permittee becomes aware of an occurrence that must be reported, he shall contact the

They cause sheen on surface waters (regardless of volume), or

They are within 100 feet of surface waters (regardless of volume).

IAZARDOUS AND TOXIC WASTE Create designated hazardous waste collection areas on-site. Place hazardous waste containers under cover or in secondary containment. Do not store hazardous chemicals, drums or bagged materials directly on the ground.

TEMPORARY SILT FENCE

NPDES GROUND STABILIZATION CRITERIA TE POLLUTANTS NOTES

LOCATE AREAS DEDICATED FOR MANAGEMENT OF LAND CLEARING ND DEMOLITION DEBRIS, CONSTRUCTION AND DOMESTIC WASTE, AND HAZARDOUS OR TOXIC WASTE. THIS LOCATION SHALL BE AT LEAST 50' AWAY FROM STORM DRAIN INLETS AND SURFACE WATERS UNLESS T CAN BE SHOWN THAT NO OTHER ALTERNATIVES ARE REASONABLY 2. DUMPING OF PAINT OR OTHER LIQUID BUILDING MATERIAL WASTES N STORM DRAINS IS PROHIBITED. 3. LITTER AND SANITARY WASTE-THE PERMITTEE SHALL CONTROL THE MANAGEMENT AND DISPOSAL OF LITTER AND SANITARY WASTE FROM 4. LOCATE EARTHEN-MATERIAL STOCK PILE AREAS AT LEAST 50' AWAY FROM STORM DRAIN INLETS AND SURFACE WATERS UNLESS IT

TEMPORARY SEEDING SPECIFICATION

Rye (grain) Annual lespedeza (Kobe in Piedmont and Coastal Plain, Korean in Mountains)

Omit annual lespedeza when

in the Piedmont and mountains, a

ountains — May 15—Aug 15

SOIL AMENDMENTS

MAINTENANCE

SEEDING NOTES (SPRING-SUMMER)

SEEDING MIXTURE

SEEDING DATES

SITE AREA DESCRIPTION

PERIMETER DIKES, SWALES, DITCHES AND SLOPES

SLOPES STEEPER THAN 3:1

SLOPES 3:1 OR

ALL OTHER AREAS 14 DAYS WITH SLOPES FLATTER THAN 4:1

HIGH QUALITY

WATER (HQW) ZONES

Mountains — Aug 15—Dec 15 Coastal Plain and Pledmont — Aug 15—Dec 30

2,000 LF/ACRE GROUND AGRICULTURAL LIMESTONE AND 750 LB/ACRE 10-10-10 FERTILIZER.

APPLY 4,000 LB/ACRE STRAW. ANCHOR STRAW BY TACKING WITH ASPHALT, NETTING, OR A MULCH ANCHORING TOOL. A DISK WITH BLADES SET NEARLY STRAIGHT CAN BE USED AS A MULCH ANCHORING TOOL.

REFERTILIZE IF GROWTH IS NOT FULLY ADEQUATE. RESEED, REFERTILIZE AND MULCH IMMEDIATELY FOLLOWING EROSION OR OTHER DAMAGE.

PERMANENT GRASSING DETAIL

WHERE A NEAT APPEARANCE IS DESIRED, OMIT SERICEA.
 USE COMMON BERUDAGRASS ONLY ON ISOLATED SITES WHERE IT CANNOT BECOME A PEST. BERMUDAGRASS MAY BE REPLACED WITH 5 1b/cgre CENTIPEDECRASS.

APPLY LIME AND FERTILIZER ACCORDING TO SOIL TESTS, OR APPLY

3,000 ib/acre GROUND AGRICULTURE LIMESTONE AND 500 ib/acre

10-10-10 FERTILIZER.

APPLY LIME AND FERTILIZER ACCORDING TO SOIL TESTS, OR APPLY
3,000-5,000 Ib/acre ground agriculture limestone (USE the Lower
RATE ON SANDY SOILS) AND 1,000 Ib/acre 10-10-10 FERTILIZER.

APPLY 4,000 Ib/gate Grain Strawor Equivalent cover of another suitable Mulch. Anchor by Tacking with Asphalt, rowing, or netting or by crimping with a mulch anchoring tool. A disk with blades set nearly straight can be used as a mulch anchoring tool.

NEEDED.
FERTILIZE ACCORDING TO SOIL TESTS OR APPLY 40 LF/ACRE NITROGEN IN JANUARY OR FEBRUARY, 40 LB IN SEPTEMBER AND 40 LB IN NOVEMBER, FROM A 12-4-8, 16-4-8, OR SIMILAR TURF FERTILIZER. AVOID FERTILIZER APPLICATIONS DURING WARM WEATHER, AS THIS INCREASES STAND LOSSES TO DISEASE. RESEED, FERTILIZE, AND MULCH DAMAGED AREAS IMMEDIATELY. MOW TO A HEIGHT OF 2.5-3.5 INCHES AS NEEDED.

IF SLOPES ARE 10' OR

7 DAYS FOR SLOPES

NONE (EXCEPT FOR PERIMETERS AND

IN LENGTH

HQW ZONES)

GREATER THAN 50 FEET

LESS IN LENGTH AND ARE NOT STEEPER THAN 2:1, 14 DAYS ARE ALLOWED

STABILIZATION TIMEFRAME

7 DAYS

14 DAYS

small—stemmed sundangrass may be substituted at a rate of 50 lf/acre

/19-GAUGE HARDWARE CLOTH (1/4 MESH OPENINGS)

(2° OR GREATER) RAINFALL EVENT. CLEAR THE OR OTHER OBJECTS TO PROVIDE LOW FOR SUBSEQUENT RAINS. TAKE CARE NOT OR UNDERCUT THE WIRE MESH DURING DEMOVAL. REPLACE STOME AS NEEDED.

+-----

ARDWARE CLOTH AND GRAVEL INLET PROTECTION

CAN BE SHOWN THAT NO OTHER ALTERNATIVES ARE REASONABLY CONCRETE MATERIALS ONSITE, INCLUDING EXCESS CONCRETE, MUST BE CONTROLLED AND MANAGED TO AVOID CONTACT WITH SURFACE WATERS, WETLANDS OR BUFFERS. NO CONCRETE OR CEMENT SLURRY SHALL BE DISCHARGED FROM THE SITE. 5. ANY HARDENED CONCRETE RESIDUE WILL BE DISPOSED OF, OR RECYCLED ON SITE, IN ACCORDANCE WITH LOCAL AND STATE SOLID WASTE REGULATIONS.
7. SOIL STABILIZATION SHALL BE ACHEIVED ON ANY AREA OF A SITE WHERE LAND-DISTURBING ACTIVITIES HAVE TEMPORARILY OR PERMANENTLY CEASED ACCORDING TO THE FOLLOWING SCHEDULE: . ALL PERIMETER DIKES, SWALES, DITCHES, PERIMETER SLOPES AND ALL SLOPES STEEPER THAN 3 HORIZONTAL TO 1 VERTICAL (3:1) SHALL BE PROVIDED TEMPORARY OR PERMANENT STABILIZATION WITH GROUND COVER AS SOON AS PRACTICABLE BUT IN ANY EVENT WITHIN 7 CALENDAR DAYS FROM THE LAST LAND DISTURBING ACTIVITY. . ALL OTHER DISTURBED AREAS SHALL BE PROVIDED TEMPORAR'S PERMANENT STABILIZATION WITH GROUND COVER AS SOON AS PRACTICABLE BUT IN ANY EVENT WITHIN 14 CALENDAR DAYS FROM CONDITIONS-IN MEETING THE STABILIZATION REQUIREMENTS ABOVE. FOLLOWING CONDITIONS OR EXEMPTIONS SHALL APPLY: EXTENSIONS OF TIME MAY BE APPROVED BY THE PERMITTING UTHORITY BASED ON WEATHER OR OTHER SITE-SPECIFIC CONDITIONS THAT MAKE COMPLIANCE IMPRACTICABLE. ii. ALL SLOPES 50' IN LENGTH OR GREATER SHALL APPLY TO GROUND COVER WITHIN 7 DAYS EXCEPT WHEN THE SLOPE IS FLATTER

THAN 4:1. SLOPES LESS THAN 50' SHALL APPLY GROUND COVER WITHIN 14 DAYS EXCEPT WHEN SLOPES ARE STEEPER THAN 3:1, THE -DAY REQUIREMENT APPLIES. ANY SLOPED AREA FLATTER THAN 4:1 SHALL BE EXEMPT FROM THE 7-DAY GROUND COVER REQUIREMENT. . SLOPES 10' OR LESS IN LENGTH SHALL BE EXEMPT FROM THE 7-DAY GROUND COVER REQUIREMENT EXCEPT WHEN THE SLOPE IS v. ALTHOUGH STABILIZATION IS USUALLY SPECIFIED AS GROUND COVER, OTHER METHODS, SUCH AS CHEMICAL STABILIZATION, MAY BE ALLOWED ON A CASE-BY-CASE BASIS.

VI. FOR PORTIONS OF PROJECTS WITHIN THE SEDIMENT CONTROL COMMISSION-DEFINED "HIGH QUALITY WATER ZONE" (15A NCAC 04A. 0105), STABILIZATION WITH GROUND COVER SHALL BE ACHIEVED AS SOON AS PRACTICABLE BUT IN ANY EVENT ON ALL AREAS OF THE SITE WITHIN 7 CALENDAR DAYS FROM THE LAST LAND-DISTURBING

TEMPORARY GRAVELLED CONSTRUCTION ENTRANCE

**₩** |-|<u>|</u>||-|| BASIC INSTALLATION GUIDELINES

EXCELSIOR MATTING INSTALLATION

WITH GENERAL RESTALLATION. (SEE DIAGRAMS D & C)
7. THE END OF BLANKET MUST BE SECURED IN A 6" X 6" TRENCH WITH A ROW OF STAPLES PLACED AT 12" INTERNALS. (SEE DIAGRAM P)

appropriate Division regional office within the timeframes and in accordance with the other requirements listed below. Occurrences outside normal business hours may also be reported to the Division's Emergency Response personnel at (800) 662-7956, (800) Reporting Timeframes (After Discovery) and Other Requirements (a) Visible Within 24 hours, an oral or electronic notification. sediment Within 7 calendar days, a report that contains a description of the sediment and actions taken to address the cause of the deposition. deposition in a stream or wetland Division staff may waive the requirement for a written report on a • If the stream is named on the NC 303(d) list as impaired for sedimentrelated causes, the permittee may be required to perform additional monitoring, inspections or apply more stringent practices if staff determine that additional requirements are needed to assure compliance with the federal or state impaired-waters conditions. (b) Oil spills and Within 24 hours, an oral or electronic notification. The release of notification shall include information about the date, time, nature, hazardous volume and location of the spill or release. substances per Item 1(b)-(c) · A report at least ten days before the date of the bypass, if bypasses [40 CFR possible. The report shall include an evaluation of the anticipated 122.41(m)(3)] quality and effect of the bypass. Within 24 hours, an oral or electronic notification. bypasses [40 CFR • Within 7 calendar days, a report that includes an evaluation of 122.41(m)(3)] the quality and effect of the bypass. (e) Noncompliance • Within 24 hours, an oral or electronic notification. Within 7 calendar days, a report that contains a description of the including exact dates and times, and if the noncompliance has not endanger health or been corrected, the anticipated time noncompliance is expected to

continue; and steps taken or planned to reduce, eliminate, and


CFR 122.41(I)(7)] • Division staff may waive the requirement for a written report on a

prevent reoccurrence of the noncompliance. [40 CFR 122.41(I)(6).

NORTH CAROLINA Environmental Quality

NCG01 SELF-INSPECTION, RECORDKEEPING AND REPORTING

EFFECTIVE: 03/01/19

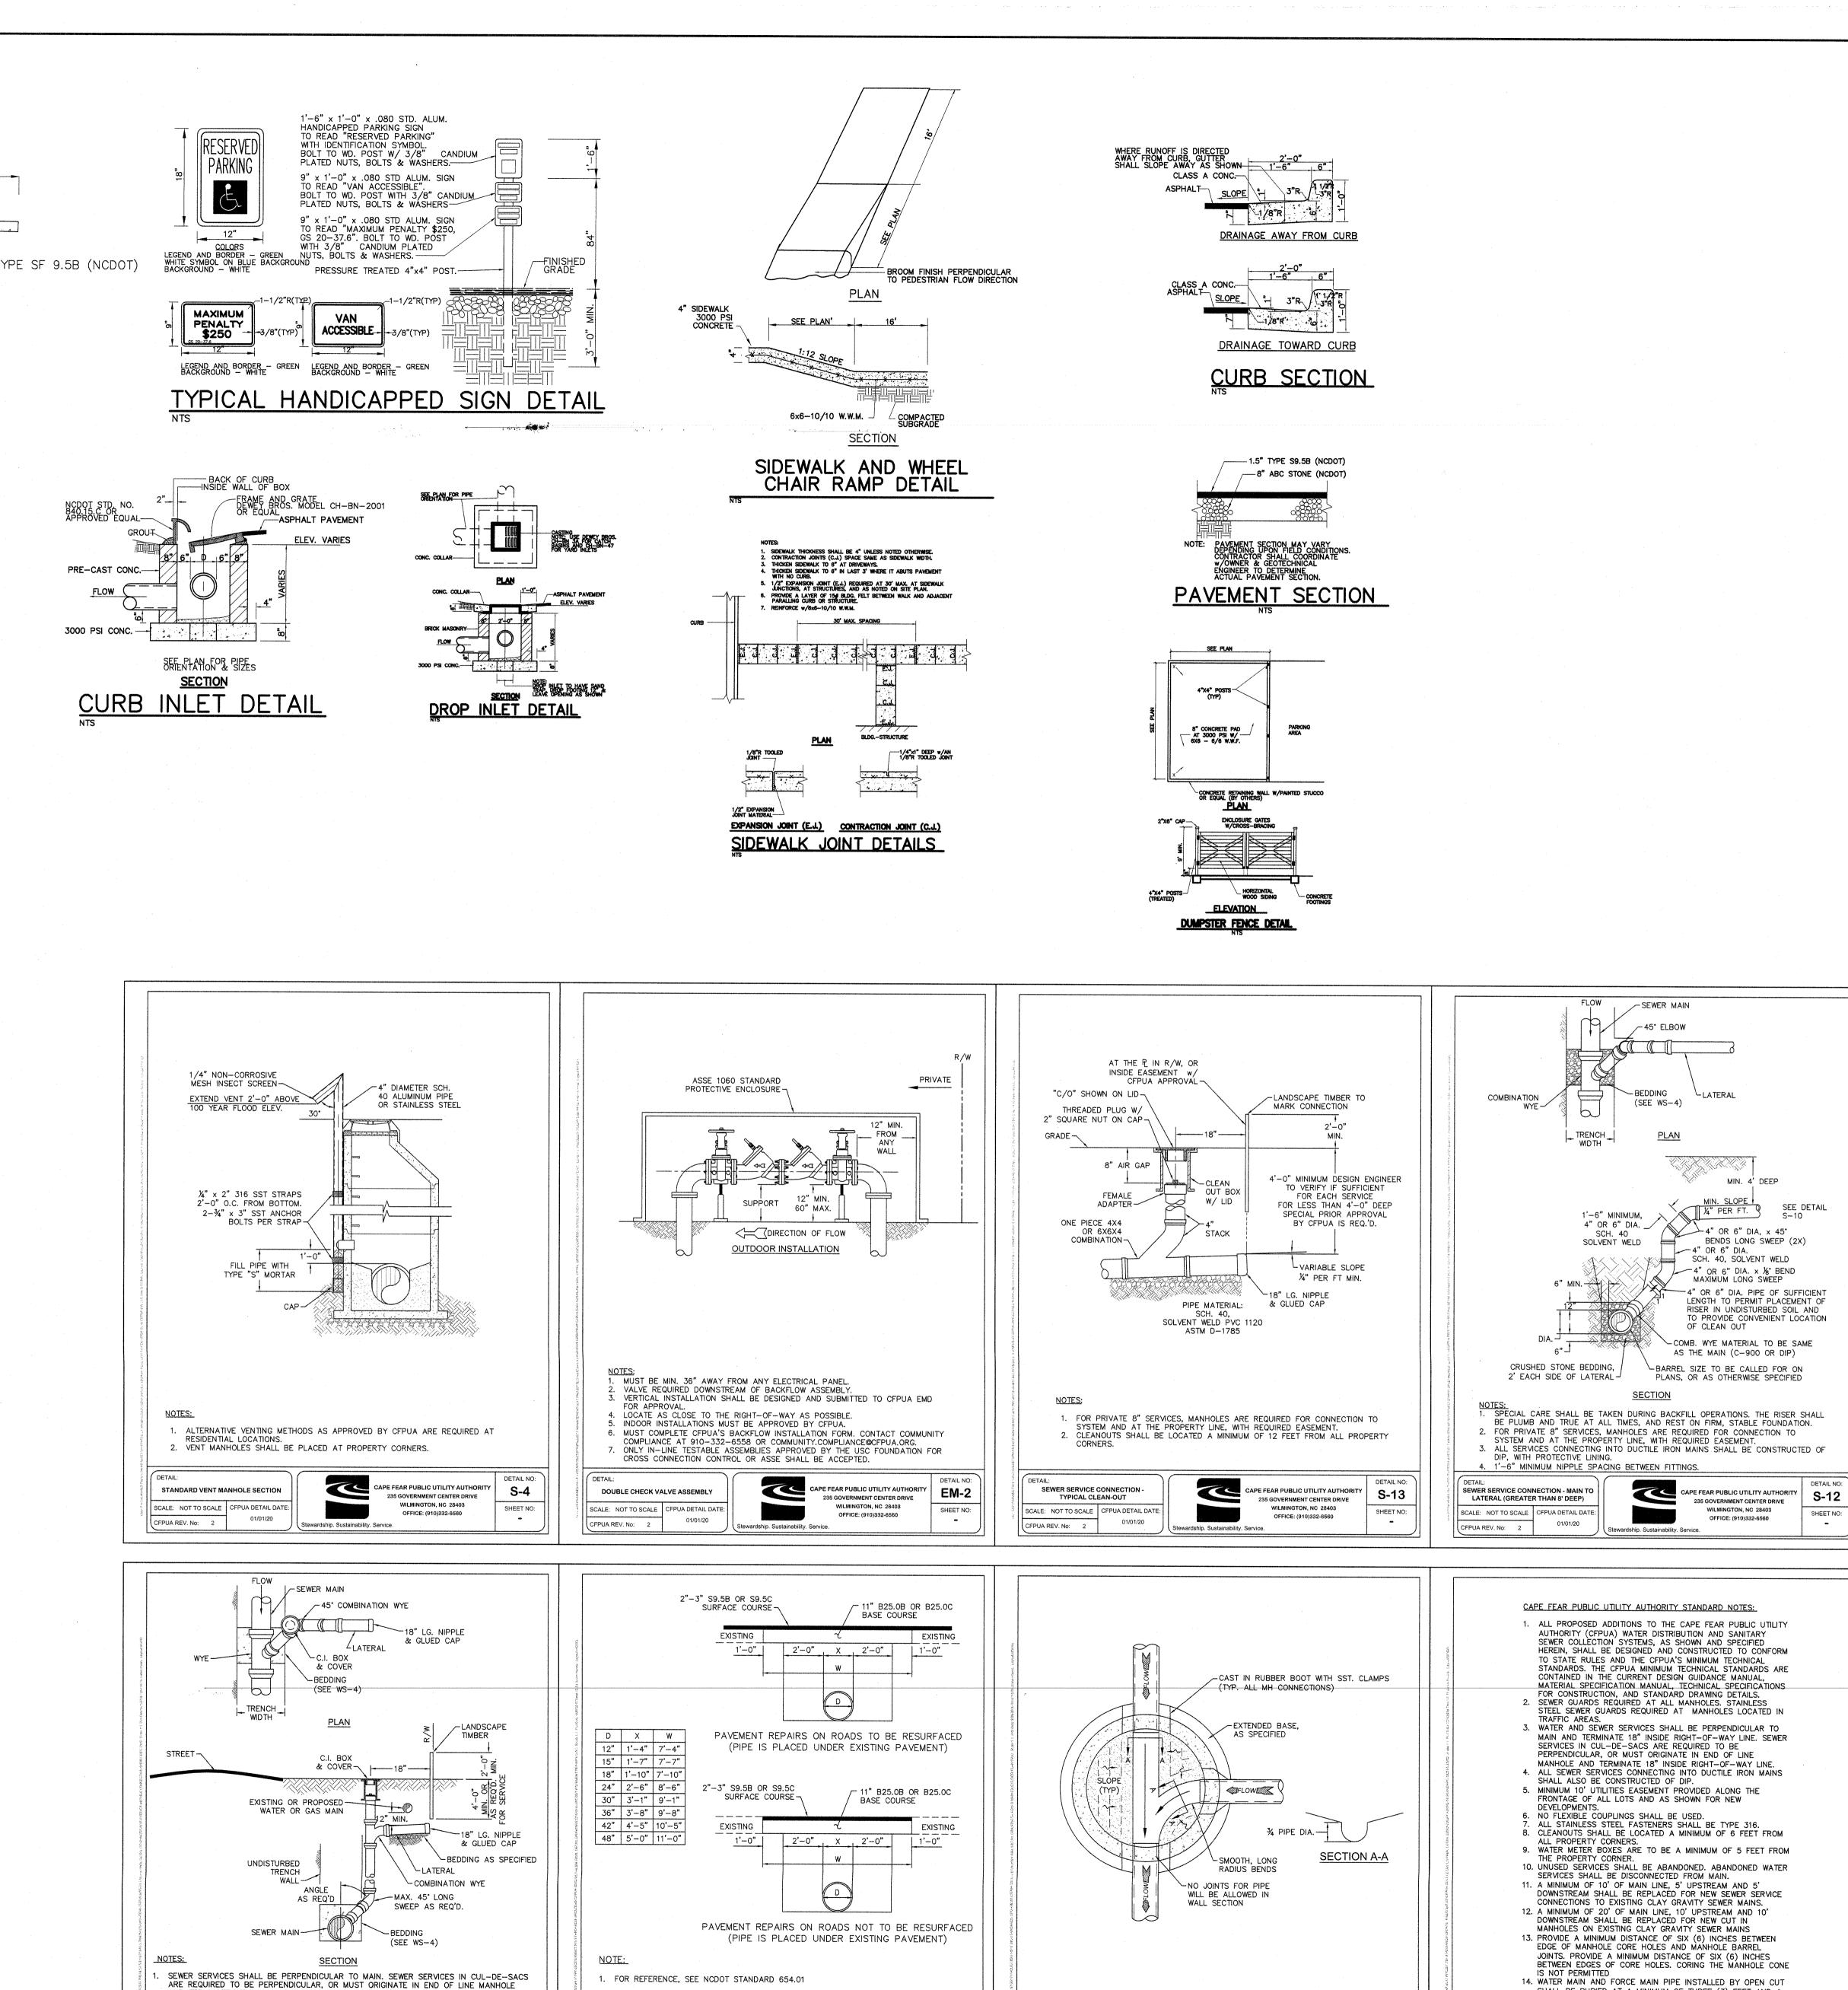

CAPE FEAR PUBLIC UTILITY AUTHORITY

235 GOVERNMENT CENTER DRIVE

WS-3

235 GOVERNMENT CENTER DRIVE

WILMINGTON, NC 28403

OFFICE: (910)332-6560

Stewardship, Sustainability, Service,

NCDOT-PAVEMENT REPAIRS

SCALE: NOT TO SCALE | CFPUA DETAIL DATE:

CFPUA REV. No: 2

01/01/20

(SEE

PLAN)

LAG PUMP ON HIGH LEVEL ALARM LEAD PUMP ON

PUMP OFF

(SEE

PLAN)

ELEVATIONS SHOWN

AND TERMINATE AT RIGHT-OF-WAY LINE

01/01/20

SEWER SERVICE CONNECTION -

SHORT-SIDE

SCALE: NOT TO SCALE | CFPUA DETAIL DATE:

ALL SERVICES CONNECTING INTO DUCTILE IRON MAINS SHALL BE CONSTRUCTED OF DIP, WITH PROTECTIVE LINING.

3. CLEANOUTS SHALL BE LOCATED A MINIMUM OF 12 FEET FROM ALL PROPERTY CORNERS.

CAPE FEAR PUBLIC UTILITY AUTHORITY
235 GOVERNMENT CENTER DRIVE

S-9

WILMINGTON, NC 28403

SHEET NO:

4. FOR PRIVATE 8" SERVICES, MANHOLES ARE REQUIRED FOR CONNECTION TO MAIN.

5. A MINIMUM PIPING LENGTH OF 1' 6" SHALL BE USED BETWEEN FITTINGS.

STREET CROSS-SECTION

EXISTING LIFT STATION DETAIL

ANTZ-BOGGIO Architects & Interior Designers

> BOWMAN **MURRAY** HEMINGWAY ARCHITECT 514 Market Street Wilmington, NC 28401 Tel — (910) 762—2621 Fax — (910) 762—8506

Davis Communications Communications Communication Communic C

ENGINEERINC nut Street n, North Carolina & -763-5100 -763-5631

REVISIONS R1 07-31-20 SITE REV FROM BMH, TRC COMMENTS

CARO! JOB NUMBER

19020 DESIGN BY PGT DRAWN BY EJW

SHALL BE BURIED AT A MINIMUM OF THREE (3) FEET AND A

MAXIMUM OF FIVE (5) FEET BELOW FINISHED GRADE, DEPTHS GREATER THAN FIVE (5) FEET MUST BE APPROVED BY CFPUA.

15. ALL MANHOLE MAIN LINE AND SERVICE PIPING TO BE

CAPE FEAR PUBLIC UTILITY AUTHORITY WS-14

235 GOVERNMENT CENTER DRIVE

WILMINGTON, NC 28403

OFFICE: (910)332-6560

INSTALLED AT A MINIMUM OF CROWN TO CROWN OF THE

Stewardship, Sustainability, Service

LARGEST DIAMETER PIPE.

01/01/20

STANDARD NOTES

SCALE: NOT TO SCALE | CFPUA DETAIL DATE:

CFPUA REV. No: 2

CAPE FEAR PUBLIC UTILITY AUTHORITY

235 GOVERNMENT CENTER DRIVE

OFFICE: (910)332-6560

WILMINGTON, NC 28403


MANHOLE FLOOR PLAN

SCALE: NOT TO SCALE | CFPUA DETAIL DATE:


CFPUA REV. No: 2


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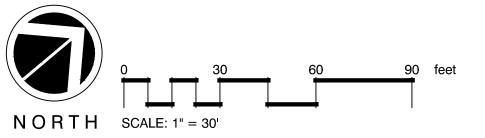




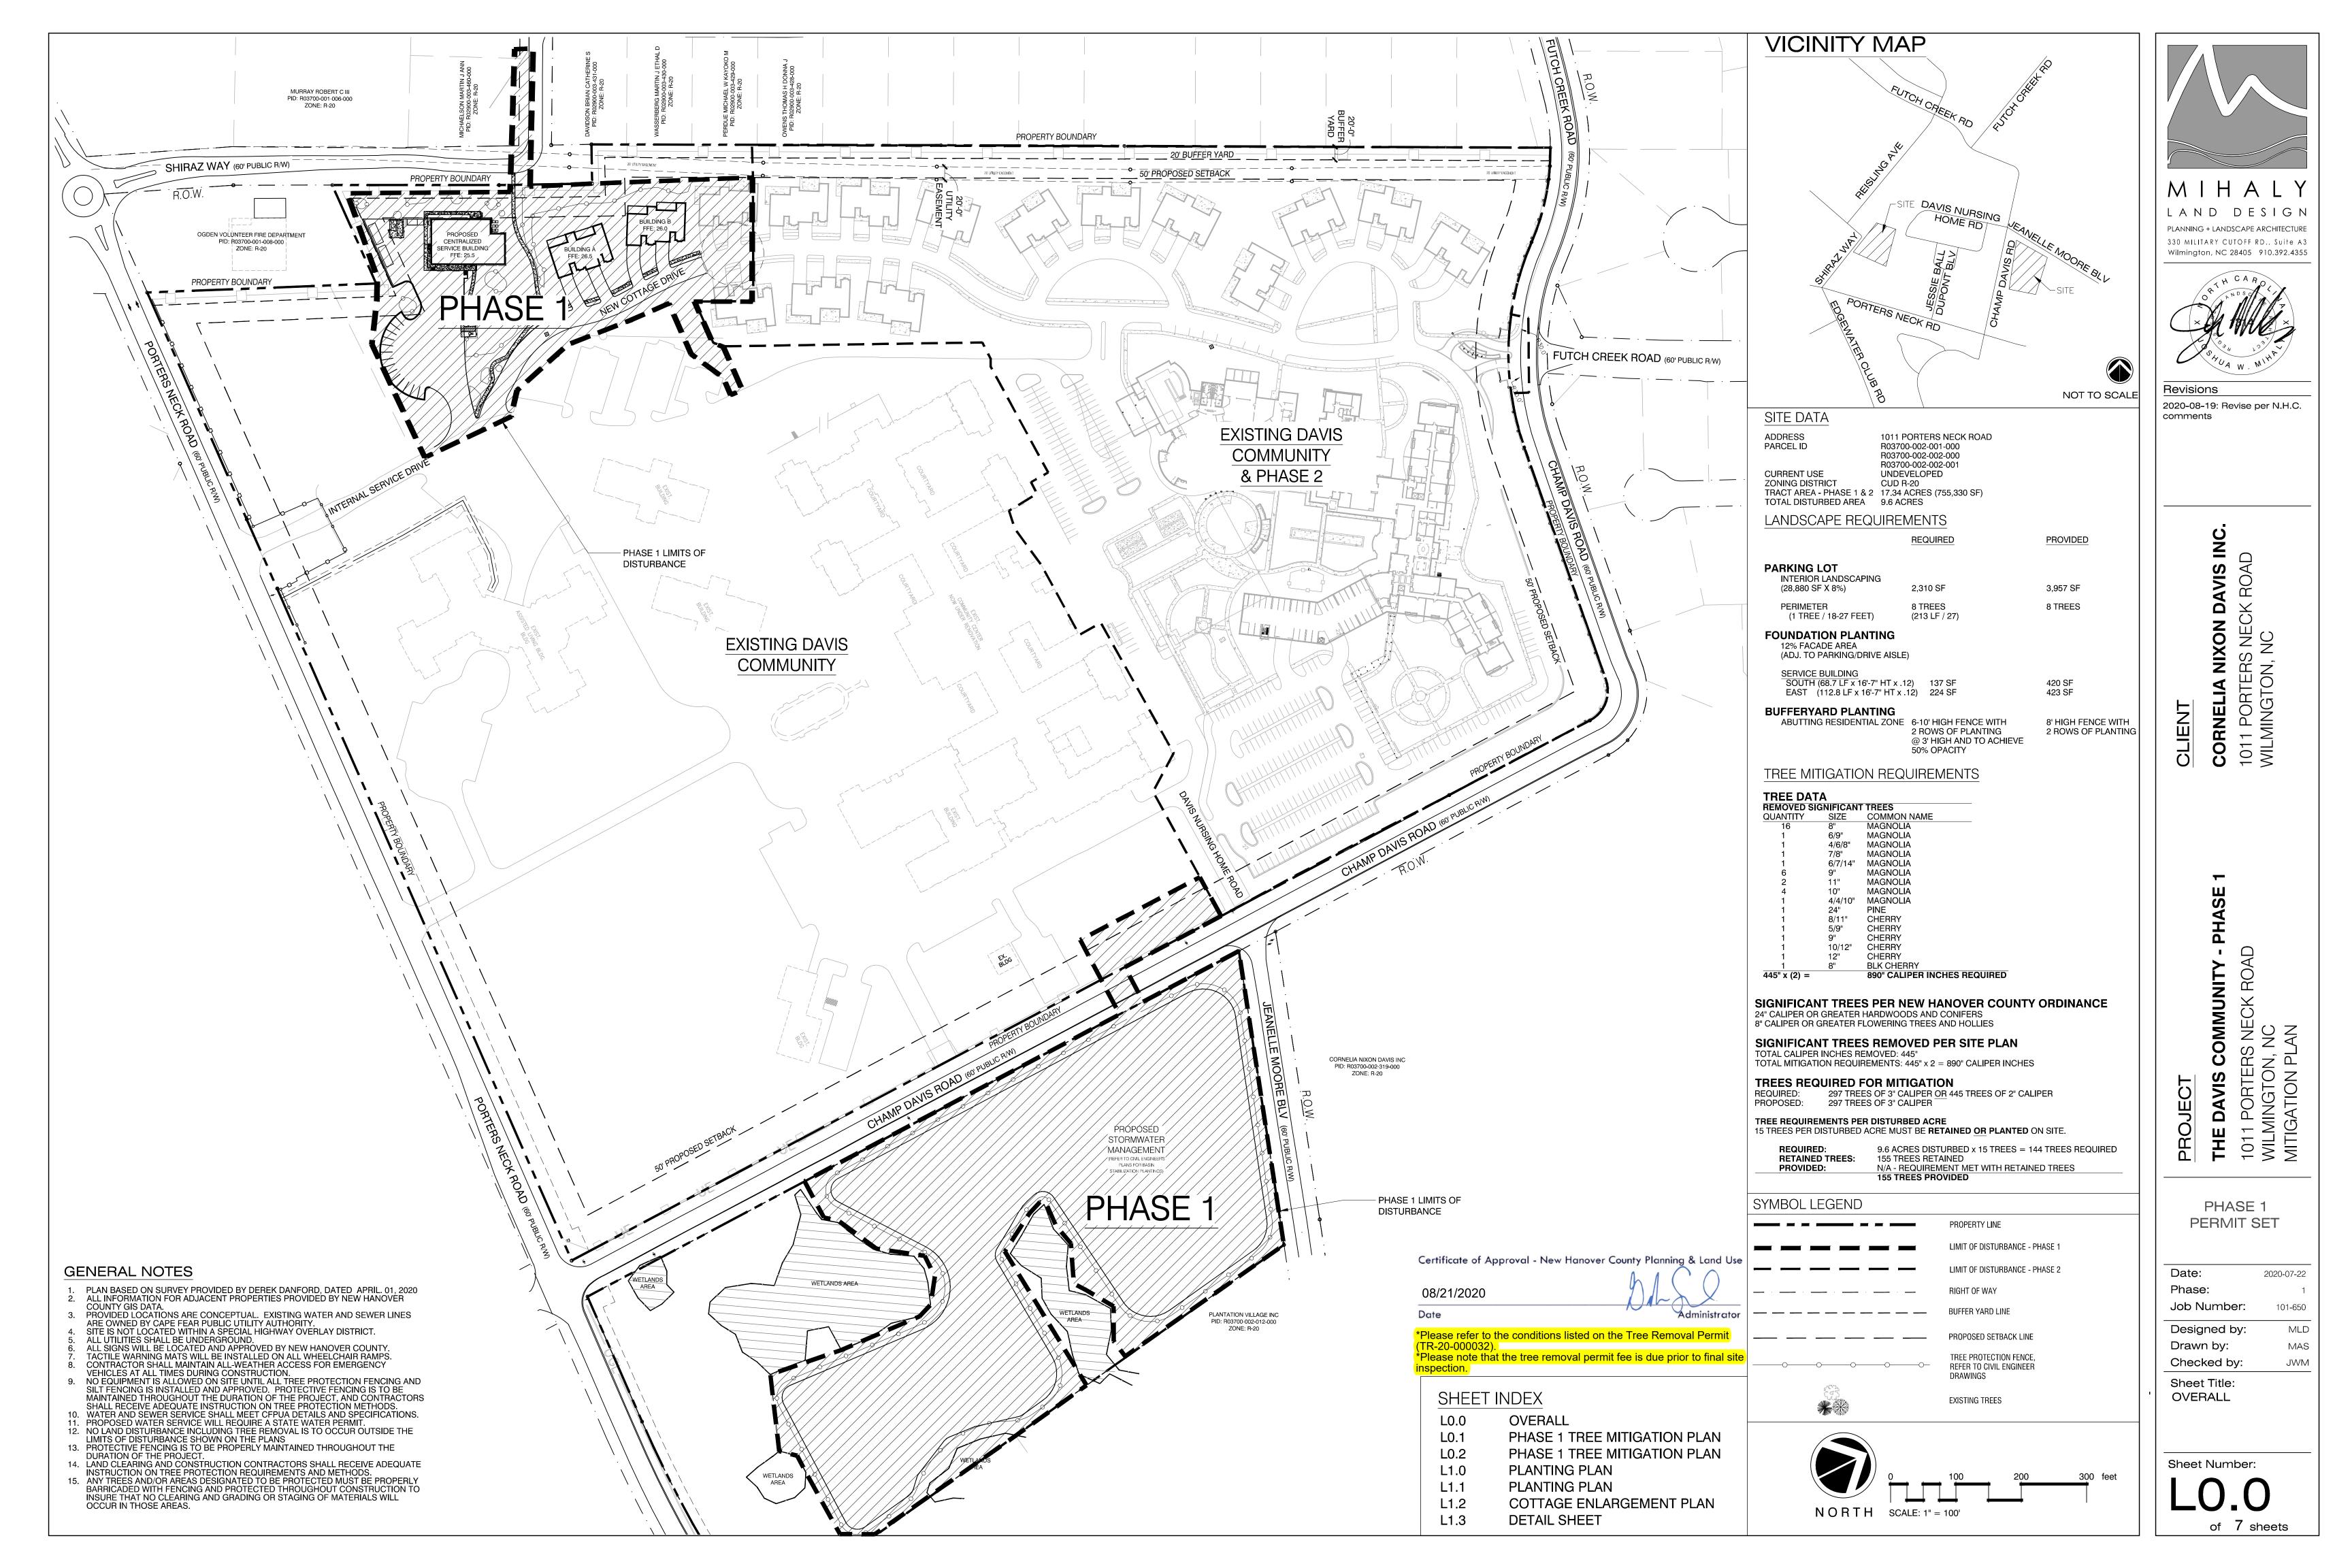

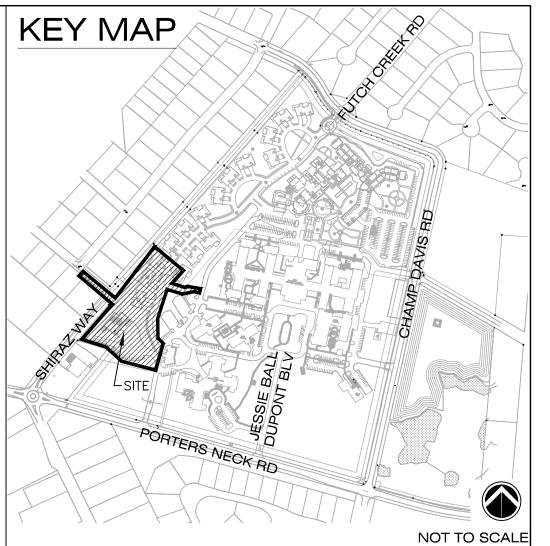

SYMBOL LEGEND	
	PROPERTY LINE
	LIMIT OF DISTURBANCE
	RIGHT OF WAY
	BUFFER YARD LINE
	PROPOSED SETBACK LINE
	TREE PROTECTION FENCE, REFER TO CIVIL ENGINEER DRAWINGS
5 MAG	EXISTING TREES
X 5 MAG	EXISTING TREES TO BE REMOVED
<b>S</b> MAG	EXISTING SIGNIFICANT TREES TO BE REMOVED

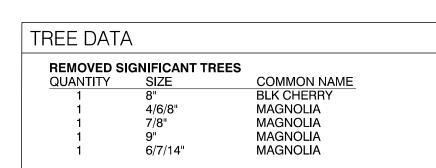



**MIHAL** AND DESIG

330 MILITARY CUTOFF RD., Suite A3 Wilmington, NC 28405 910.392.4355

SHUA W. MINA

Revisions

2020-08-19: Revise per N.H.C. comments

NIXON DAVIS INC.
ERS NECK ROAD
ON NC

CORNELIA NIXON
1011 PORTERS NE

CLIENT

VIS COMMUNITY - PHASE 1
RTERS NECK ROAD

PHASE 1 PERMIT SET

Date: 2020-07-22
Phase: 1
Job Number: 101-650

Designed by: MLD
Drawn by: MAS
Checked by: JWM


Sheet Title: PHASE 1 TREE MITIGATION

Sheet Number:

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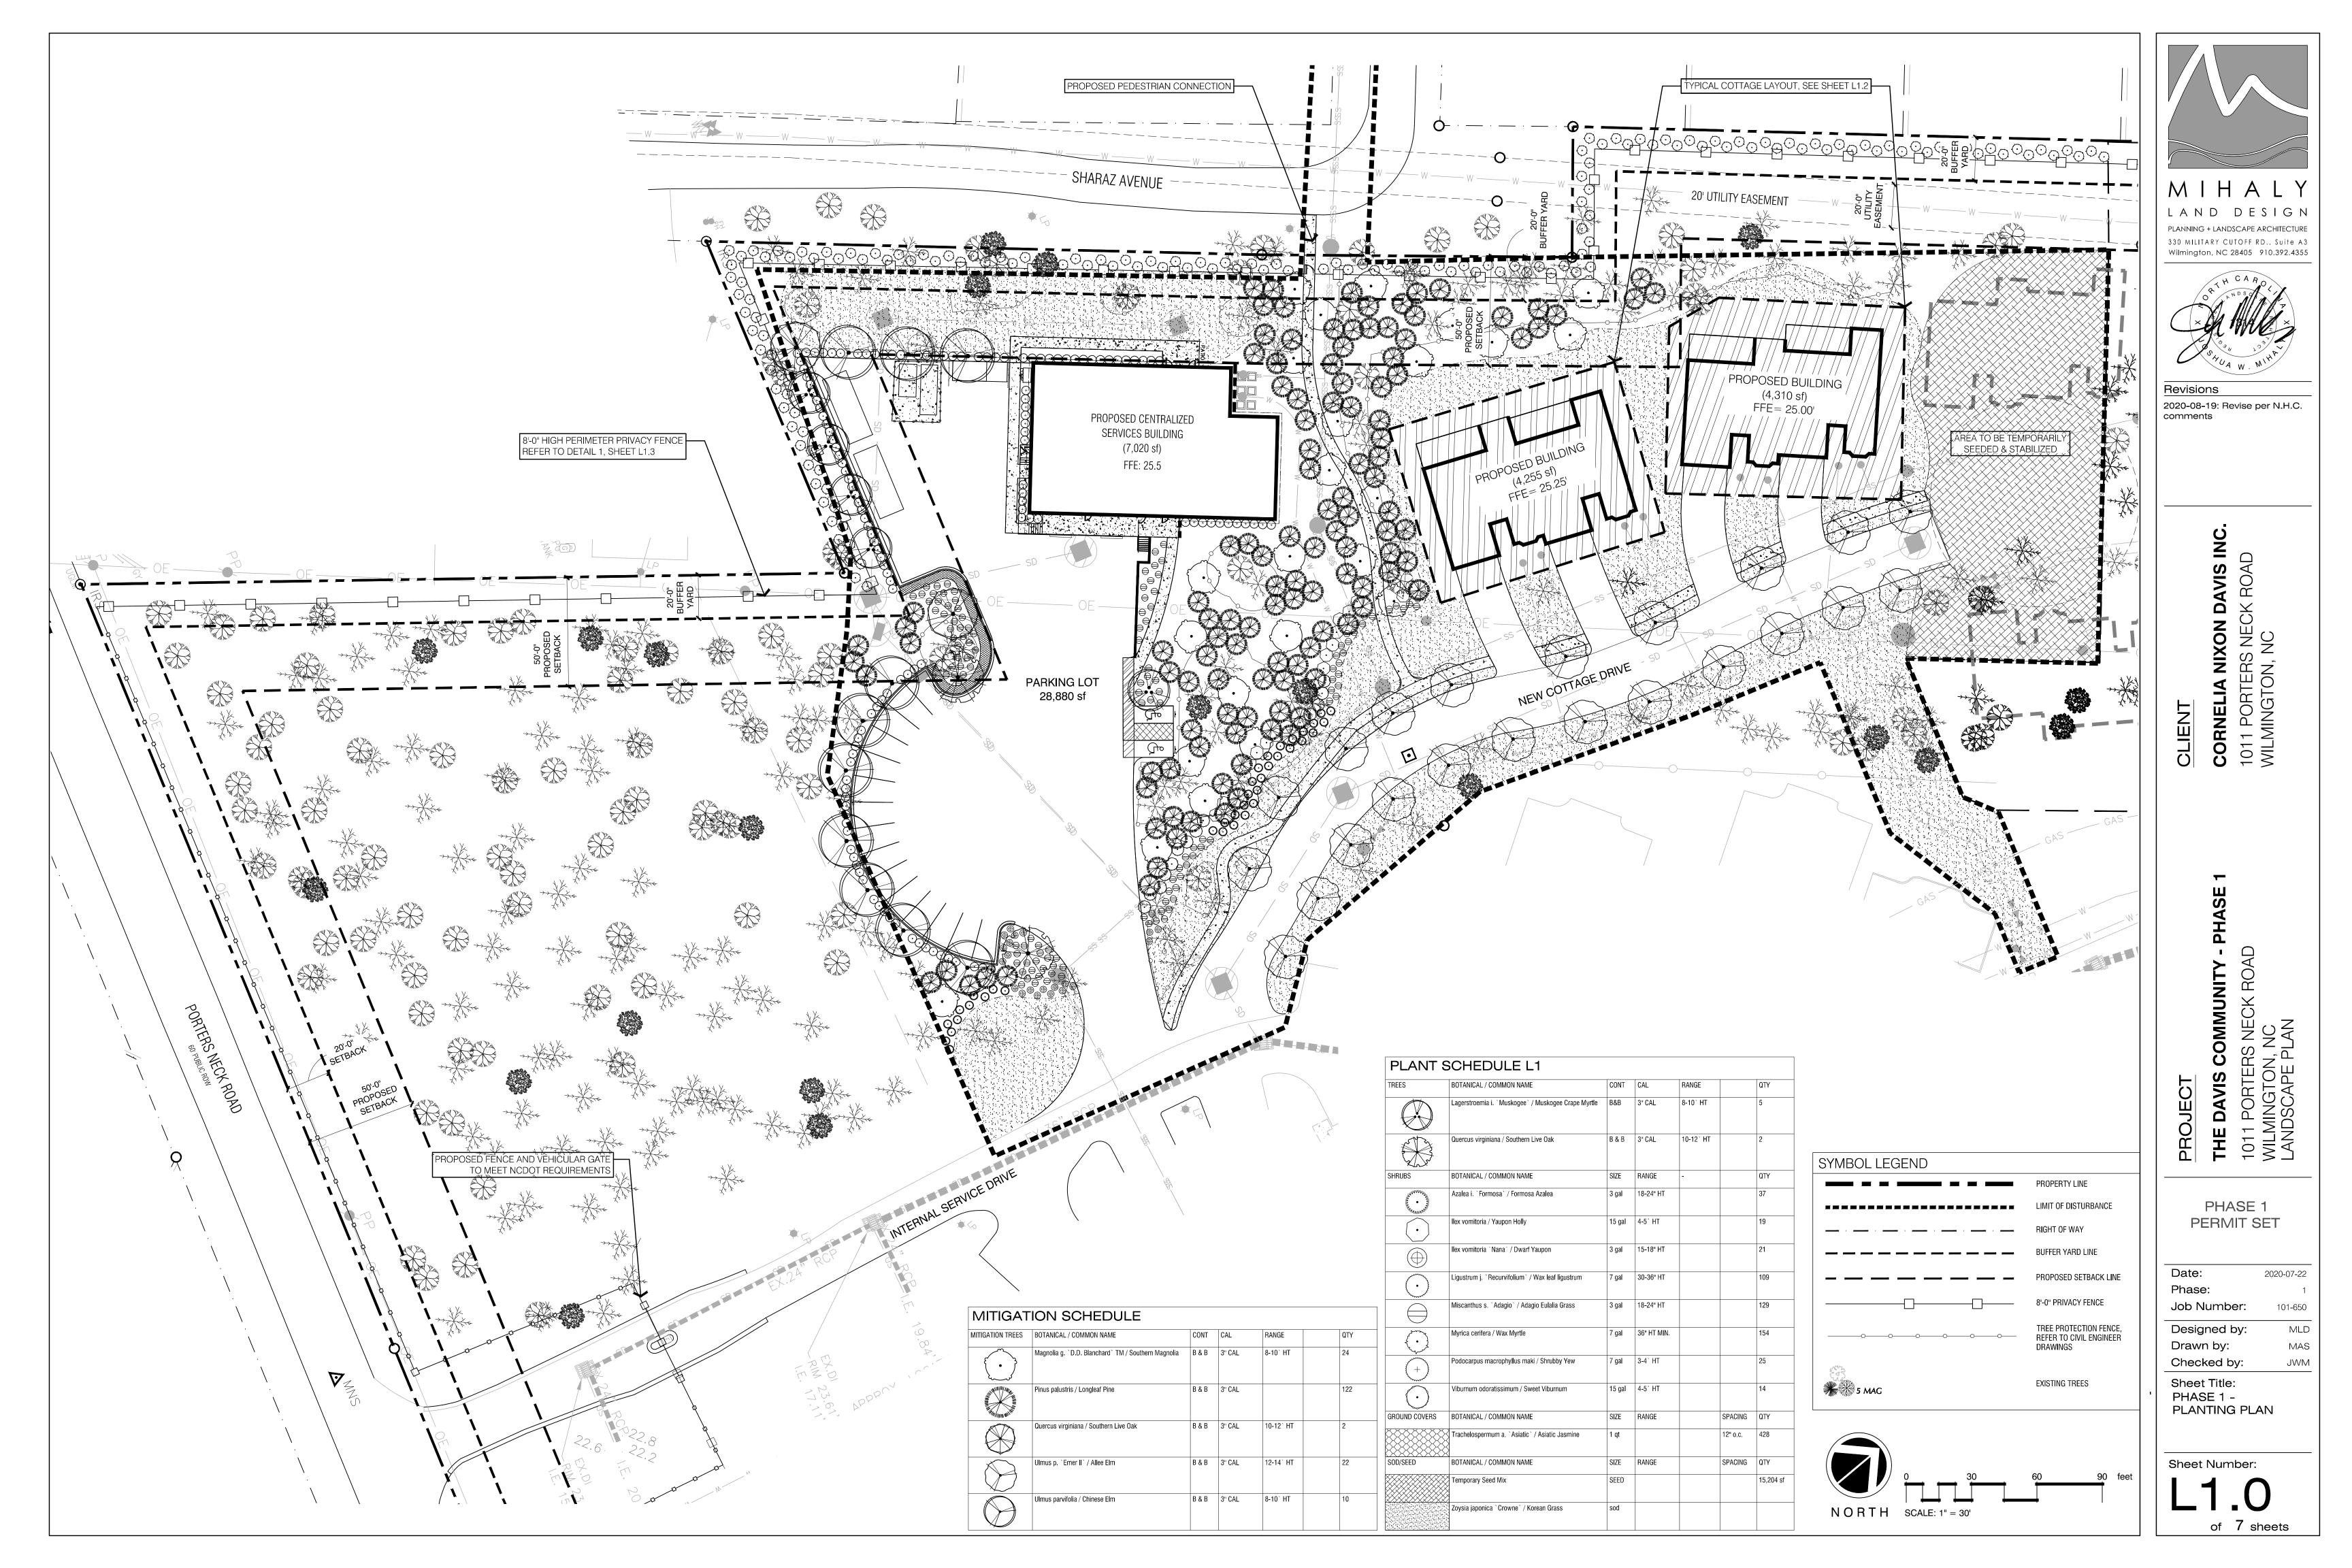
of 7 sheets




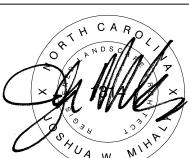


1011 PORTERS WILMINGTON, I MITIGATION PL

Date:	2020-07-22
Phase:	1
Job Number:	101-650
Designed by:	ML
Drawn by:	MAS
Checked by:	JWL
Sheet Title:	



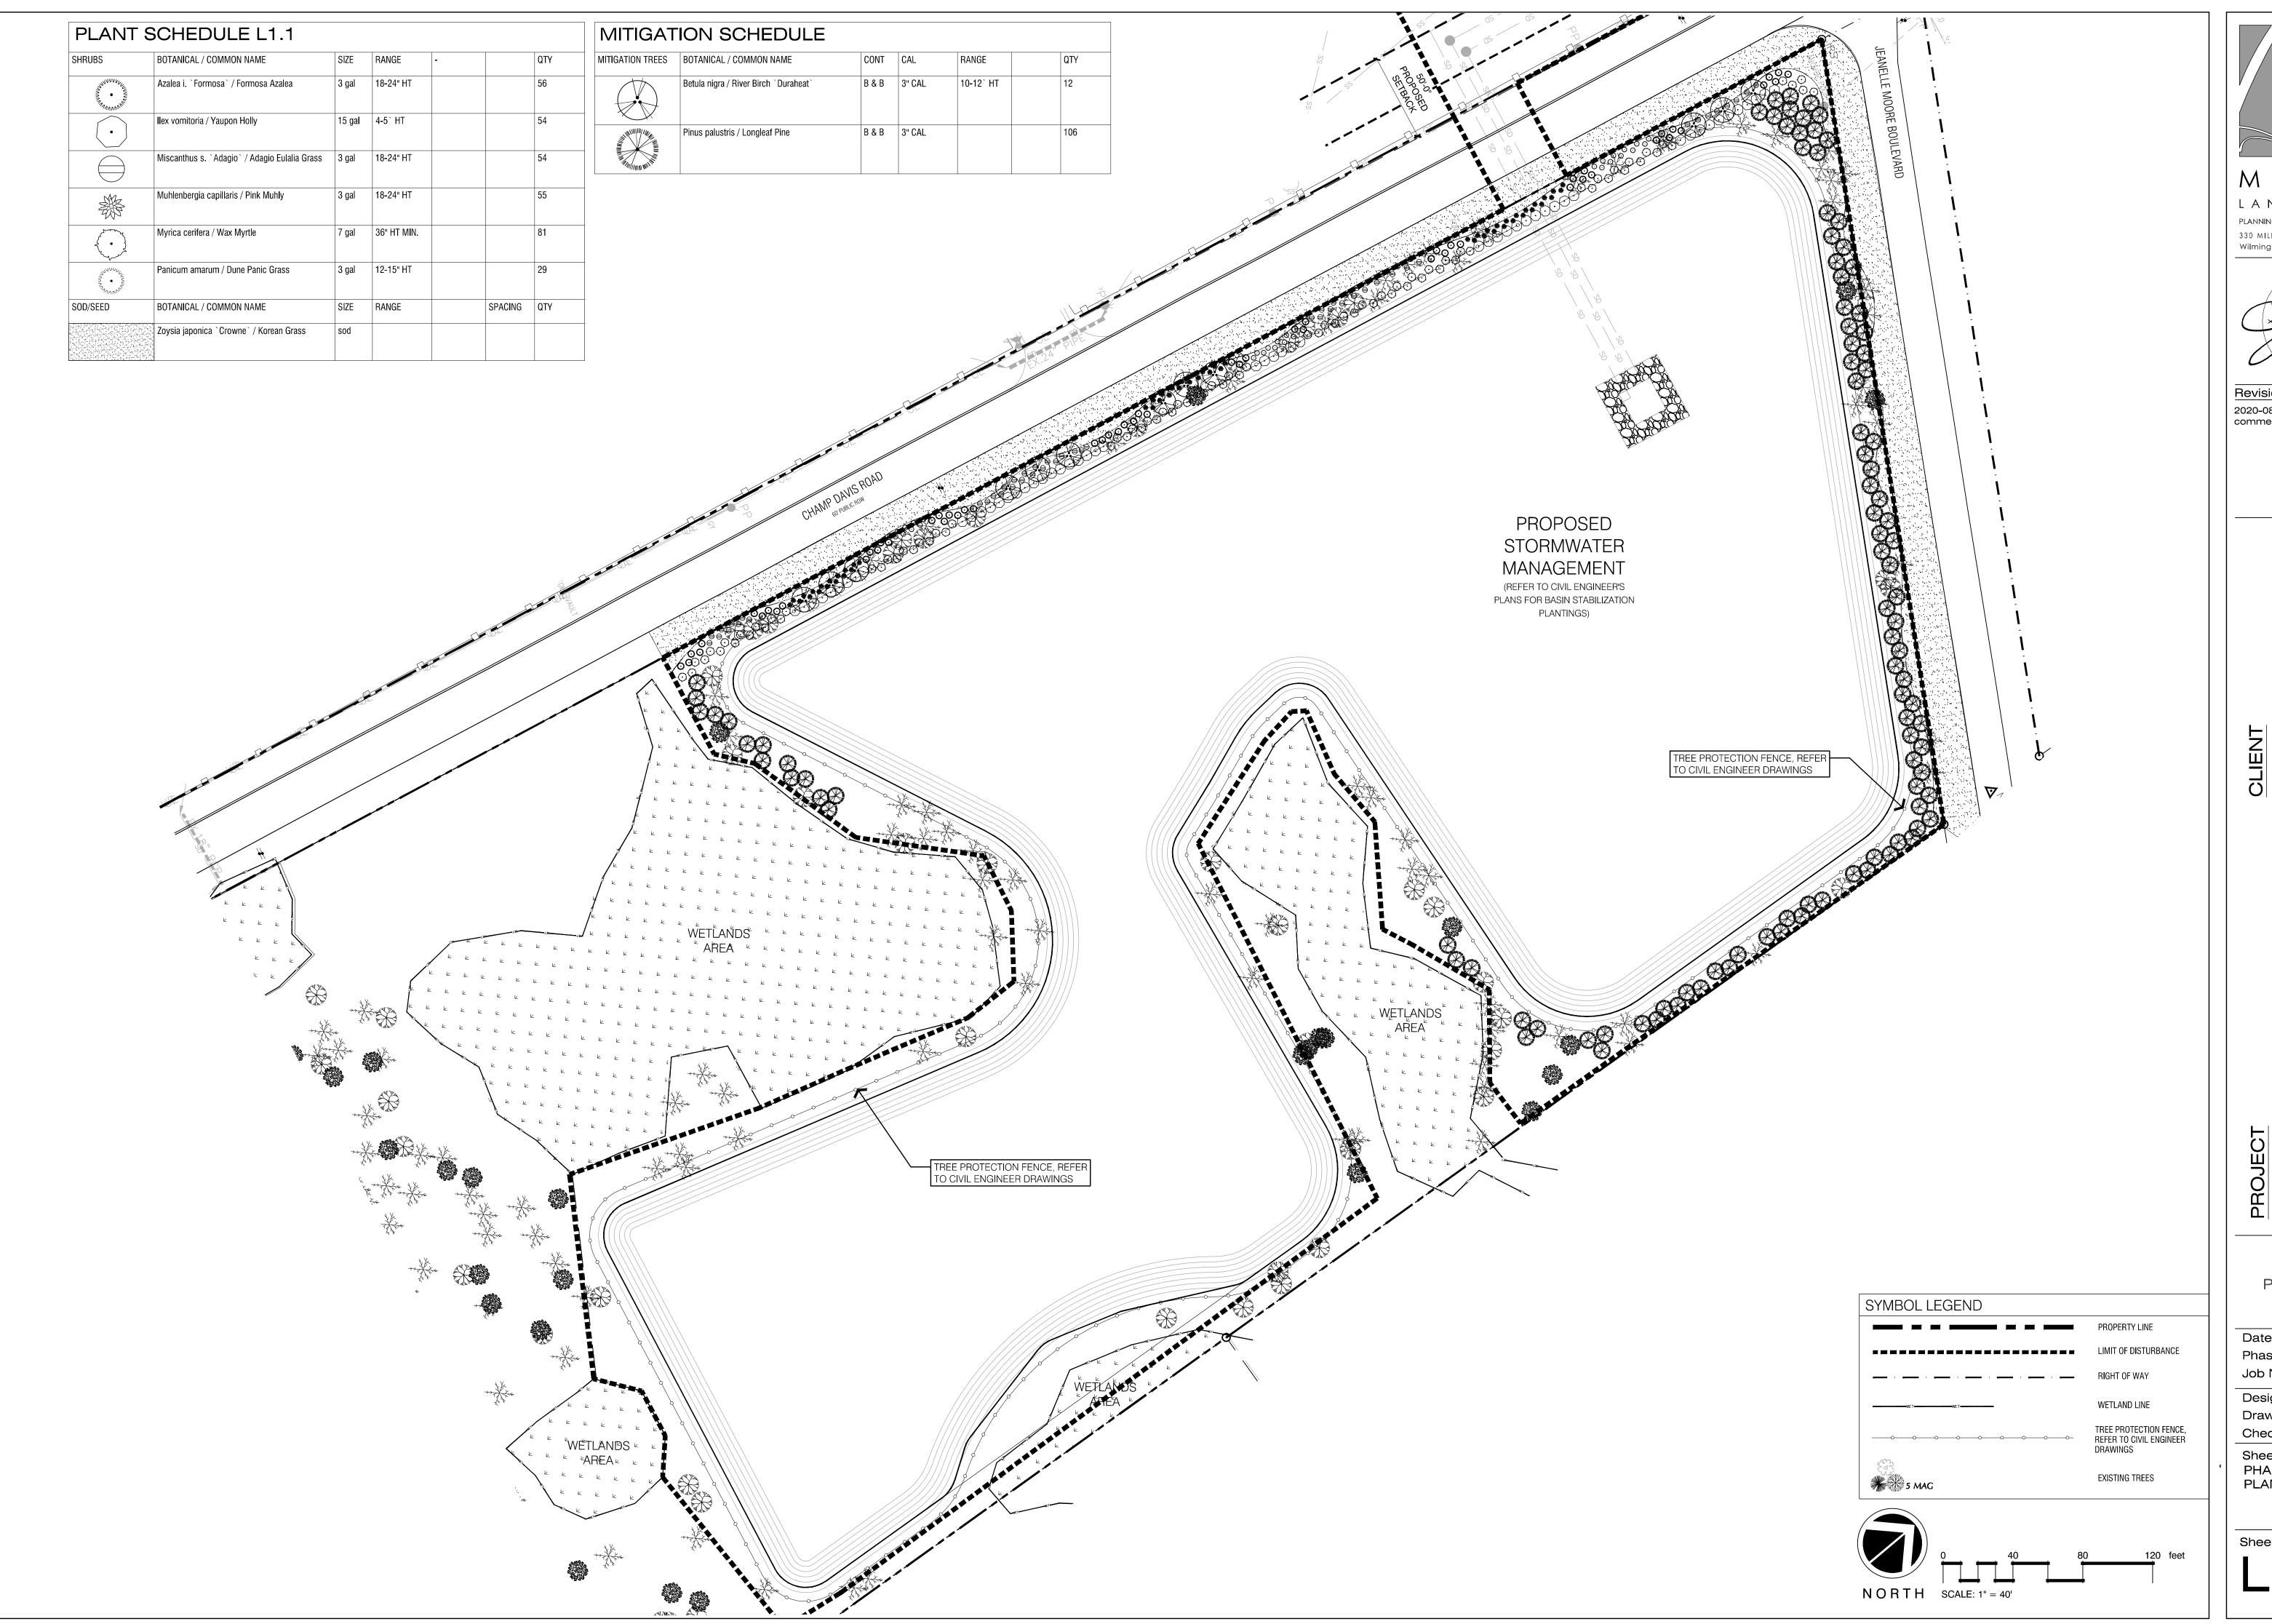

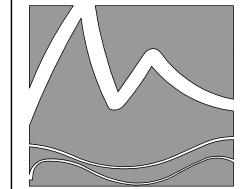

PLANNING + LANDSCAPE ARCHITECTURE 330 MILITARY CUTOFF RD., Suite A3 Wilmington, NC 28405 910.392.4355



Revisions

2020-08-19: Revise per N.H.C. comments


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PHASE 1 PERMIT SET


Date:	2020-07-22
Phase:	1
Job Number:	101-650
Designed by:	MLI
Drawn by:	MA
Checked by:	JWL
Sheet Title:	


PHASE 1 -PLANTING PLAN

Sheet Number: of 7 sheets

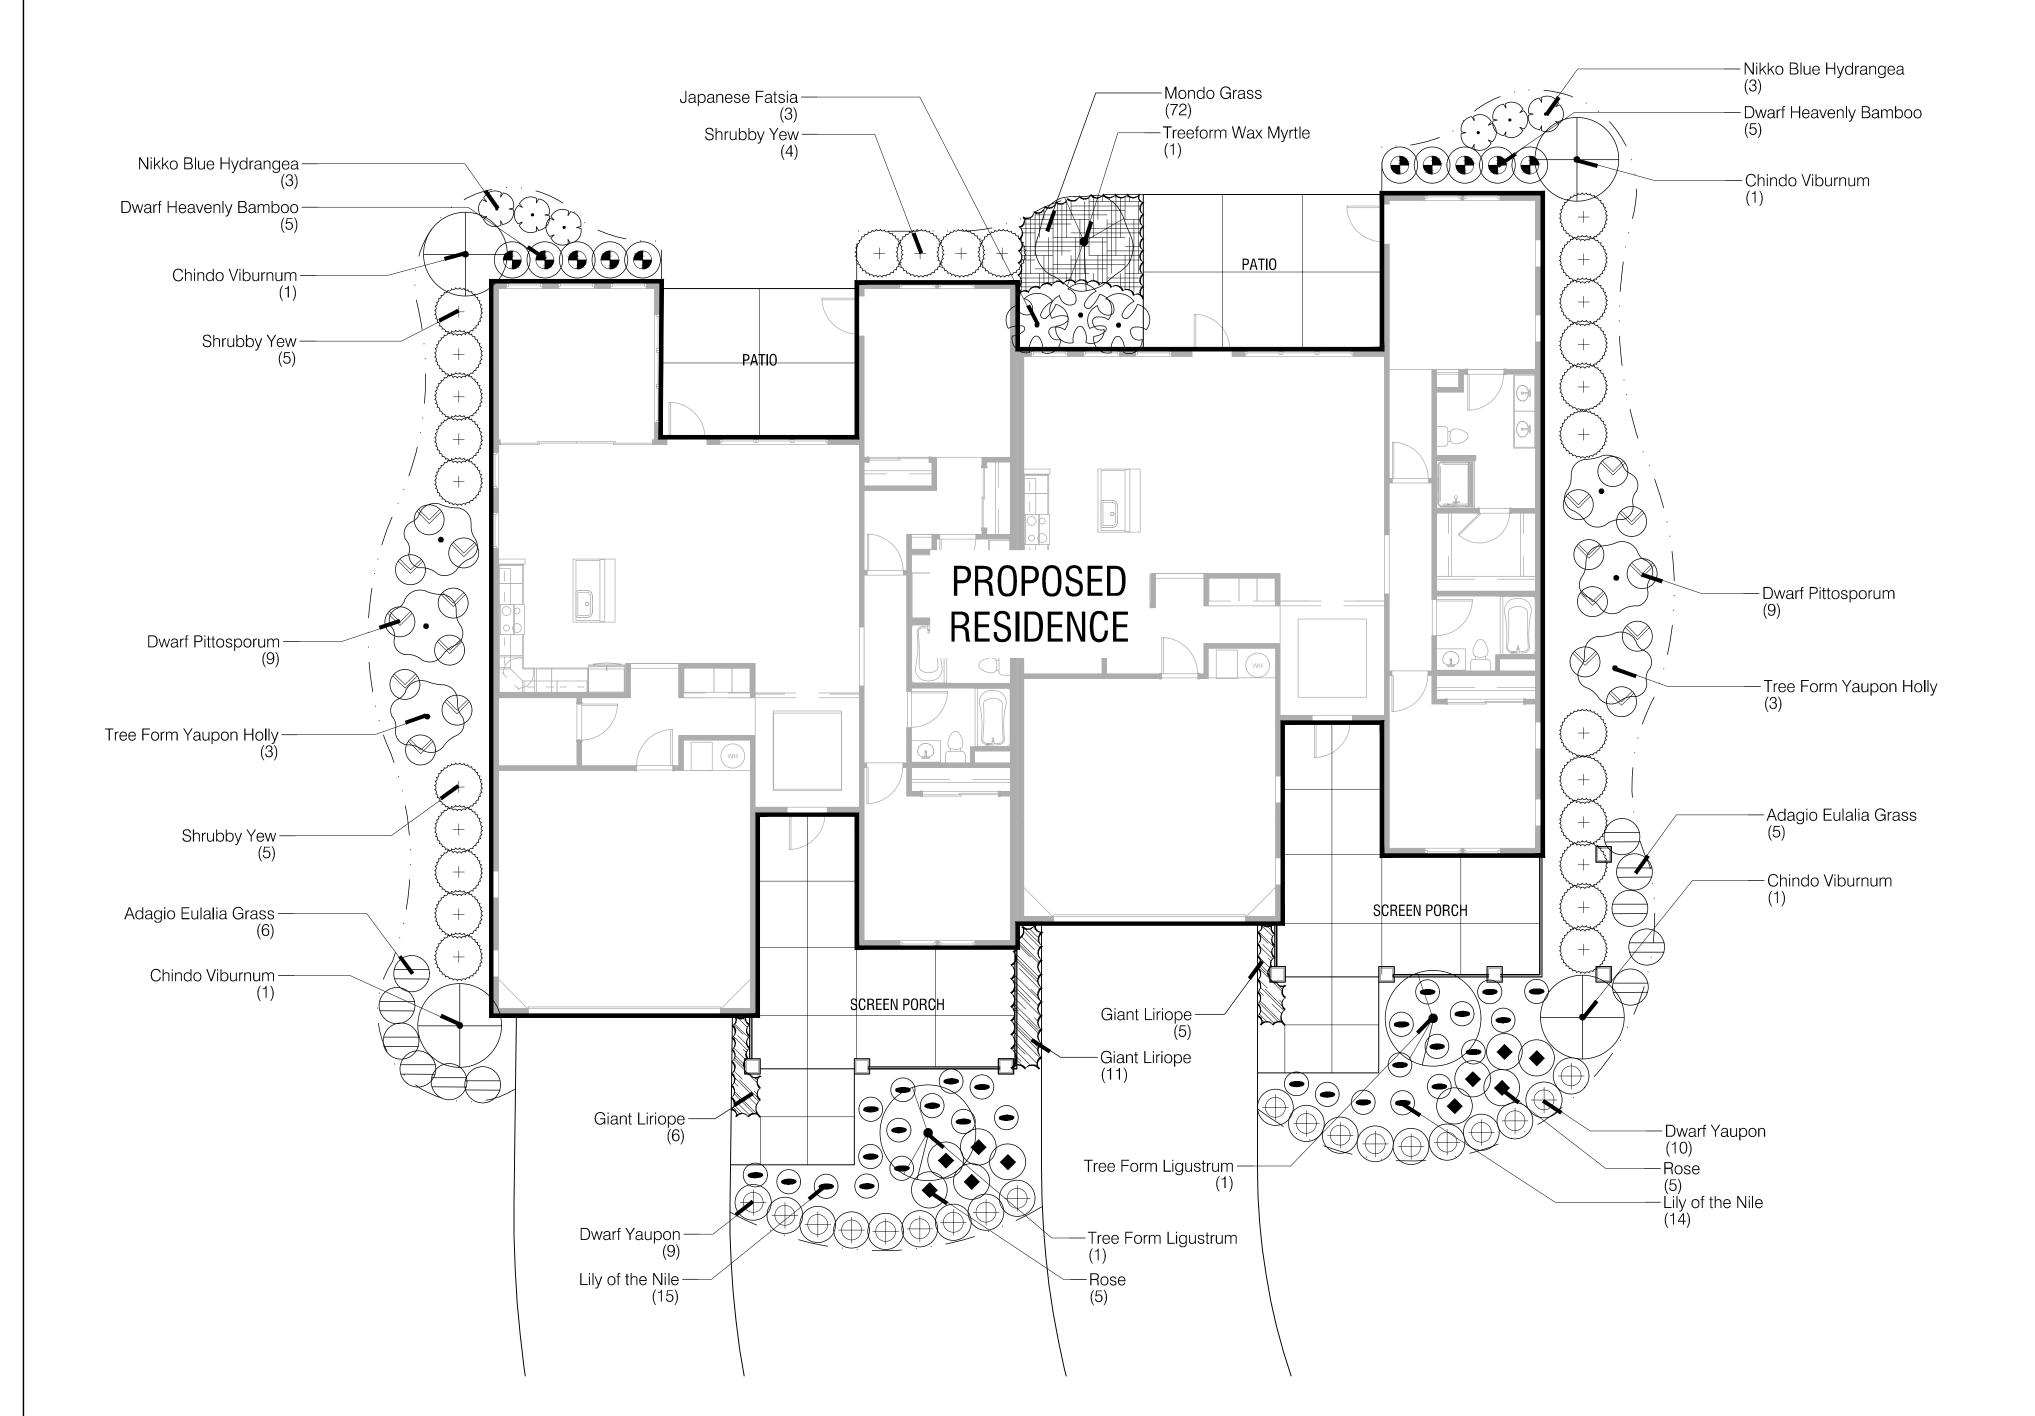

SHRUBS	BOTANICAL / COMMON NAME	SIZE	RANGE		QT\
	Agapanthus africanus / Lily of the Nile	1 gal	12-15" HT		28
\\\\\\\\\\\\\\\\\\\\\\\\\\\\\\\\\\\\\\	Fatsia japonica / Japanese Fatsia	7 gal	24-30" HT		3
	Hydrangea m. `Nikko Blue` / Nikko Blue Hydrangea	3 gal	18-24" HT		6
•	llex vomitoria / Tree Form Yaupon Holly	B&B	7-8` HT		6
	llex vomitoria `Nana` / Dwarf Yaupon	3 gal	15-18" HT		19
	Ligustrum japonicum / Tree Form Ligustrum	B&B	6-8` HT		2
	Miscanthus s. `Adagio` / Adagio Eulalia Grass	3 gal	18-24" HT		11
	Myrica cerifera / Treeform Wax Myrtle	B&B	6-8` HT		1
<b>(4)</b>	Nandina domestica `Harbour Dwarf` / Dwarf Heavenly Bamboo	7 gal	18-24" HT		10
	Pittosporum tobira `Wheeler`s Dwarf` / Dwarf Pittosporum	3 gal	12-15" HT		18
(+)	Podocarpus macrophyllus maki / Shrubby Yew	7 gal	3-4` HT		26
•	Rosa x `Knockout` TM / Rose	3 gal	18-24" HT		10
	Viburnum a. `Chindo` / Chindo Viburnum	15 gal	3-4` HT		4
GROUND COVERS	BOTANICAL / COMMON NAME	SIZE	RANGE	SPACING	QT
	Liriope gigantea / Giant Liriope	1 GAL	12-18" HT	18" o.c.	22
	Ophiopogon japonicus / Mondo Grass	1 gal	6" HT.	12" o.c.	72

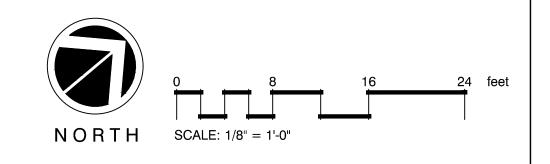

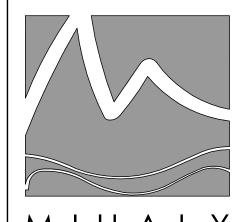

MIHAL Y

PLANNING + LANDSCAPE ARCHITECTURE
330 MILITARY CUTOFF RD., Suite A3
Wilmington, NC 28405 910.392.4355



Revisions

2020-08-19: Revise per N.H.C. comments

CLIENT
CORNELIA NIXON DAVIS INC.
1011 PORTERS NECK ROAD
WILMINGTON, NC

PROJECT

THE DAVIS COMMUNITY - PHASE 1

1011 PORTERS NECK ROAD
WILMINGTON, NC
LANDSCAPE PLAN

PHASE 1 PERMIT SET

Date: 2020-07-22
Phase: 1
Job Number: 101-650

Designed by: MLD
Drawn by: MAS

Checked by:
Sheet Title:


COTTAGE -ENLARGEMENT PLAN

JWM

Sheet Number:

L12


of 7 sheets

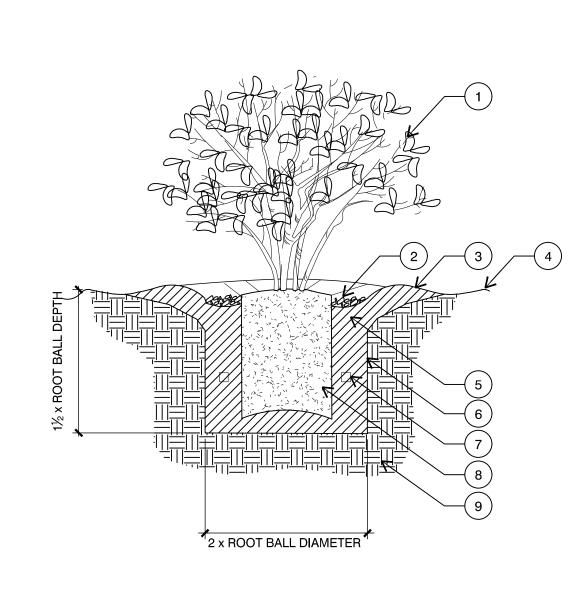

## LEGEND

- 1. SHRUB
- 2. 3" LAYER OF MULCH
- 3. 3" WATER BASIN
- 4. FINISH GRADE
- 5. TOPSOIL & NATIVE BACKFILL
- 6. SCARIFY EDGE OF PIT
- 7. FERTILIZER TABLETS REFER TO SCHEDULE FOR QUANTITY
- 8. ROOT BALL
- 9. NATIVE SUBGRADE

- SCARIFY ROOT BALLS OF PLANTS WITH CIRCLING ROOTS. - HEAVILY ROOT BOUND SHRUBS WILL NOT BE ACCEPTED

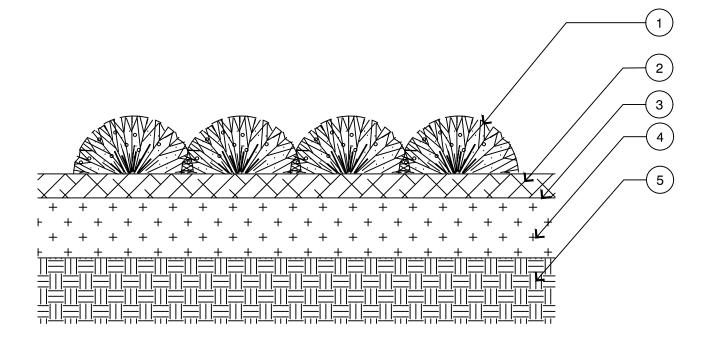


## **LEGEND**

- GROUND COVER PLANT- REFER TO PLANTING PLAN FOR SPACING INFORMATION
- 2. MULCH REFER TO PLANTING SPECIFICATIONS FOR TYPE AND
- 3. FINISH GRADE
- 4. TOPSOIL AND NATIVE BACKFILL REFER TO PLANTING SPECIFICATIONS FOR TYPE AND DEPTH
- 5. COMPACTED SUBGRADE

4 SHRUB PLANTING

# 2 GROUNDCOVER

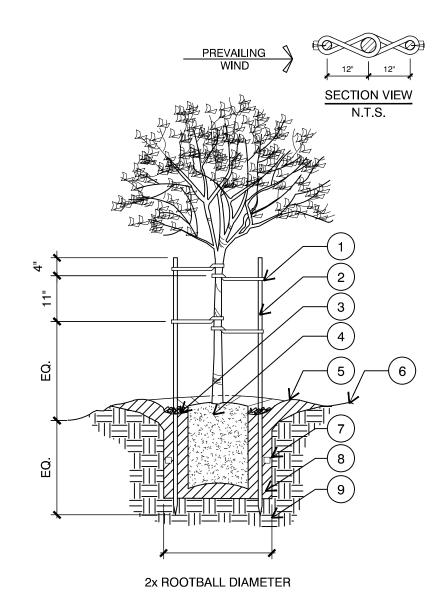

# LEGEND

- 1. 24" CORDED BLACK RUBBER TREE TIE. LOOP AT TRUNK AND NAIL TO STAKE
- 2.  $2\frac{1}{2}$ " DIA. x 12' LONG TREATED LODGEPOLE PINE STAKE
- 3. 3" LAYER OF MULCH
- 4. ROOT BALL
- 5. 3" WATER BASIN
- 6. FINISH GRADE
- 7. FERTILIZER TABLET
- 8. TOPSOIL & NATIVE BACKFILL MIXTURE
- 9. NATIVE SUBGRADE

- SCARIFY ROOT BALLS OF PLANTS WITH
- CIRCLING ROOTS.
- HEAVILY ROOT BOUND SHRUBS WILL NOT BE ACCEPTED

EDGE OF PLANTING AREA


## LEGEND


1. GROUNDCOVER OR SHRUB PLANTING LOCATION

NOTE:
- D - AS NOTED ON PLANTING SCHEDULE

5 TREE STAKING

3 PLANT SPACING

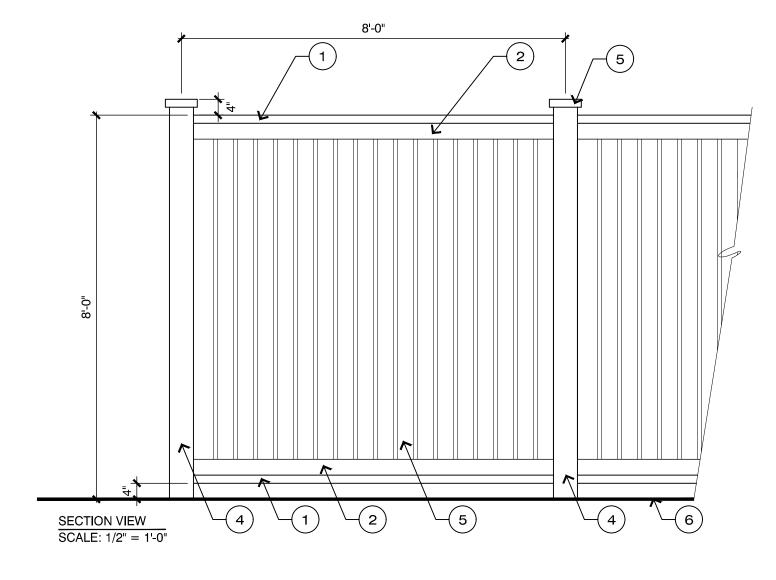

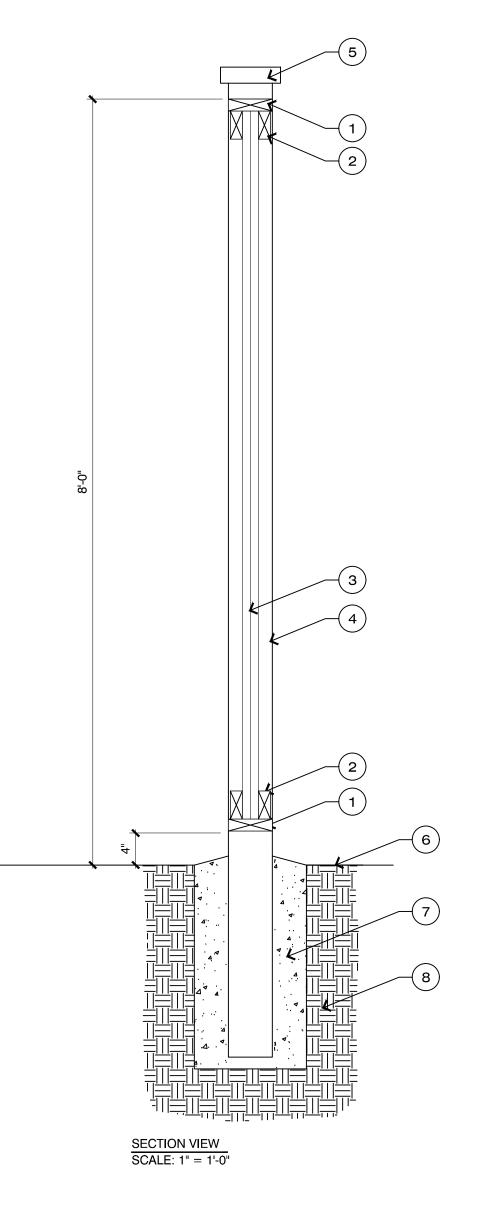

## LEGEND

- 1. 2 x 6 CAP
- 2. 2 x 4 STRINGER
- 3. 1 x 6 VERTICAL BOARDS 1" OVERLAP
- 4. 6 x 6 POSTS AT 8'-0" O.C.
- 5. DECORATIVE POST CAP
- 6. FINISH GRADE
- 7. CONCRETE FOOTING
- 8. COMPACTED SUBGRADE

- ALL LUMBER SHALL BE TREATED ALL LUMBER SHALL BE STAINED
- STAIN TO BE SELECTED
- ALL CONNECTORS, FASTENERS AND OTHER HARDWARE SHALL BE HOT DIPPED GALVANIZED

PHASE 1

2020-07-22 Phase: Job Number:

MLD Designed by: Drawn by: MAS Checked by: JWM

Sheet Title: SITE &

Sheet Number:

1 8'-0" PRIVACY FENCE

330 MILITARY CUTOFF RD., Suite A3 Wilmington, NC 28405 910.392.4355 2020-08-19: Revise per N.H.C.

NIXON DAVIS INC

PERMIT SET

PLANTING DETAILS

of 7 sheets